

Environmental Statement - Volume 2

Hinkley Point C Development Site Figures





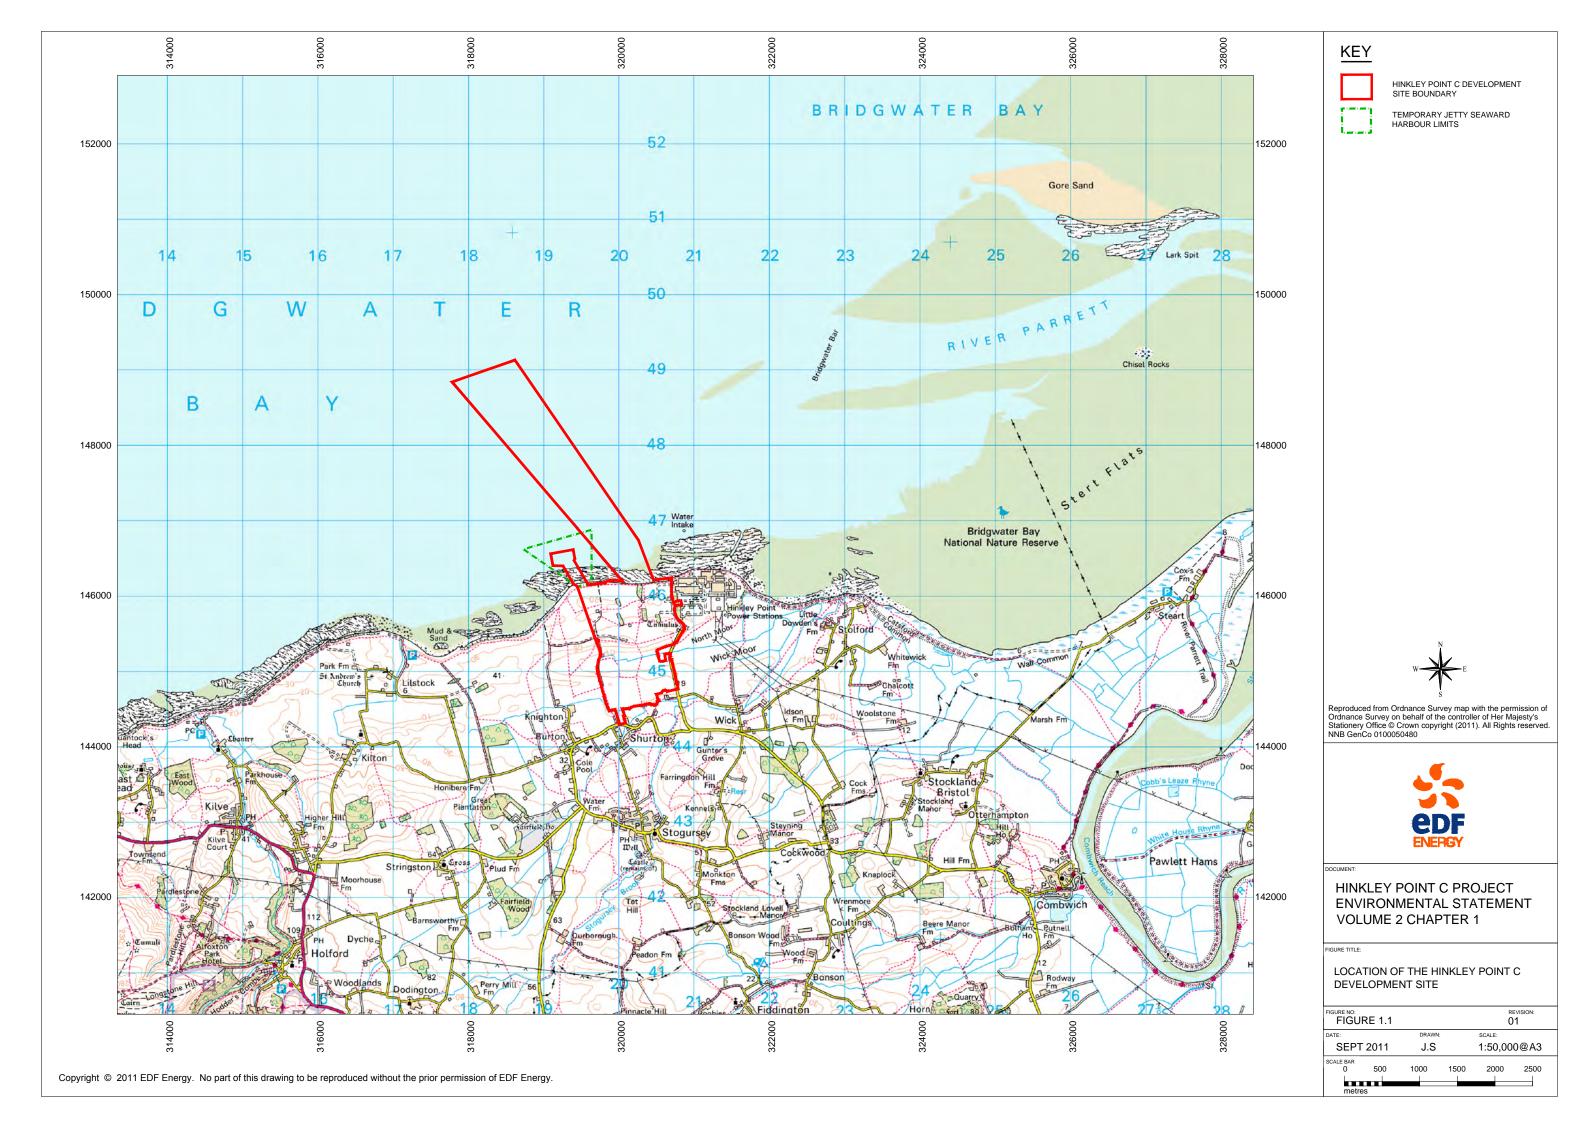
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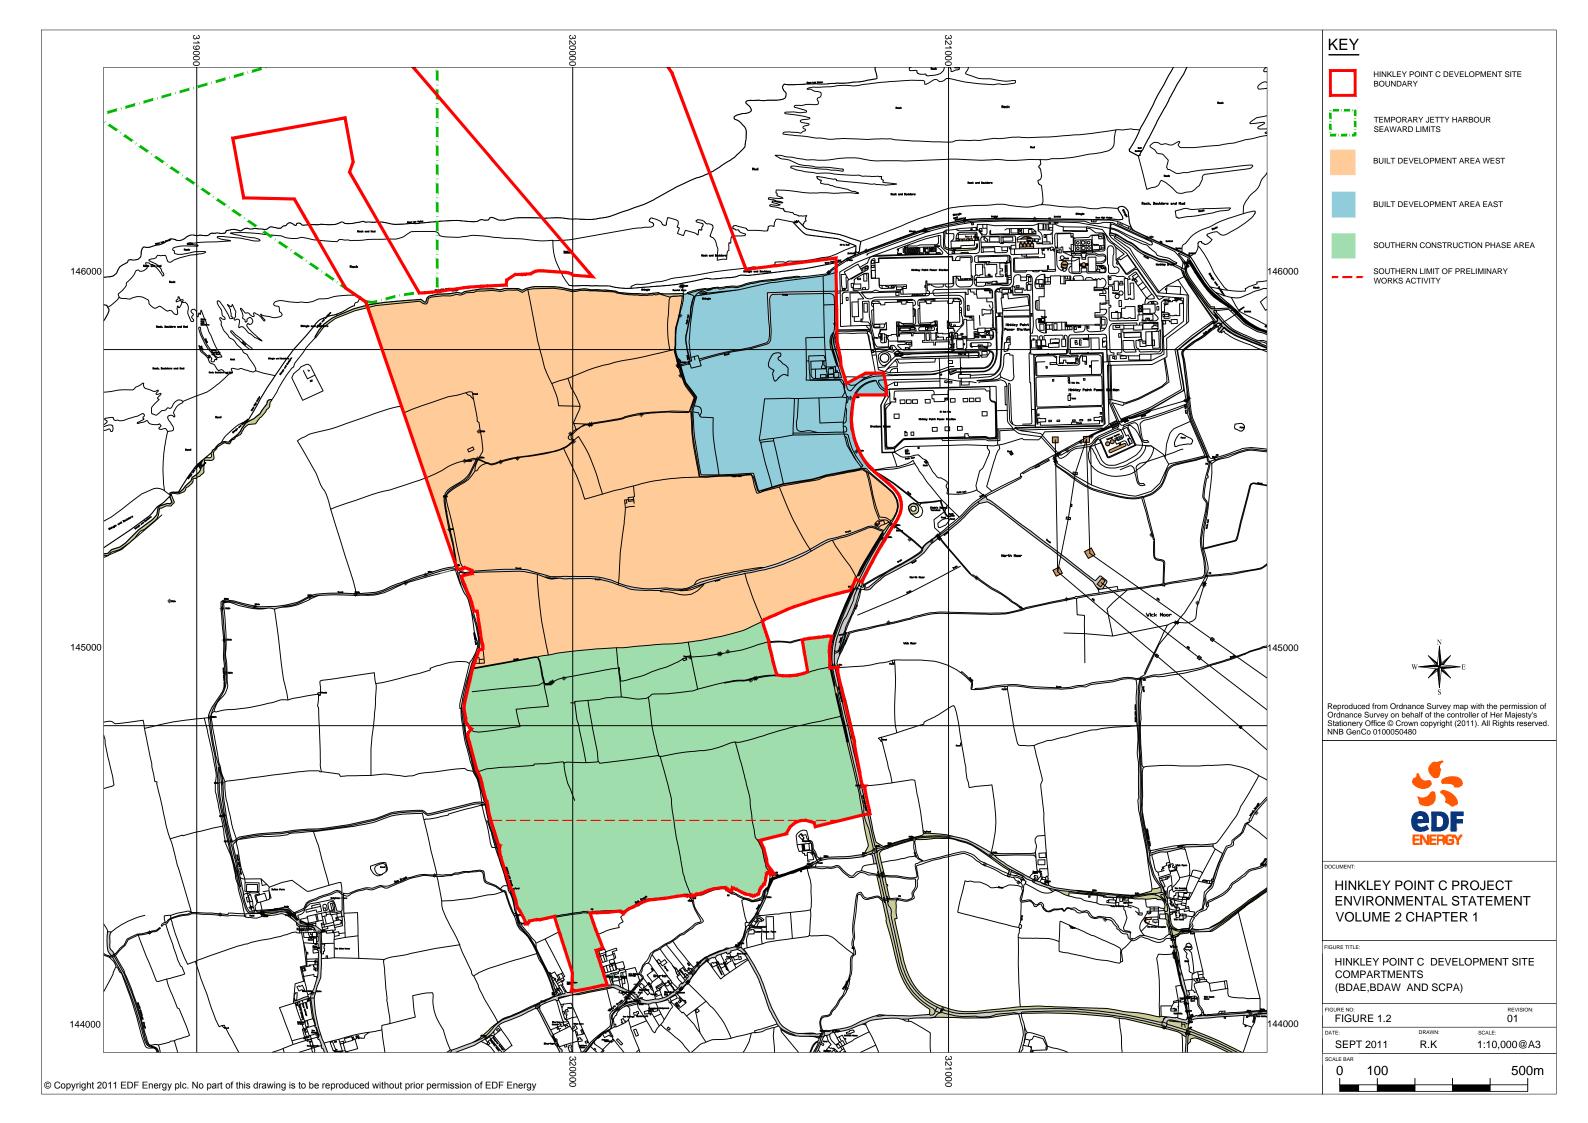
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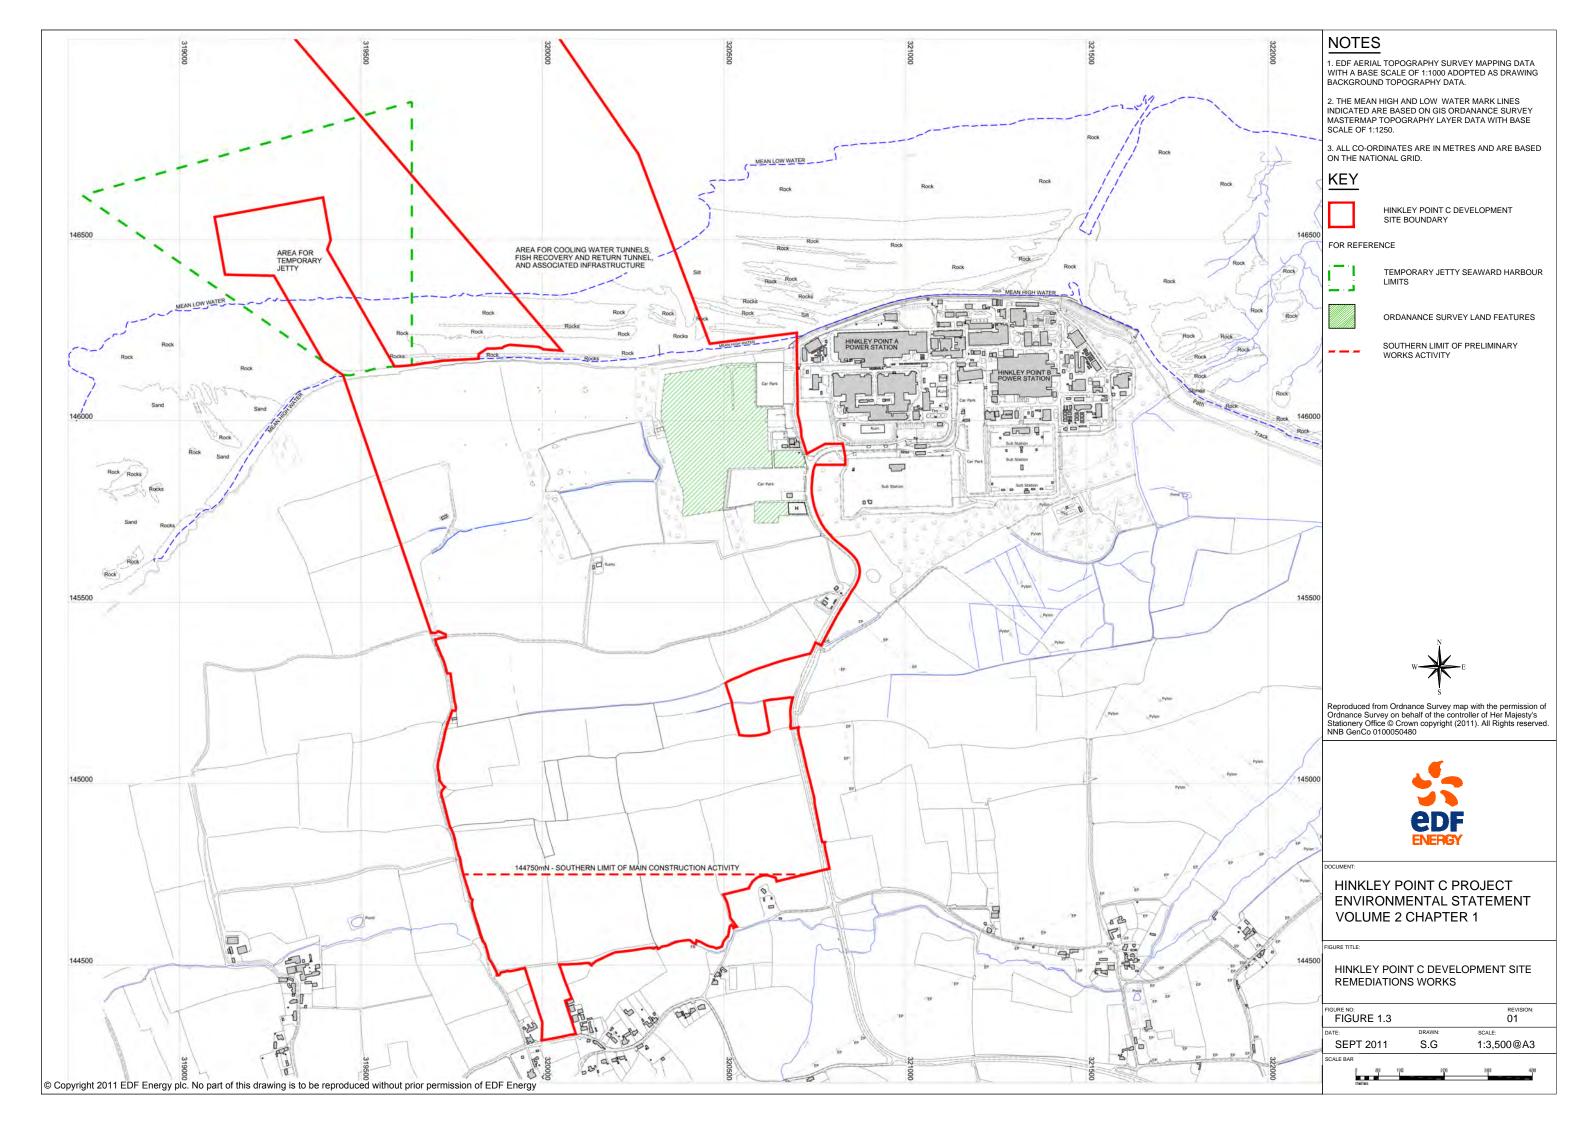
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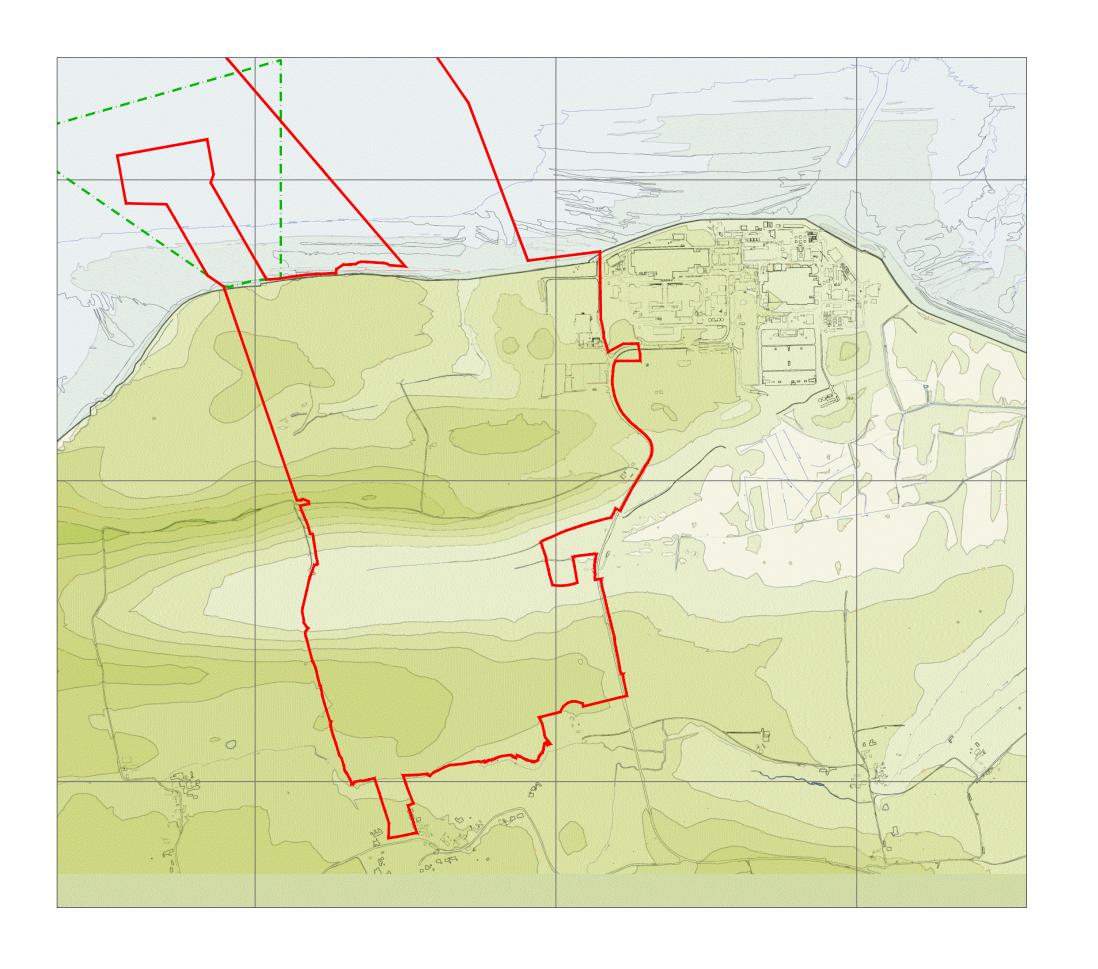
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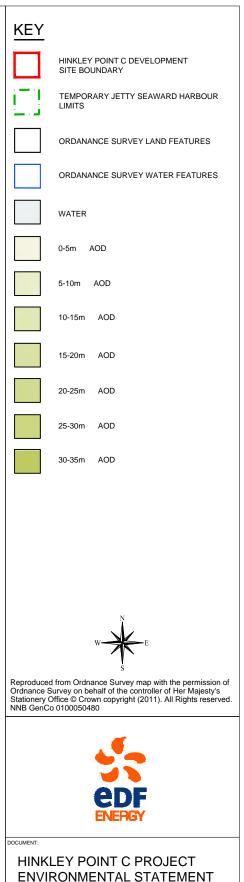
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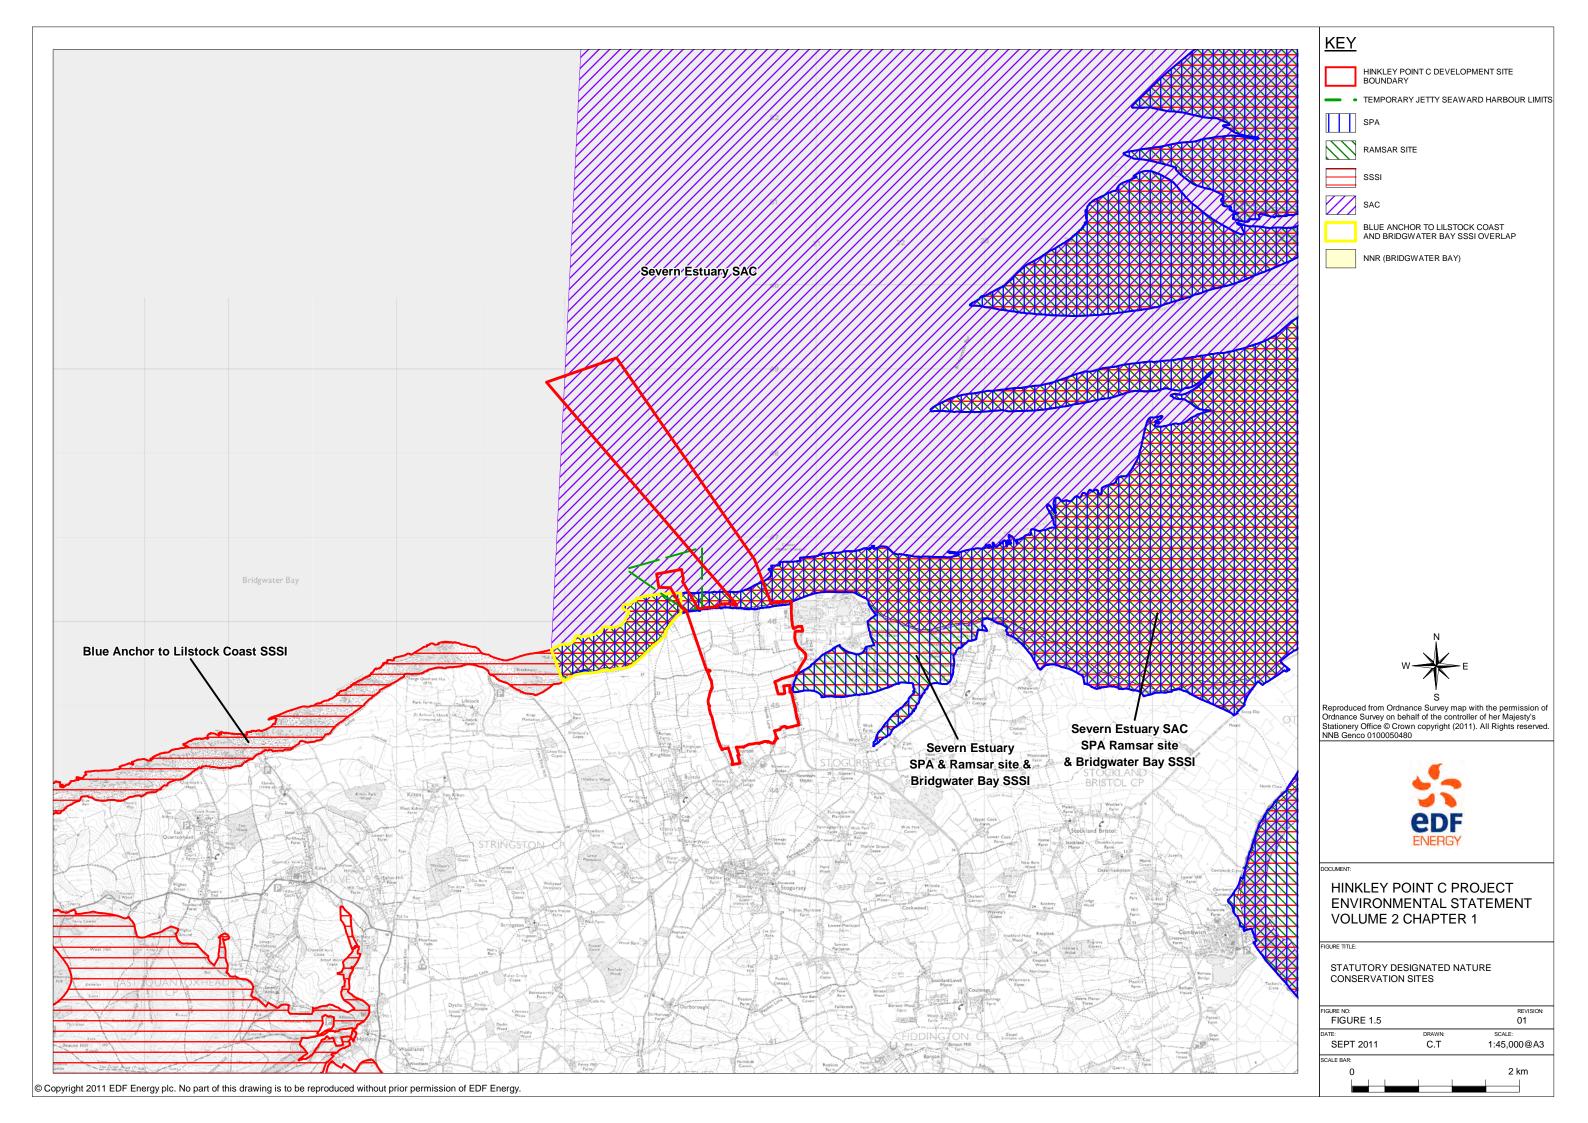





ENVIRONMENTAL STATEMENT VOLUME 2 CHAPTER 1

HINKLEY POINT C DEVELOPMENT SITE EXISTING TOPOGRAPHY


FIGURE 1.4		REVISION: 01
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35 CHEMICAL PRODUCTS STORAGE

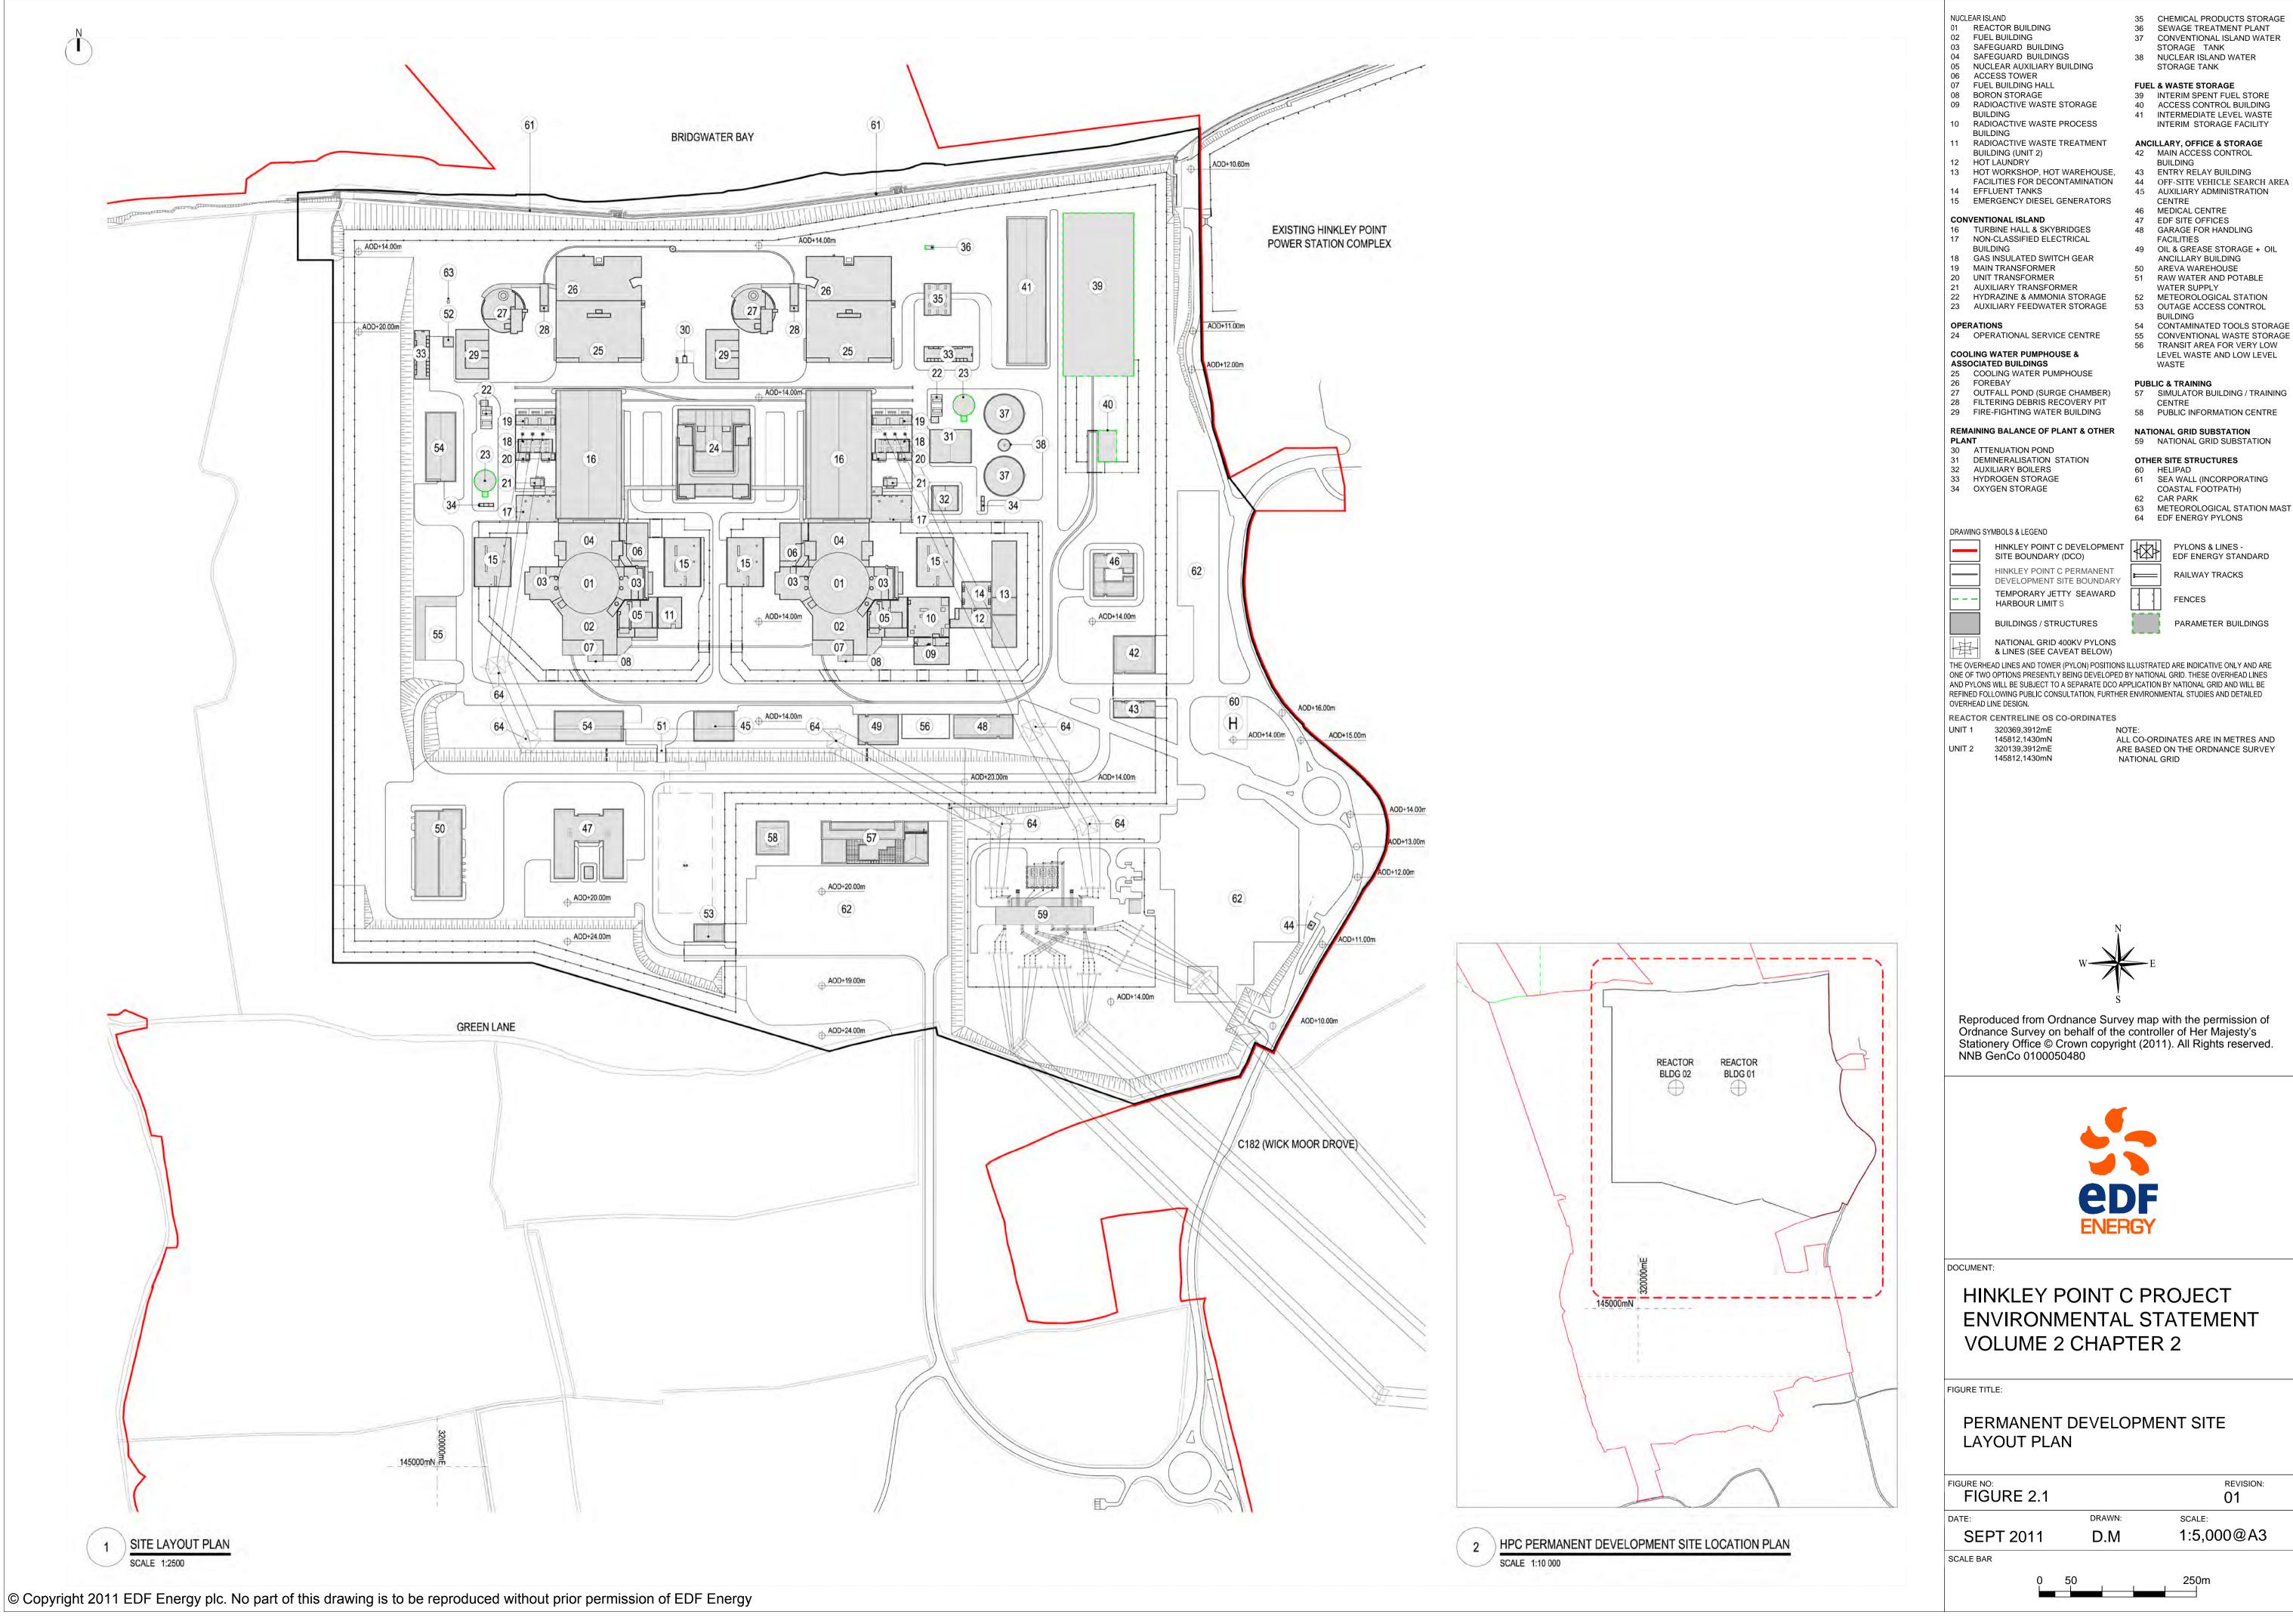63 METEOROLOGICAL STATION MAST






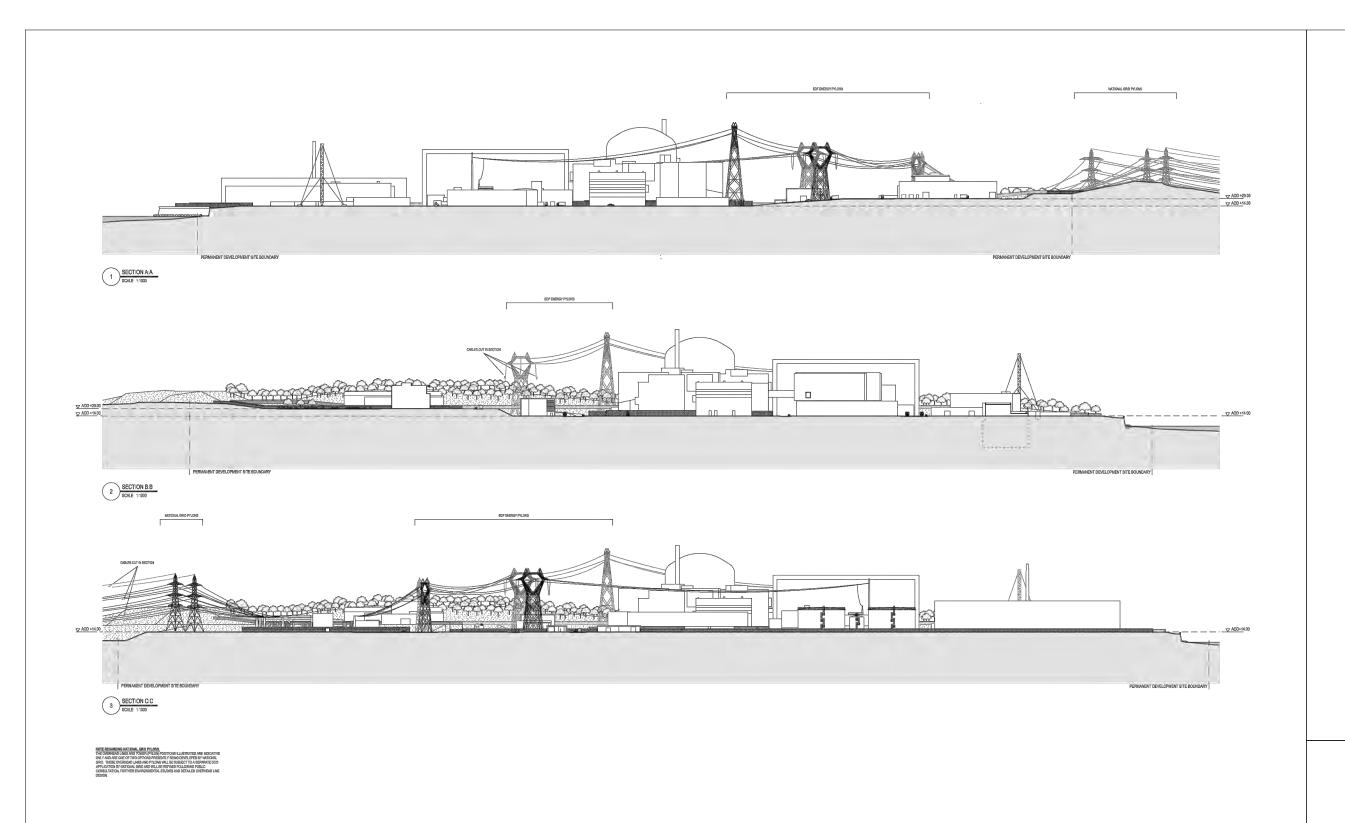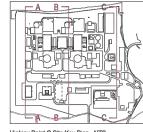HINKLEY POINT C PROJECT ENVIRONMENTAL STATEMENT VOLUME 2 CHAPTER 2

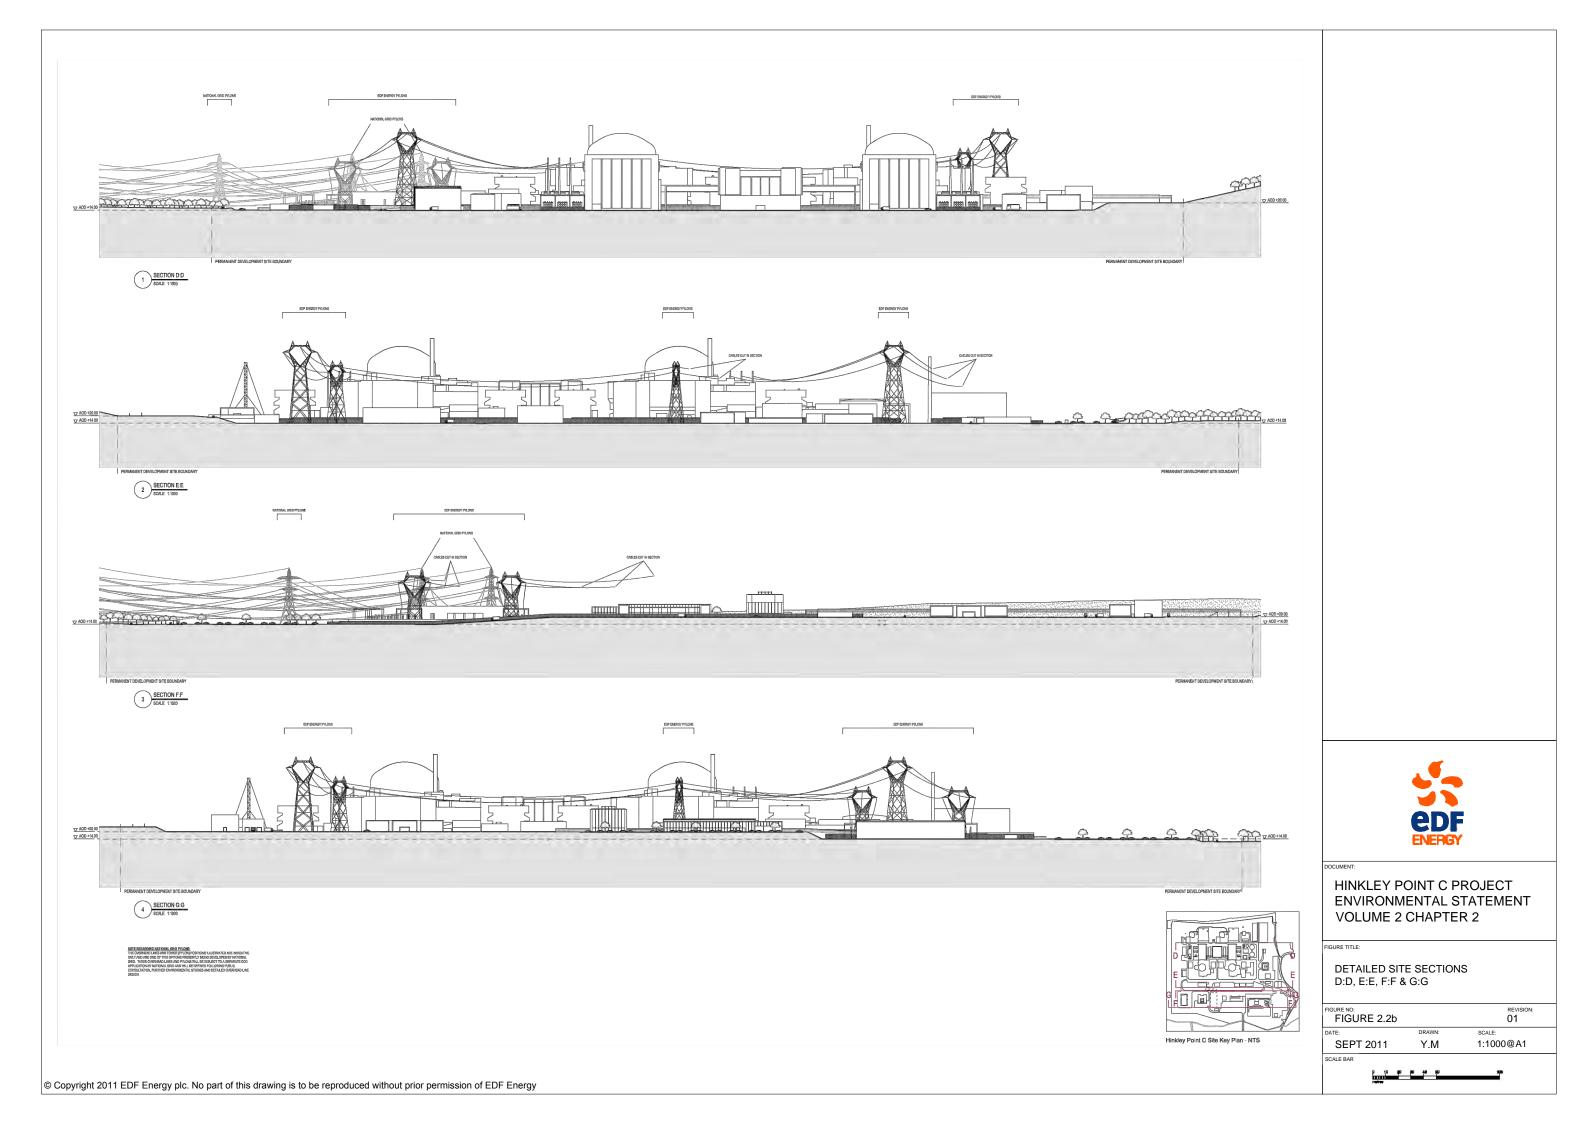
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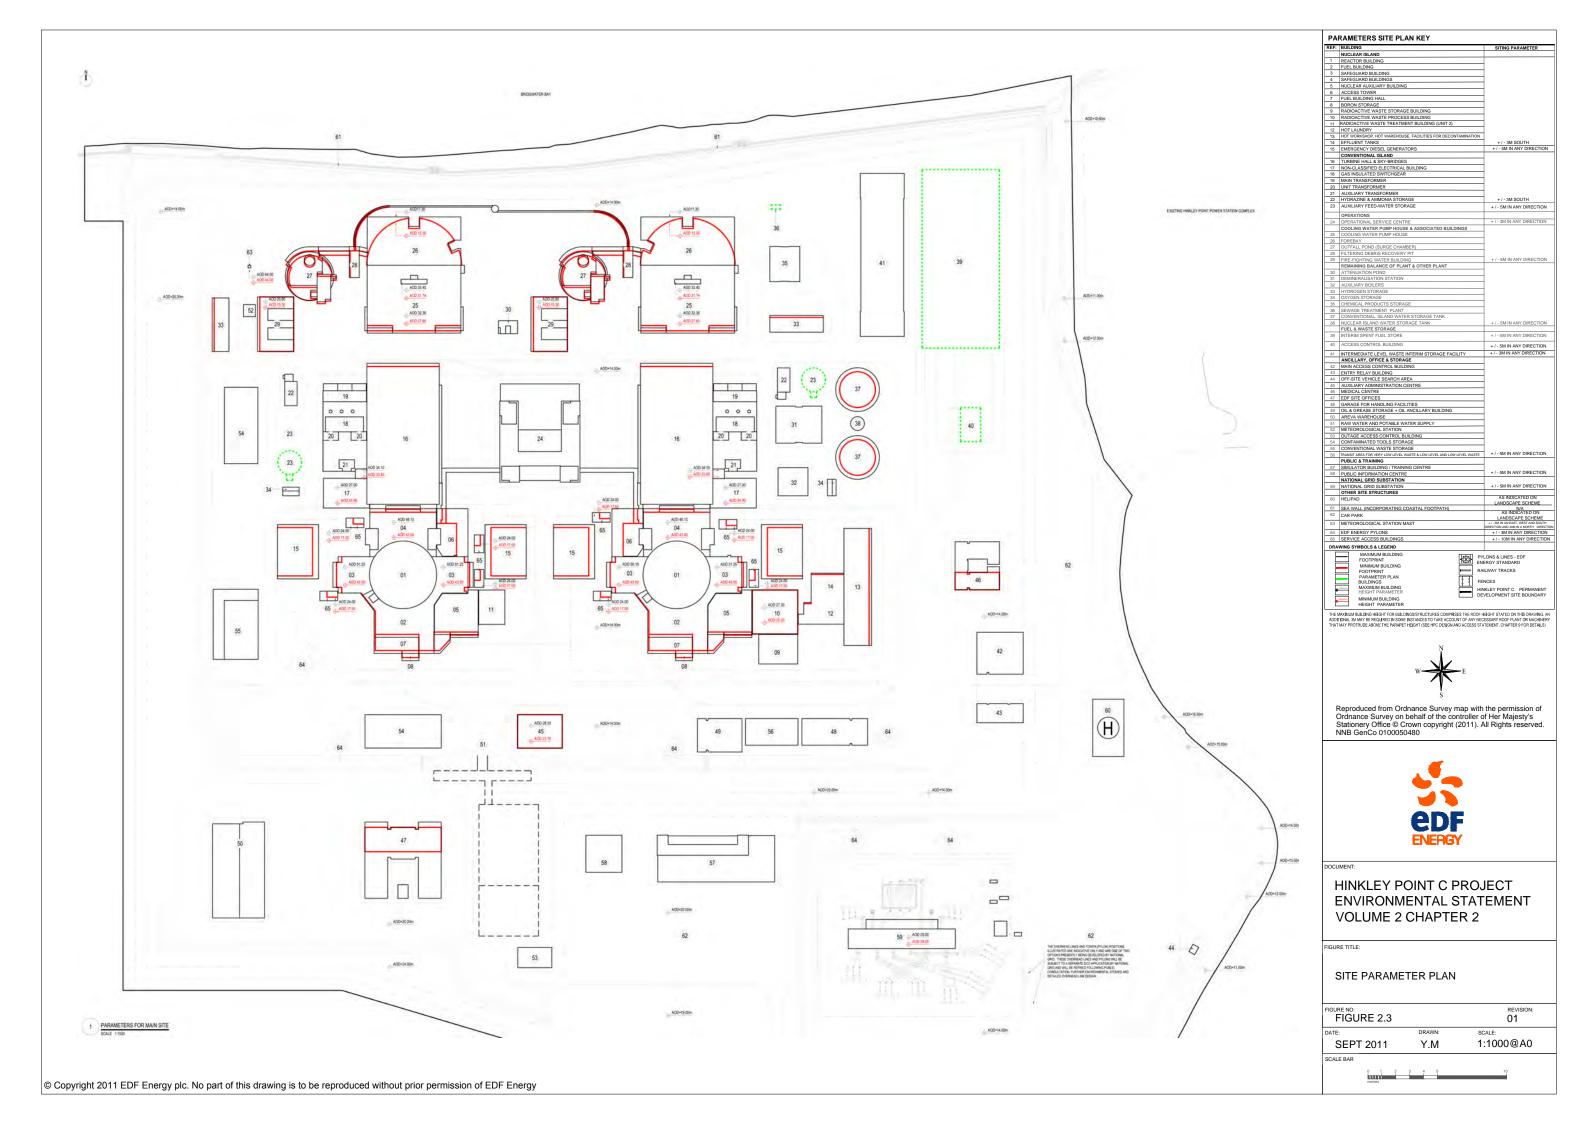
DETAILED SITE SECTIONS A:A, B:B & C:C


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Hinkley Point C Site Key Plan - NTS







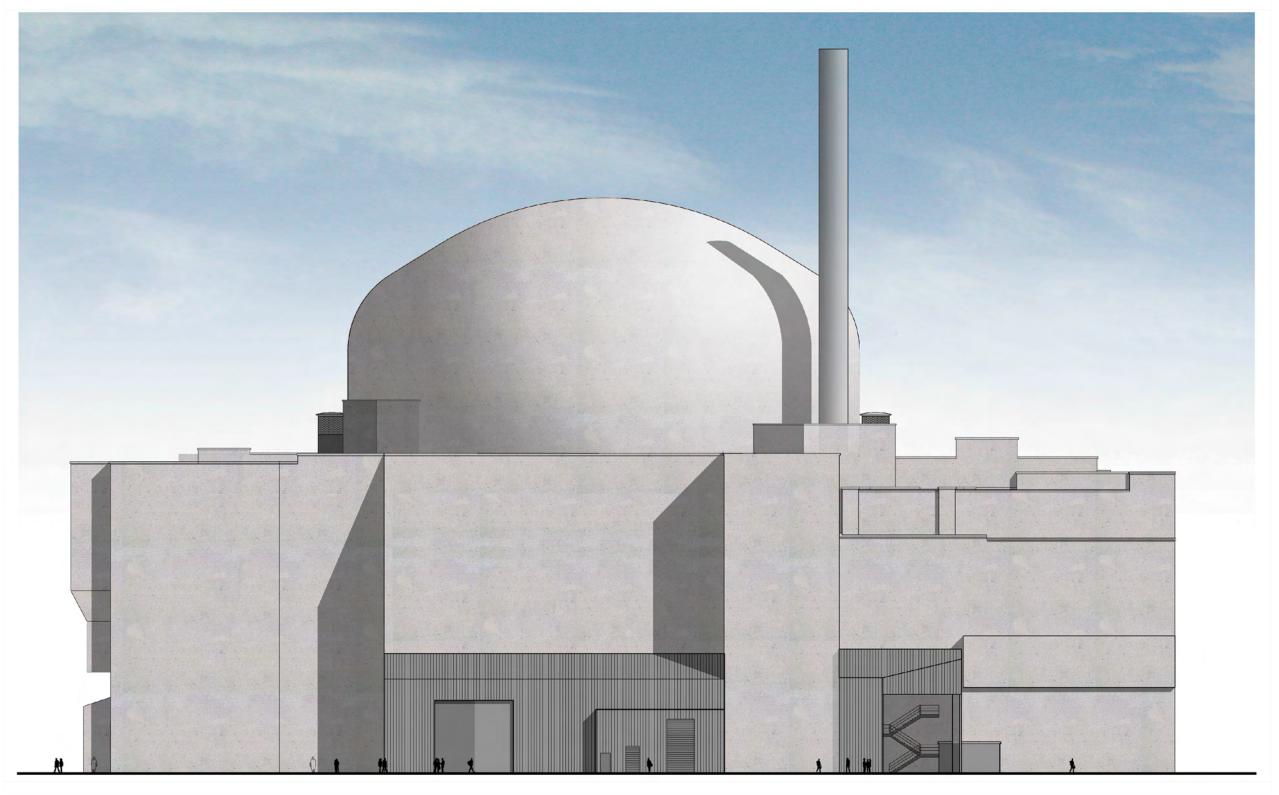


HINKLEY POINT C PROJECT ENVIRONMENTAL STATEMENT VOLUME 2 CHAPTER 2

FIGURE TITLE:

REACTOR BUILDING (UNIT 2) SOUTH ELEVATION

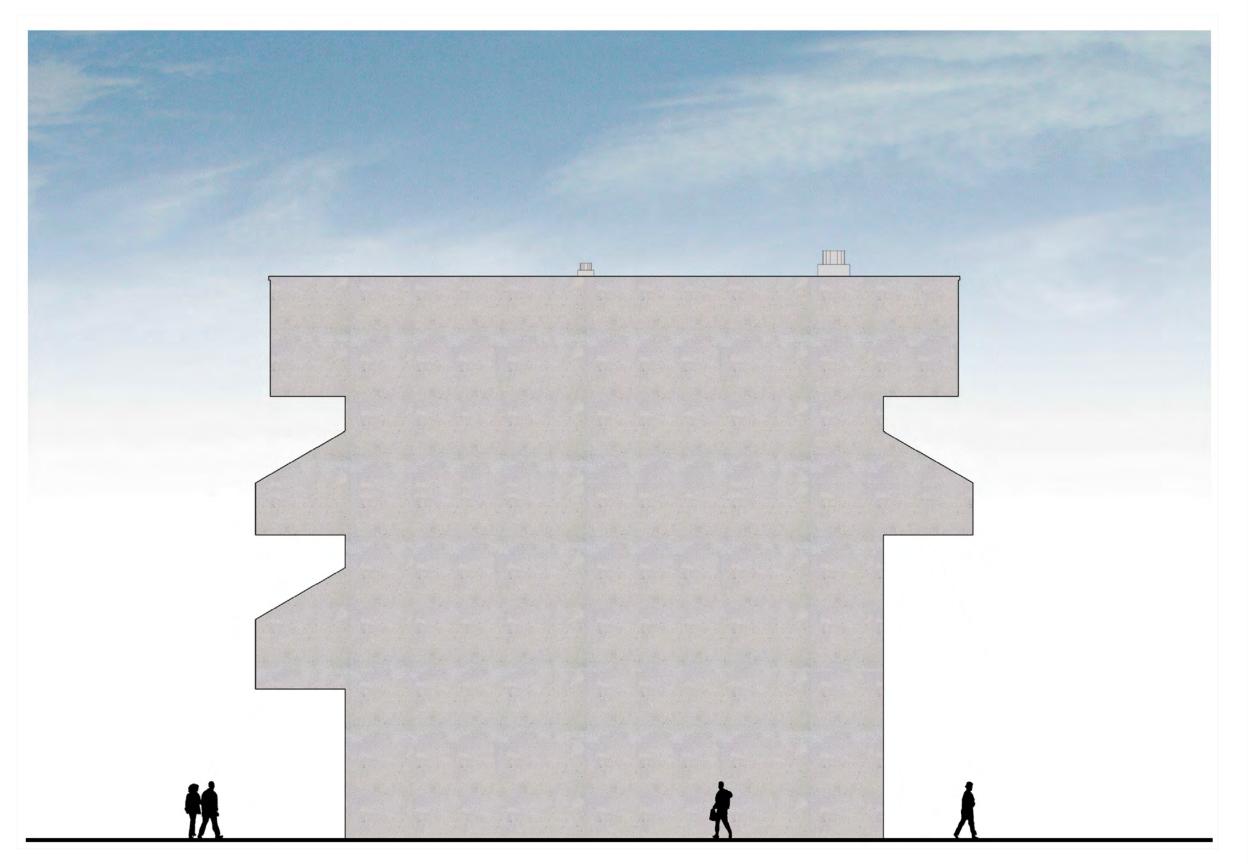FIGURE NO: FIGURE	2.4			01	SION:
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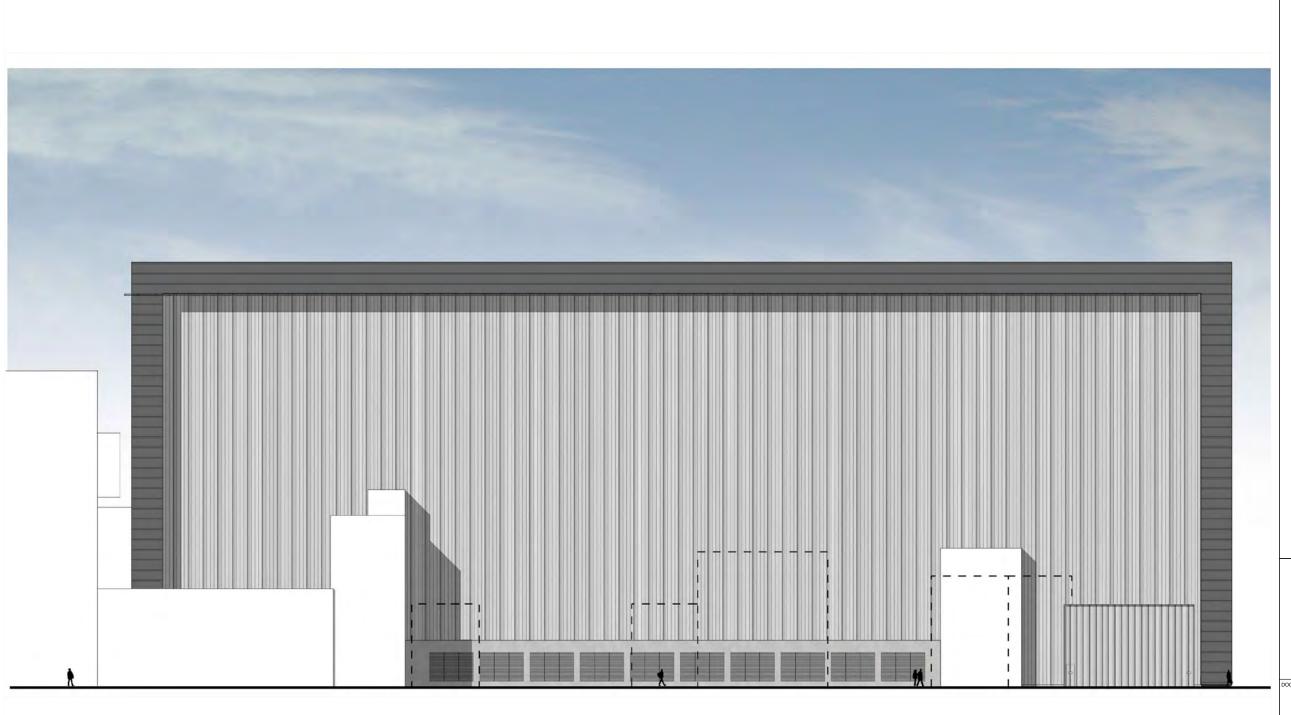


HINKLEY POINT C PROJECT ENVIRONMENTAL STATEMENT VOLUME 2 CHAPTER 2

FIGURE TIT

EMERGENCY DIESEL GENERATOR BUILDING SOUTH ELEVATION

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HINKLEY POINT C PROJECT ENVIRONMENTAL STATEMENT VOLUME 2 CHAPTER 2

FIGURE TITLE

TURBINE HALL EAST ELEVATION (UNIT 1)

FIGURE 2.6			01	iN:
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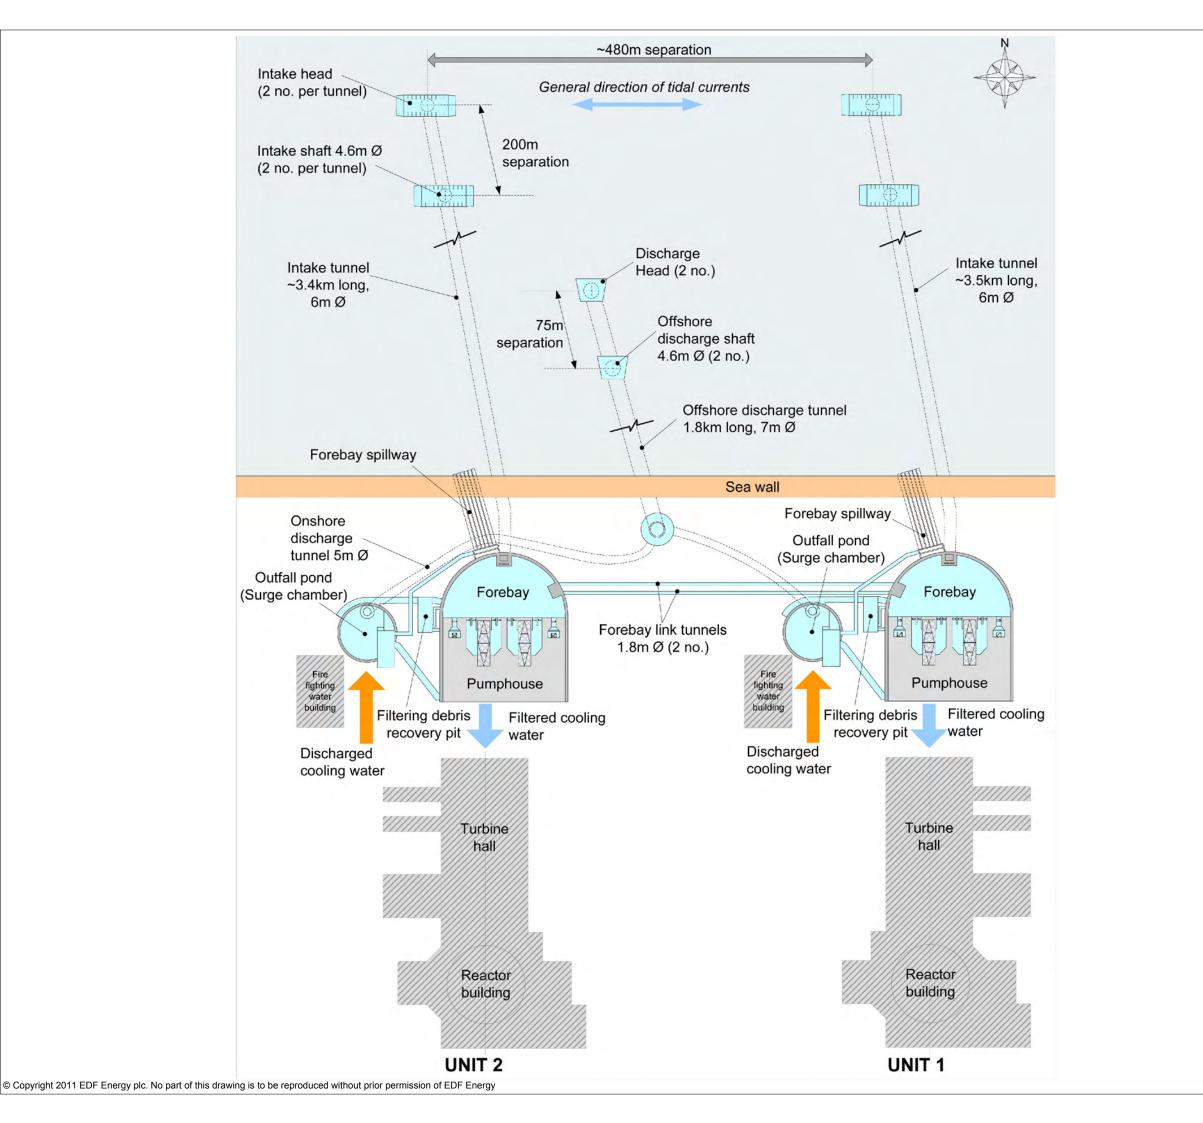


HINKLEY POINT C PROJECT ENVIRONMENTAL STATEMENT VOLUME 2 CHAPTER 2

FIGURE TITLE

TURBINE HALL WEST ELEVATION (UNIT 1)

FIGURE NO: FIGURE 2.7			REVISION: 01
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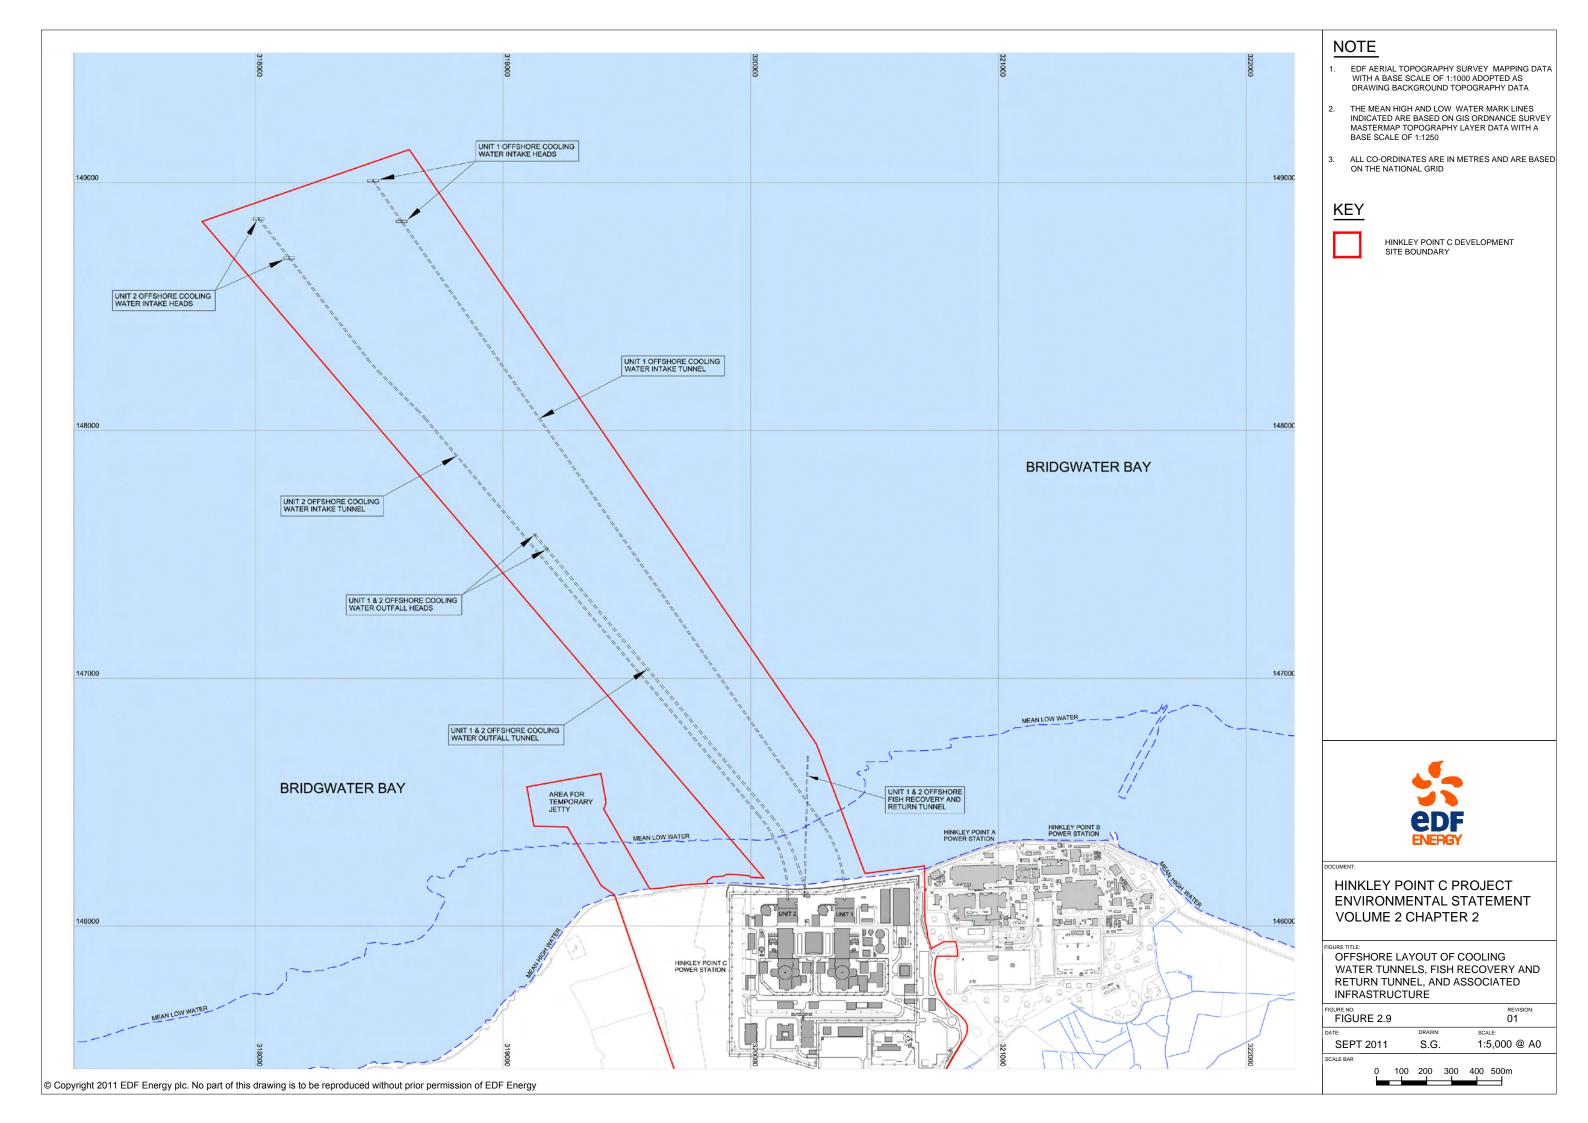


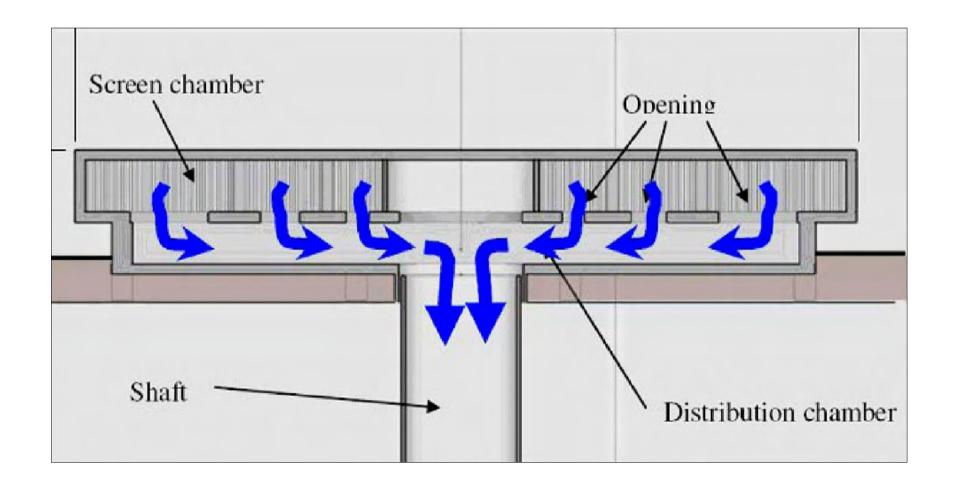
HINKLEY POINT C PROJECT ENVIRONMENTAL STATEMENT VOLUME 2 CHAPTER 2

FIGURE TITLE

SCHEMATIC ILLUSTRATION OF THE COOLING WATER INFRASTRUCTURE

FIGURE 2.8		REVISION: 01
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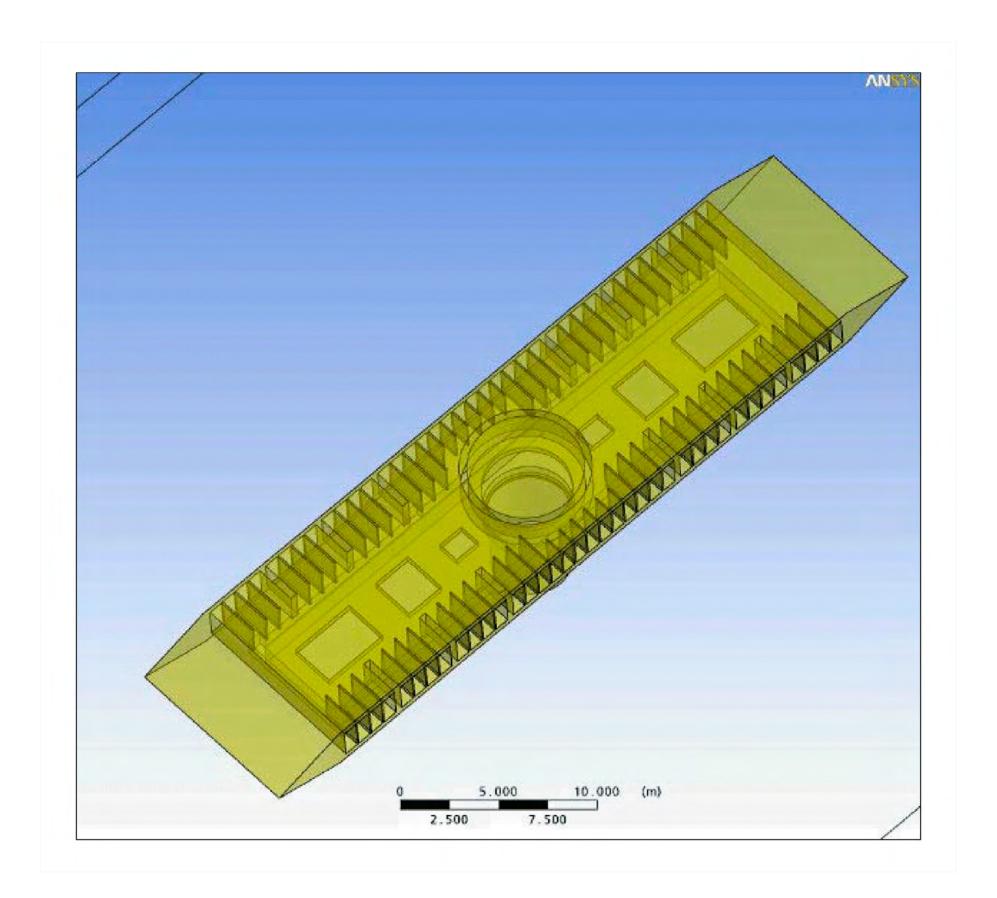


HINKLEY POINT C PROJECT ENVIRONMENTAL STATEMENT VOLUME 2 CHAPTER 2

FIGURE TITLE

ILLUSTRATIVE CROSS-SECTION OF THE INTAKE HEAD

FIGURE NO: FIGURE 2.10		REVISION: 01
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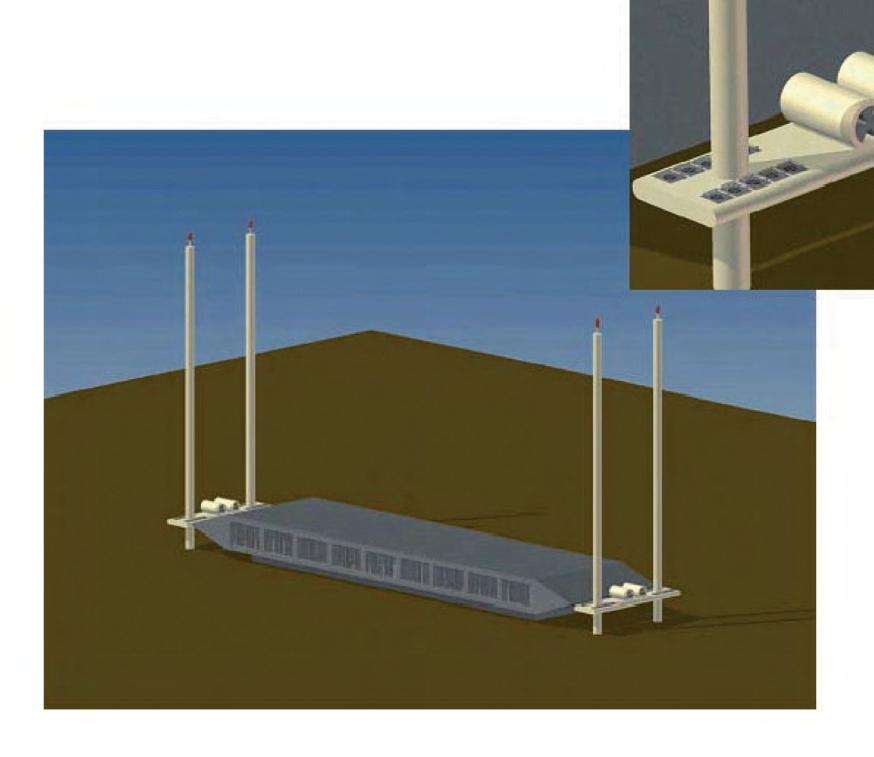


HINKLEY POINT C PROJECT ENVIRONMENTAL STATEMENT VOLUME 2 CHAPTER 2

FIGURE TITLE

ILLUSTRATION OF THE INTAKE HEAD LAYOUT

FIGURE NO: FIGURE 2.11		REVISION:
DATE:	DRAWN:	SCALE:
SEPT 2011	S.C	NOT TO SCALE
SCALE BAR		





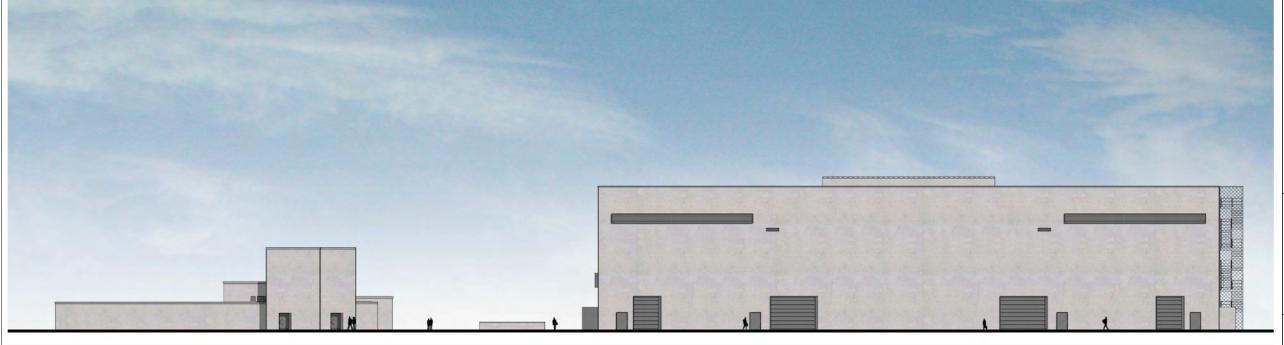
HINKLEY POINT C PROJECT ENVIRONMENTAL STATEMENT VOLUME 2 CHAPTER 2

FIGURE TITL

ILLUSTRATION OF THE INTAKE WITH THE ACOUSTIC FISH DETERRENT SYSTEM

FIGURE 2.12		REVISION: 01
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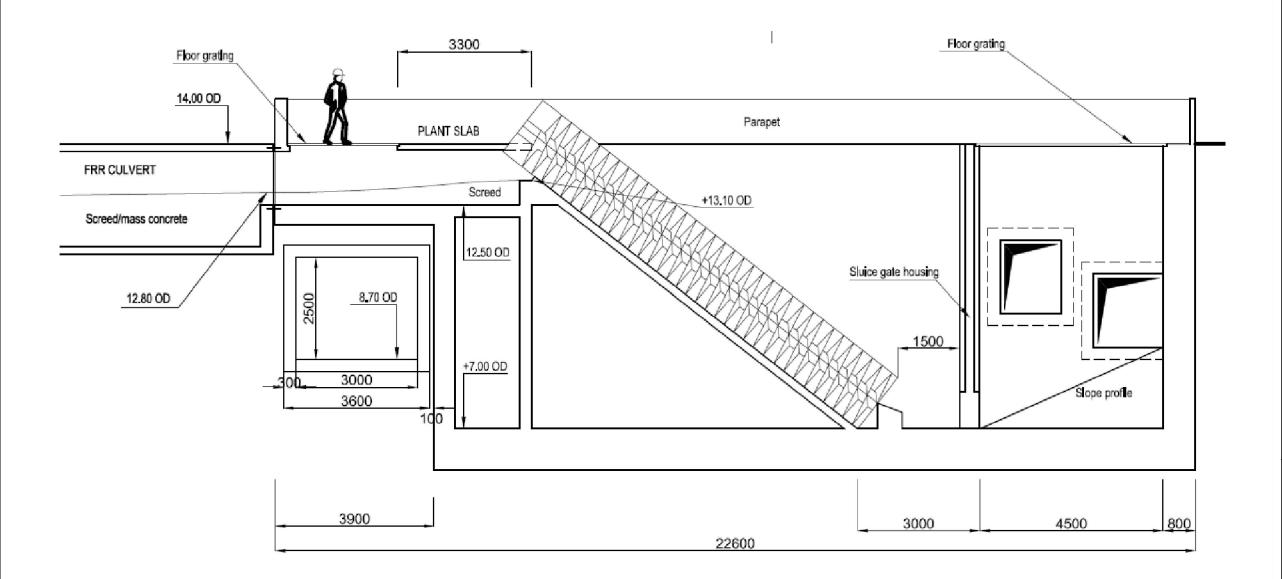




HINKLEY POINT C PROJECT ENVIRONMENTAL STATEMENT VOLUME 2 CHAPTER 2

COOLING WATER PUMPHOUSE, FOREBAY,
OUTFALL POND AND FILTERING DEBRIS
RECOVERY PIT. NORTH AND SOUTH
ELEVATIONS

FIGURE NO: FIGURE 2.1	3		REVISION: 01
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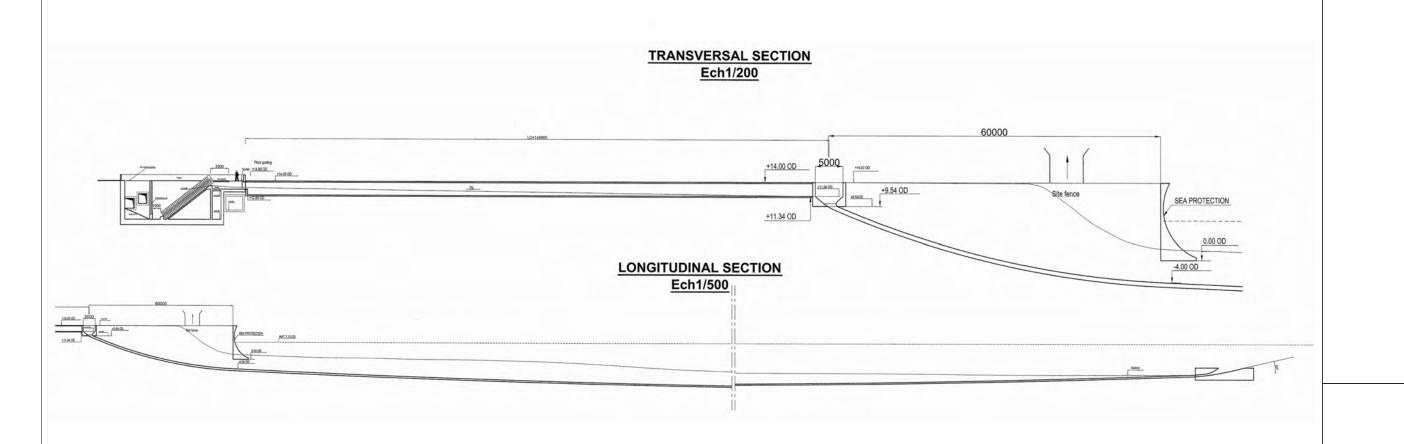


HINKLEY POINT C PROJECT ENVIRONMENTAL STATEMENT VOLUME 2 CHAPTER 2

FIGURE TITLE

ILLUSTRATION OF THE ARCHIMEDEAN SCREW PUMP SYSTEM

FIGURE 2.14	01		
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SEPT 2011	D.M	NOT TO SCALE	
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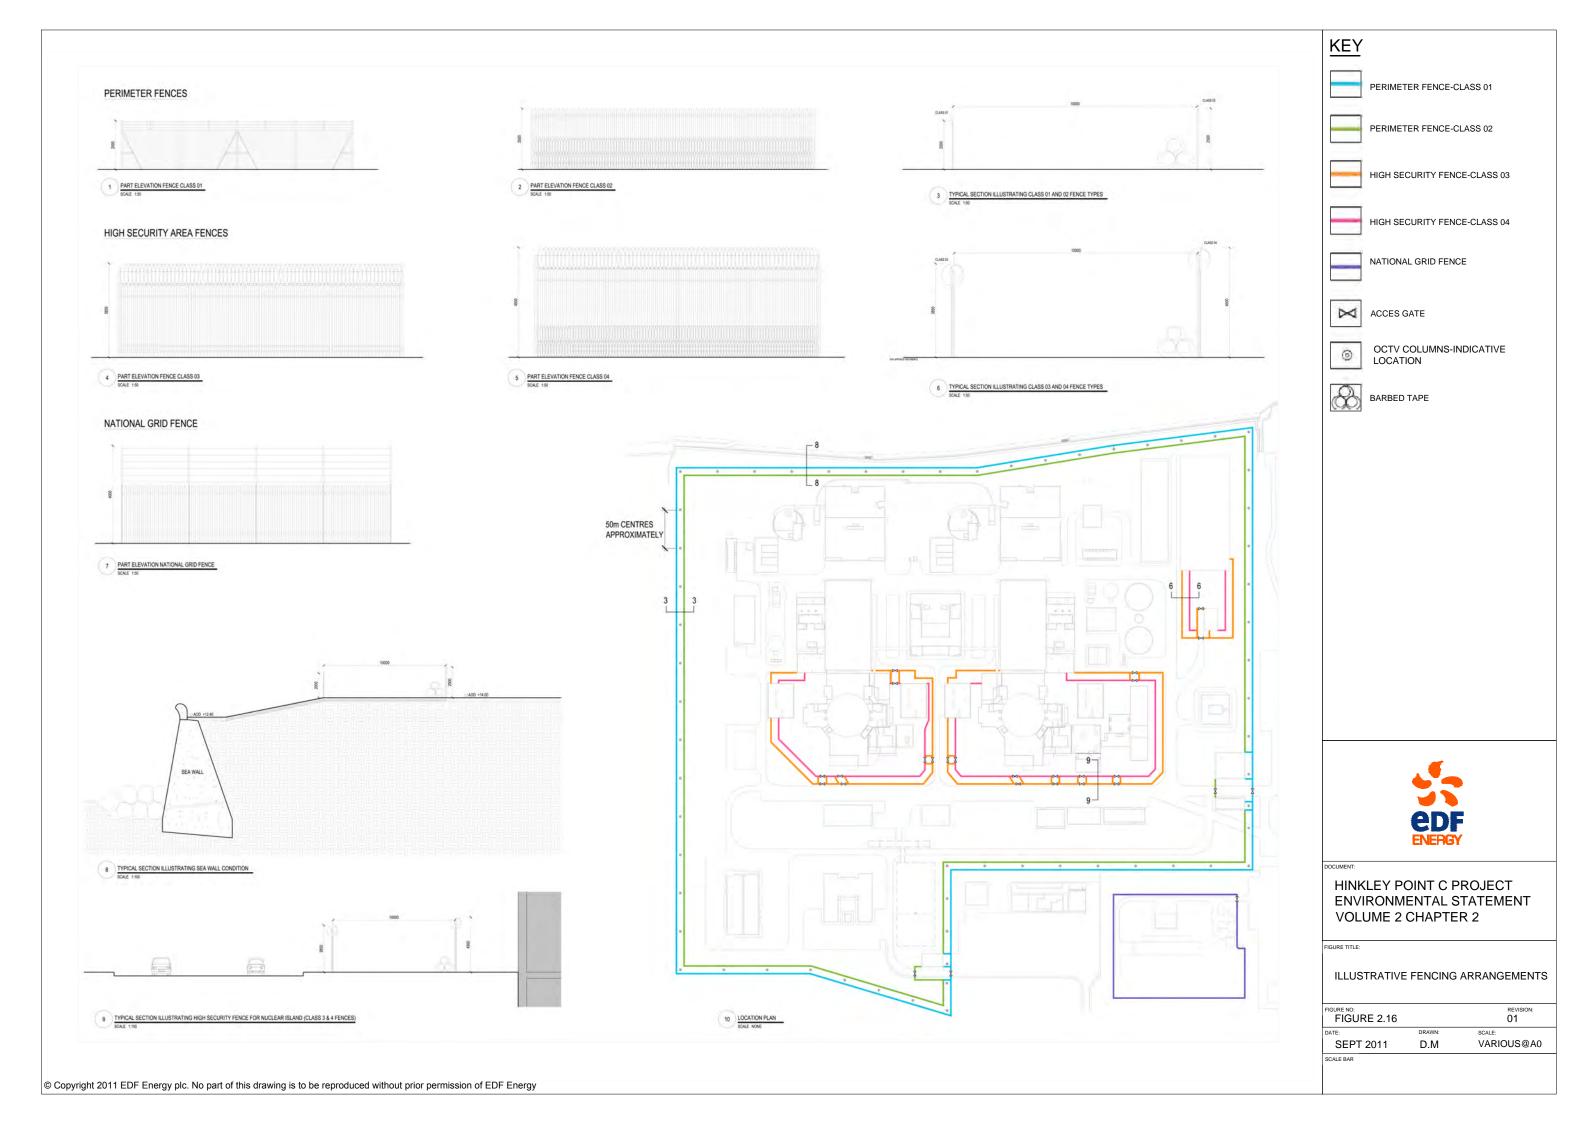


HINKLEY POINT C PROJECT ENVIRONMENTAL STATEMENT VOLUME 2 CHAPTER 2

IGURE TITLE:

INDICATIVE CROSS-SECTIONS OF THE FISH RECOVERY AND RETURN SYSTEM

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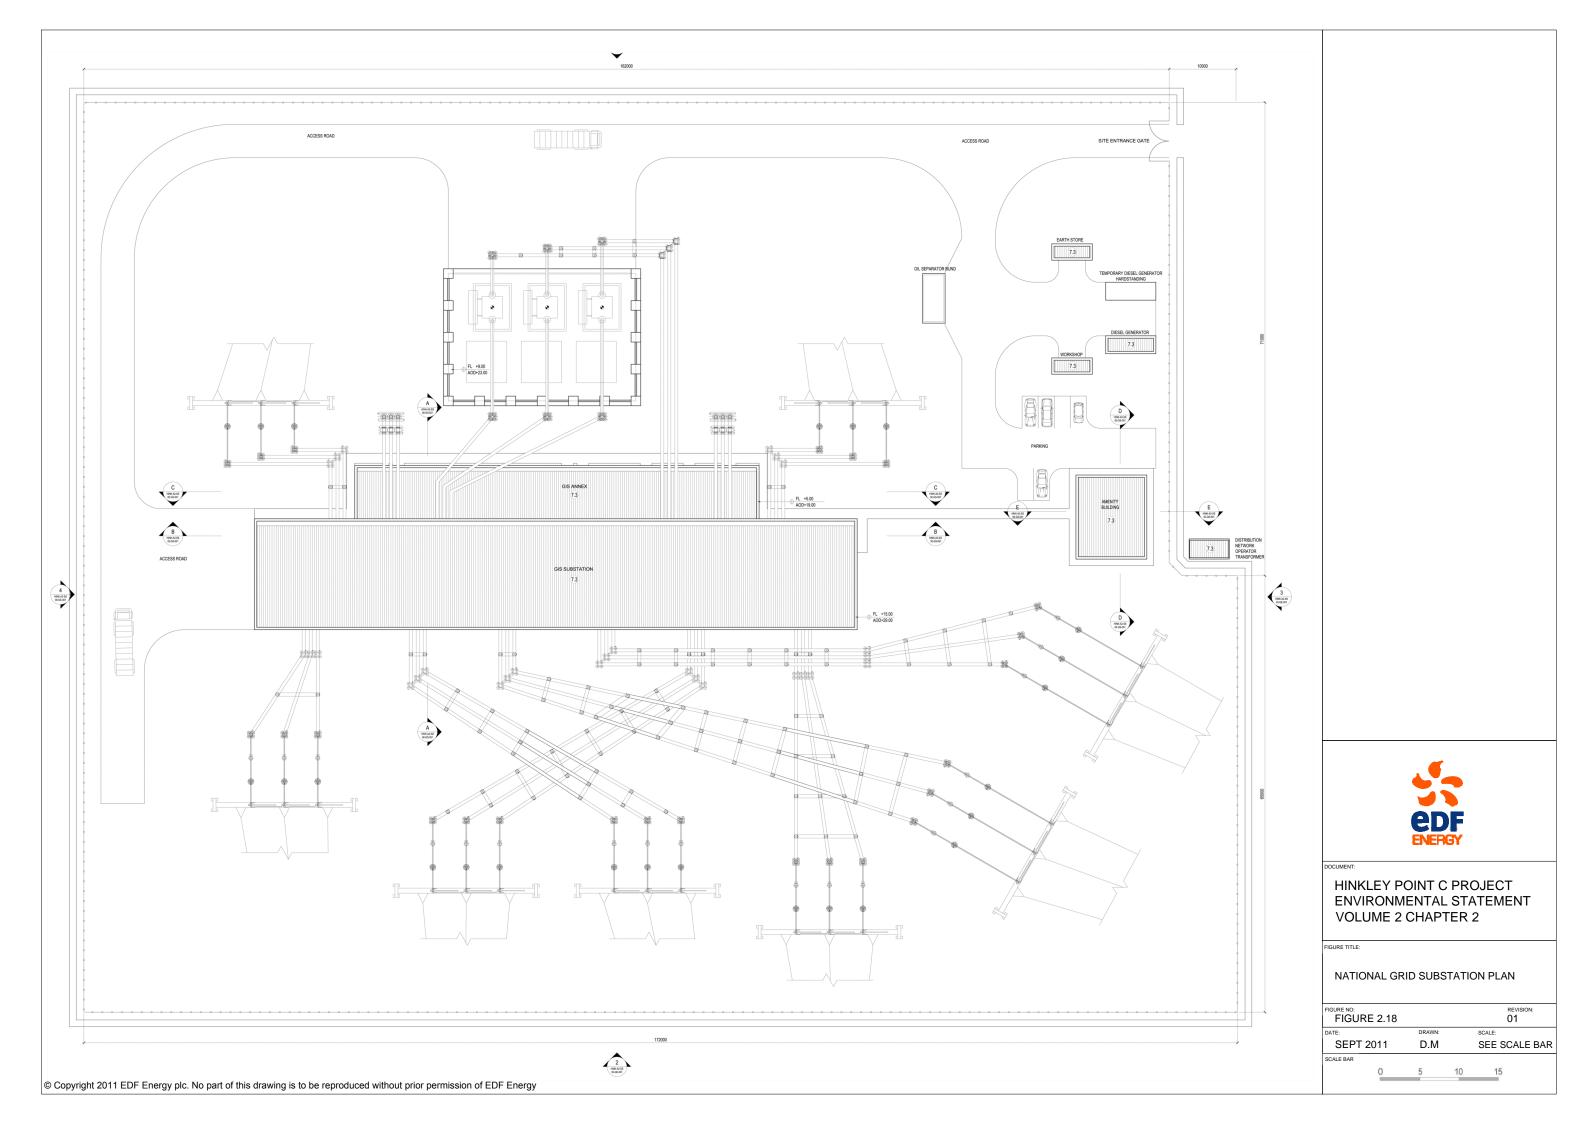


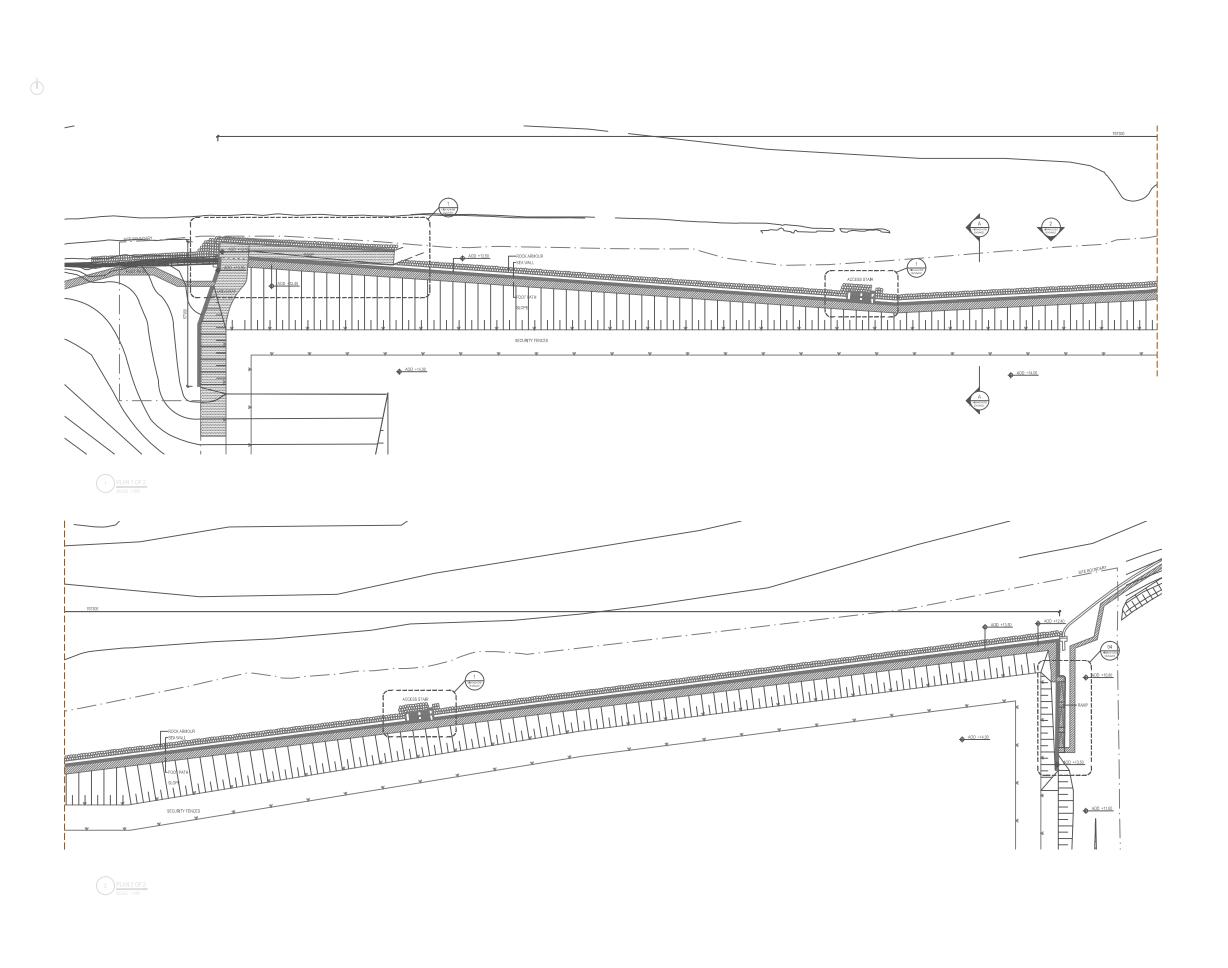
HINKLEY POINT C PROJECT ENVIRONMENTAL STATEMENT VOLUME 2 CHAPTER 2

FIGURE TITLE

NATIONAL GRID SUBSTATION NORTH AND WEST ELEVATION

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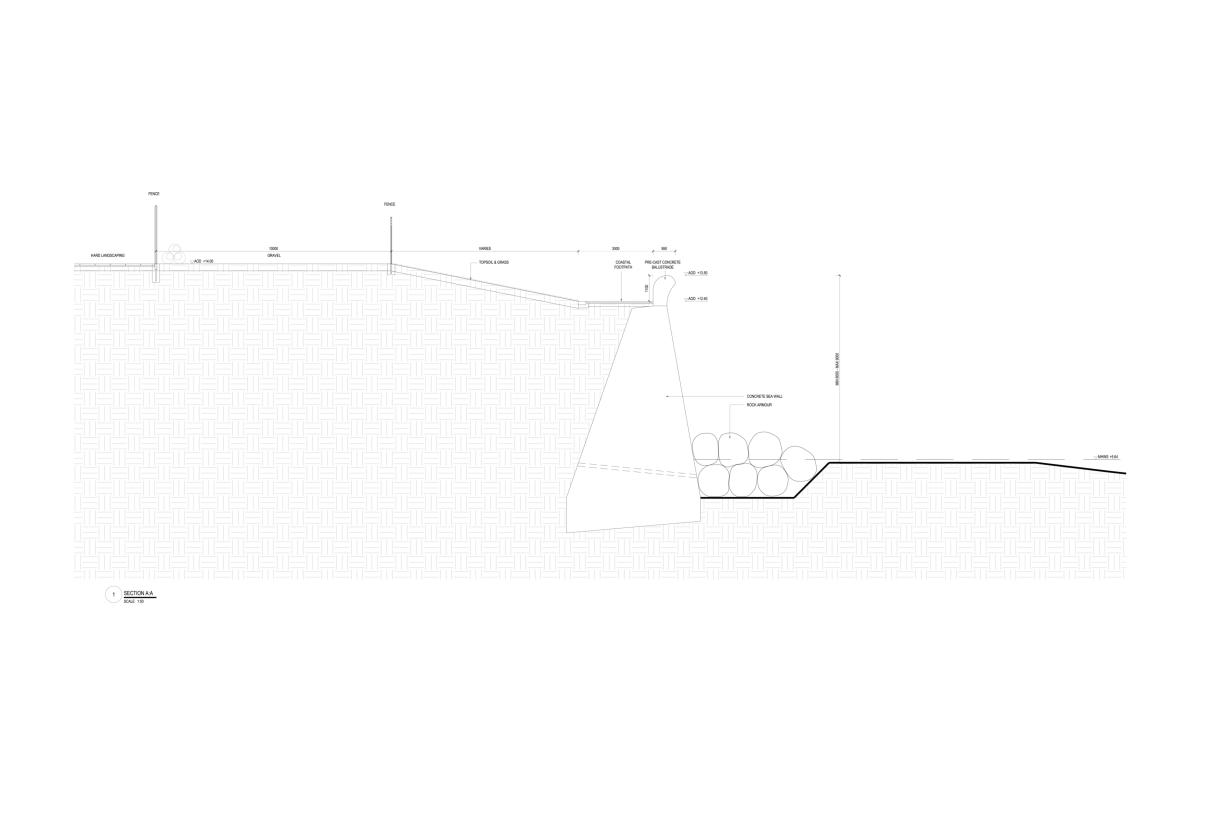
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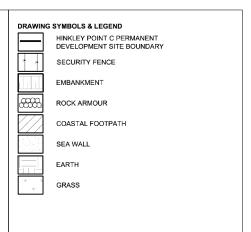
HINKLEY POINT C PROJECT ENVIRONMENTAL STATEMENT VOLUME 2 CHAPTER 2

FIGURE TITLE

SEA WALL PLANS

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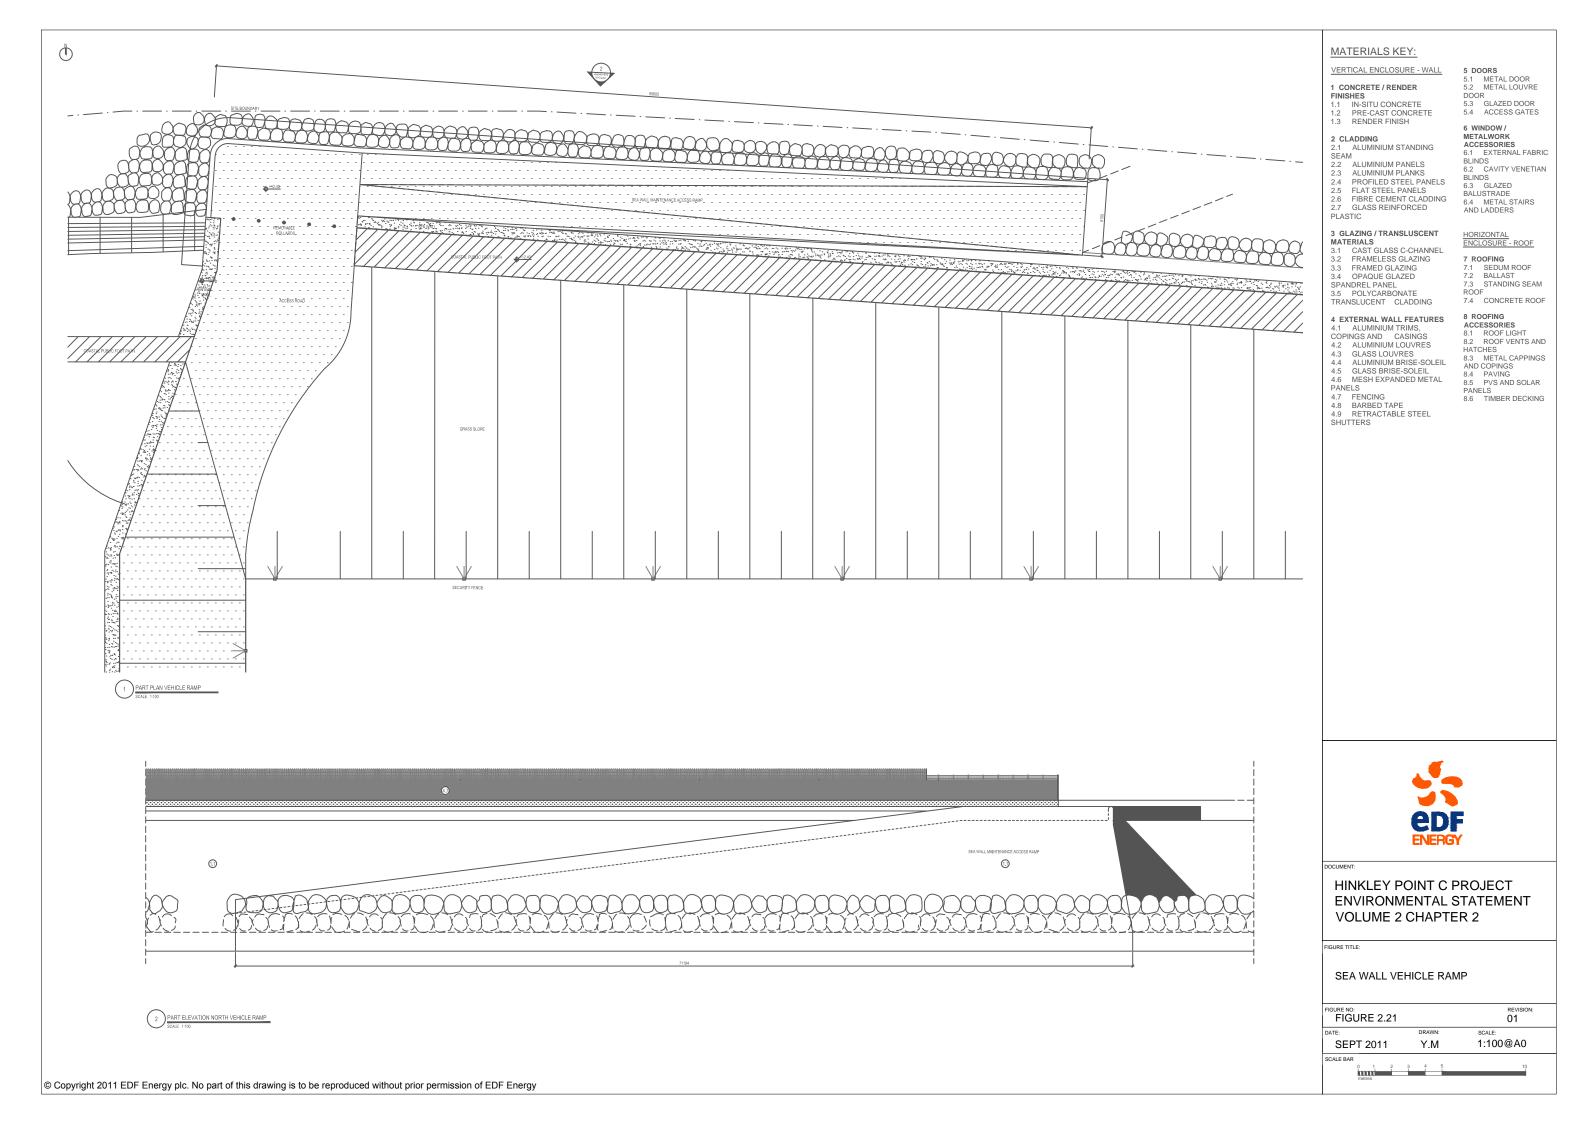
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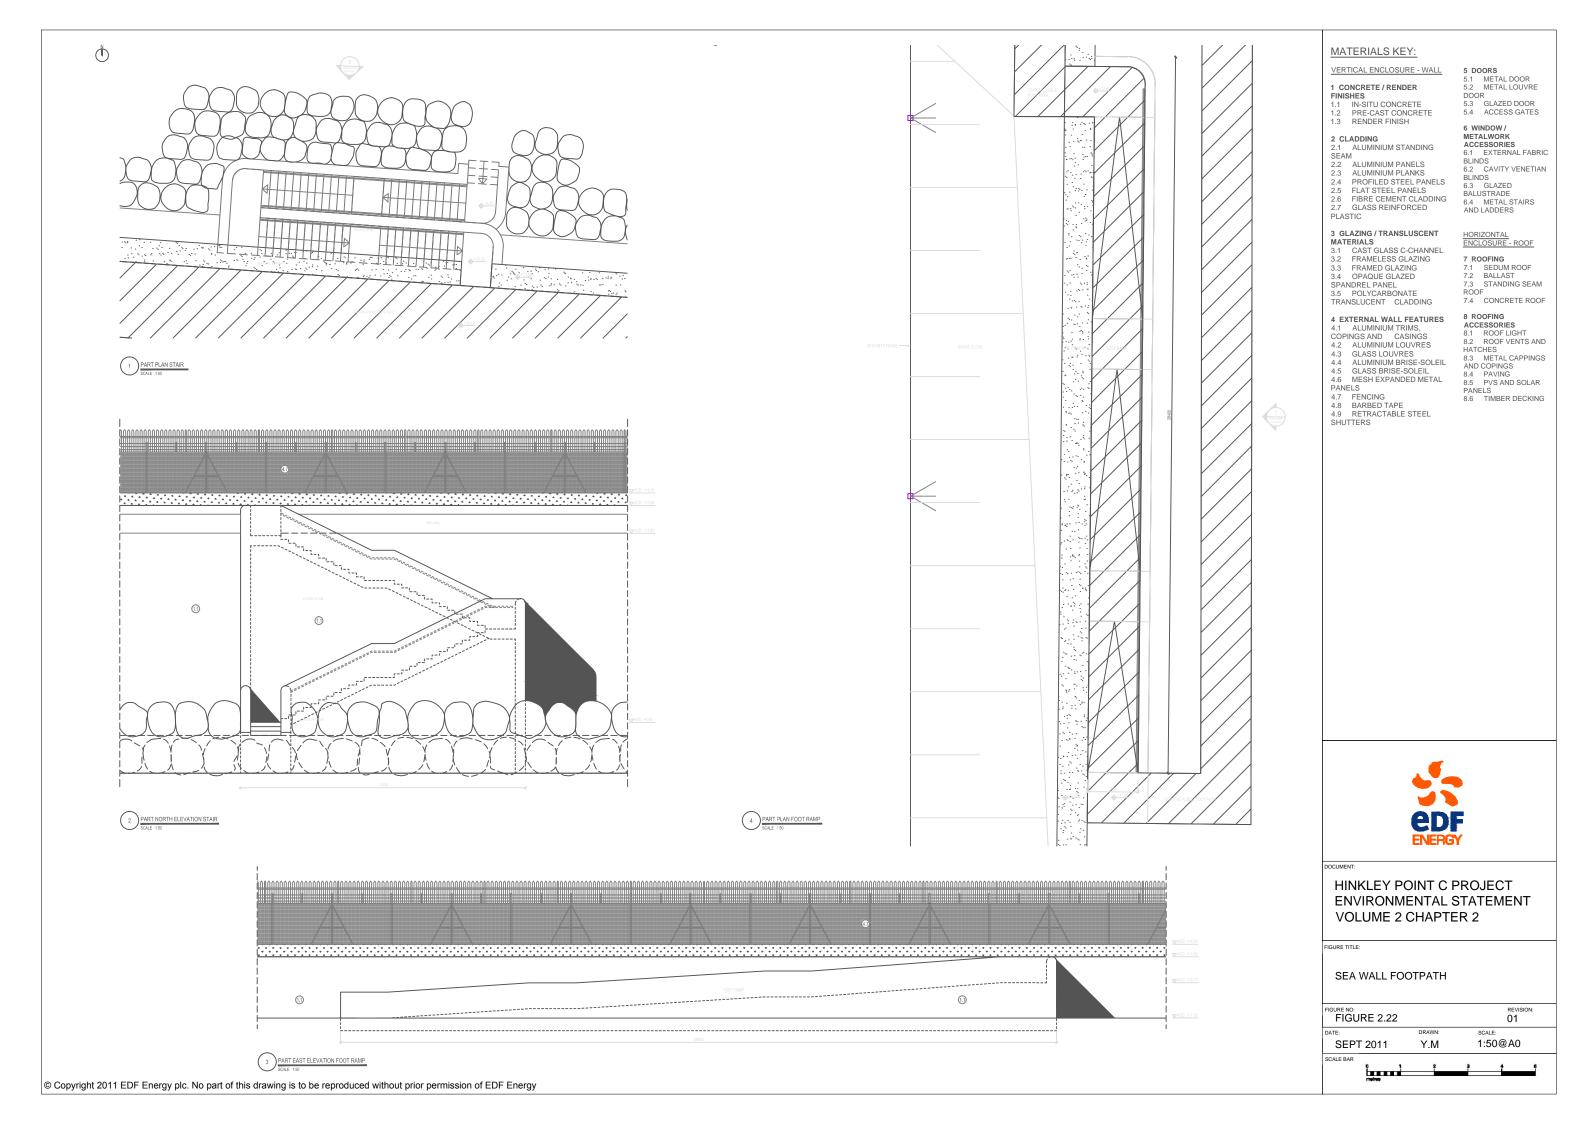
HINKLEY POINT C PROJECT ENVIRONMENTAL STATEMENT VOLUME 2 CHAPTER 2


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SEA WALL SECTION

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NOTES:

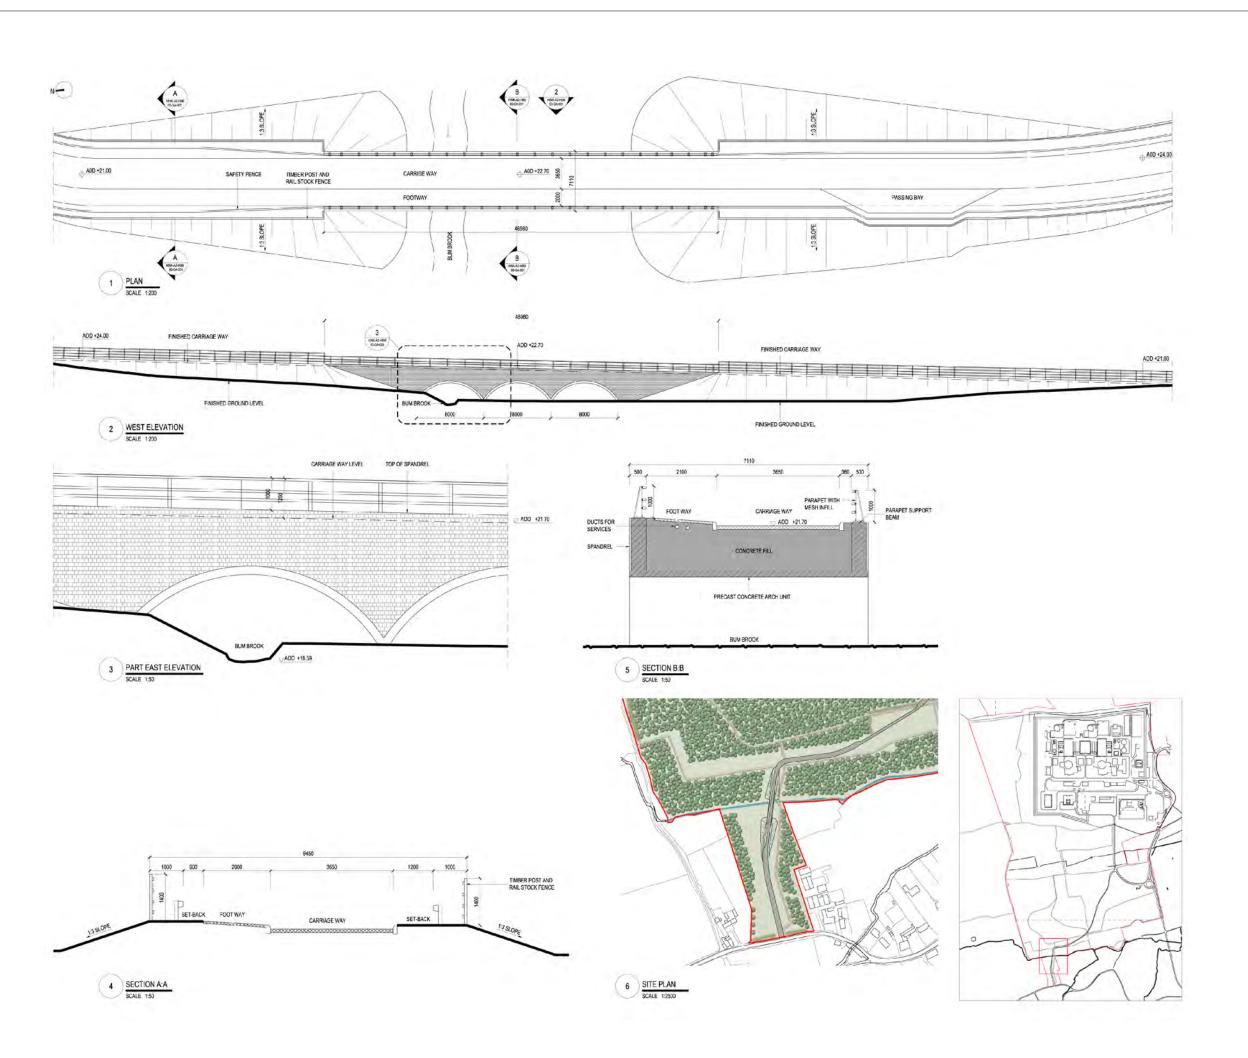- 1 ALL DIMENSIONS ARE IN MILLIMETERS UNLESS OTHERWISE STATED.
- 2. ALL LEVELS ARE IN METRES ABOVE ORDANANCE DATUM (MAOD) UNLESS STATED OTHERWISE.
- 3. THE LEVELS PROVIDED WITHIN THIS DESIGN CONCEPT ARE BASED ON INFORMATION PROVIDED WITHIN THE FLOOD RISK ASSESSMENT STUDY. FURTHER TOPOGRAPHICAL, ENVIRONMENTAL CLIENT DESIGN REQUIREMENTS AND GROUND INVESTIGATION INFORMATION WILL BE REQUIRED TO ADVANCE THE DEVELOPMENT OF THE DESIGN.
- 4. SOFFIT HEIGHT OF THE BRIDGE IS 21.2M AOD.



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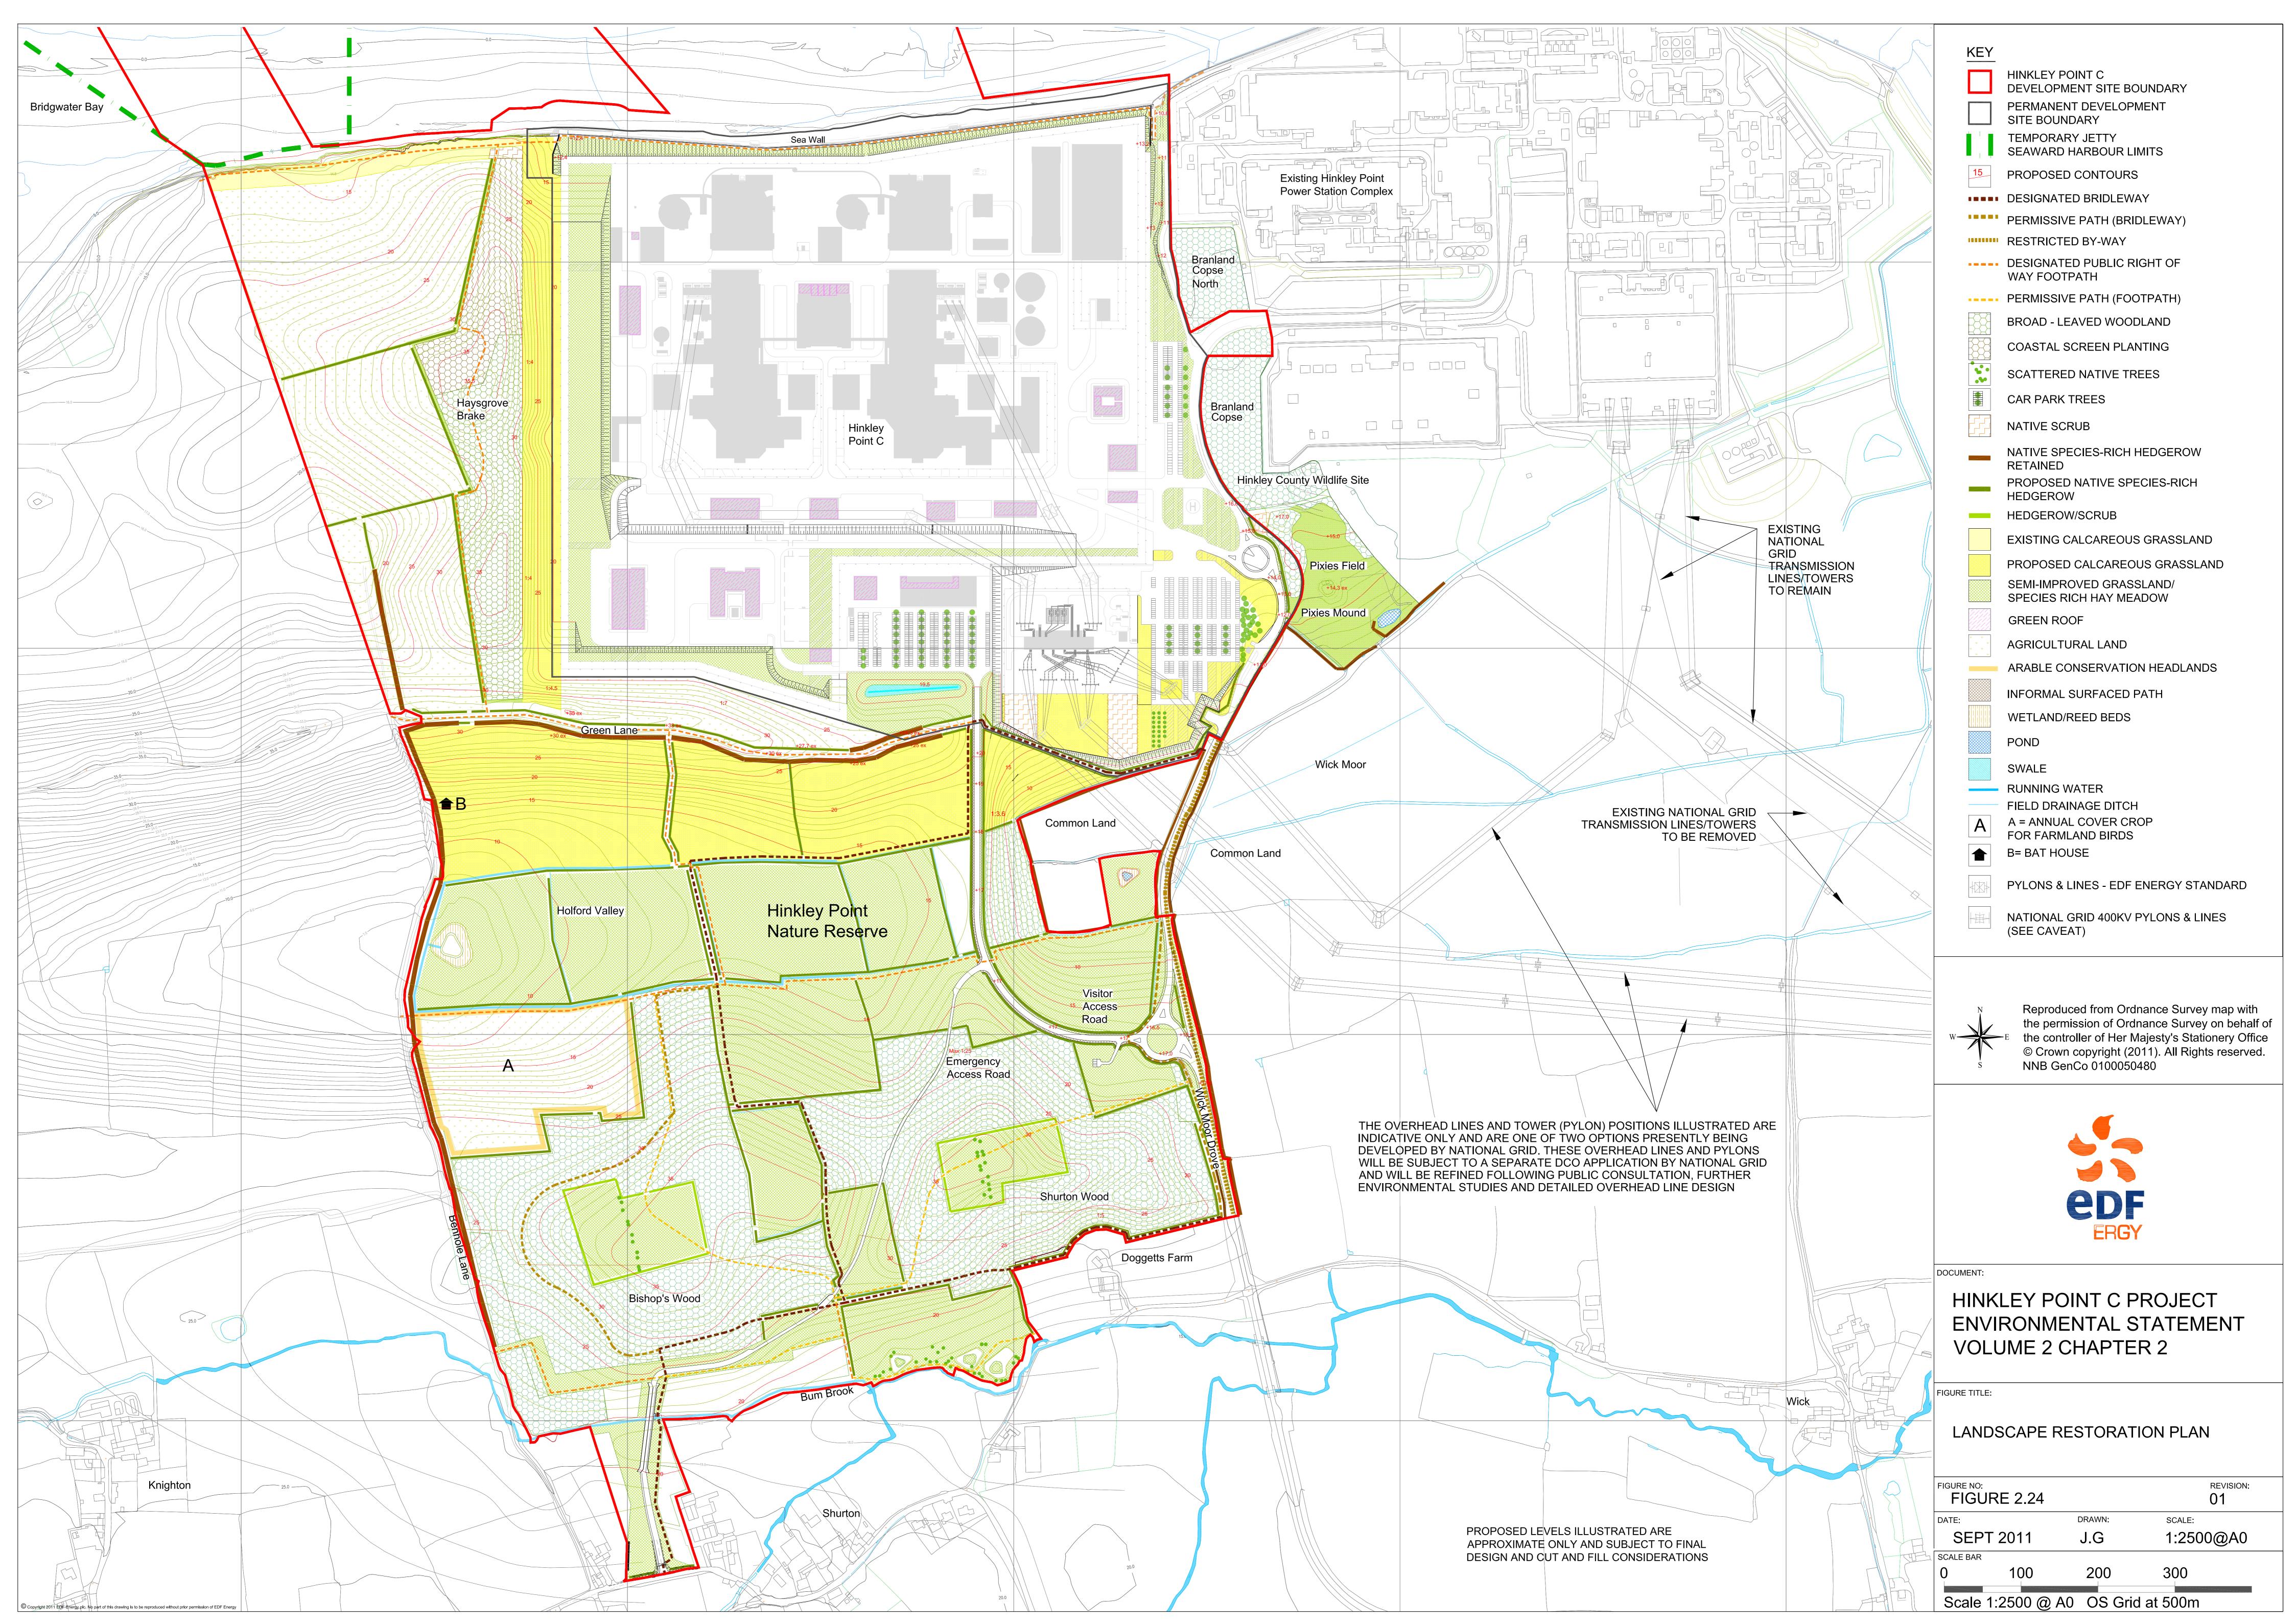
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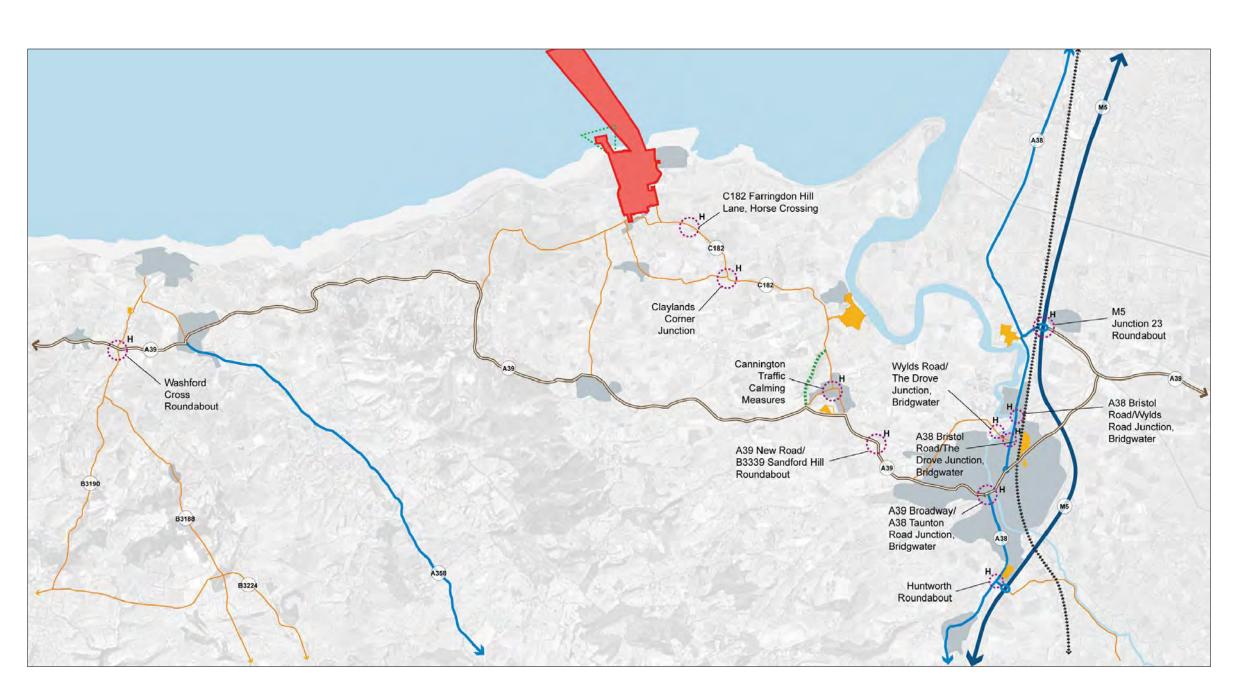
HINKLEY POINT C PROJECT ENVIRONMENTAL STATEMENT VOLUME 2 CHAPTER 2


FIGURE TITLE

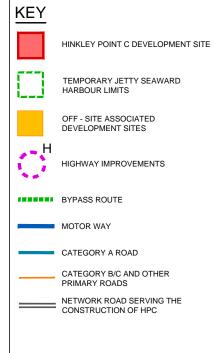BRIDGE OVER BUM BROOK

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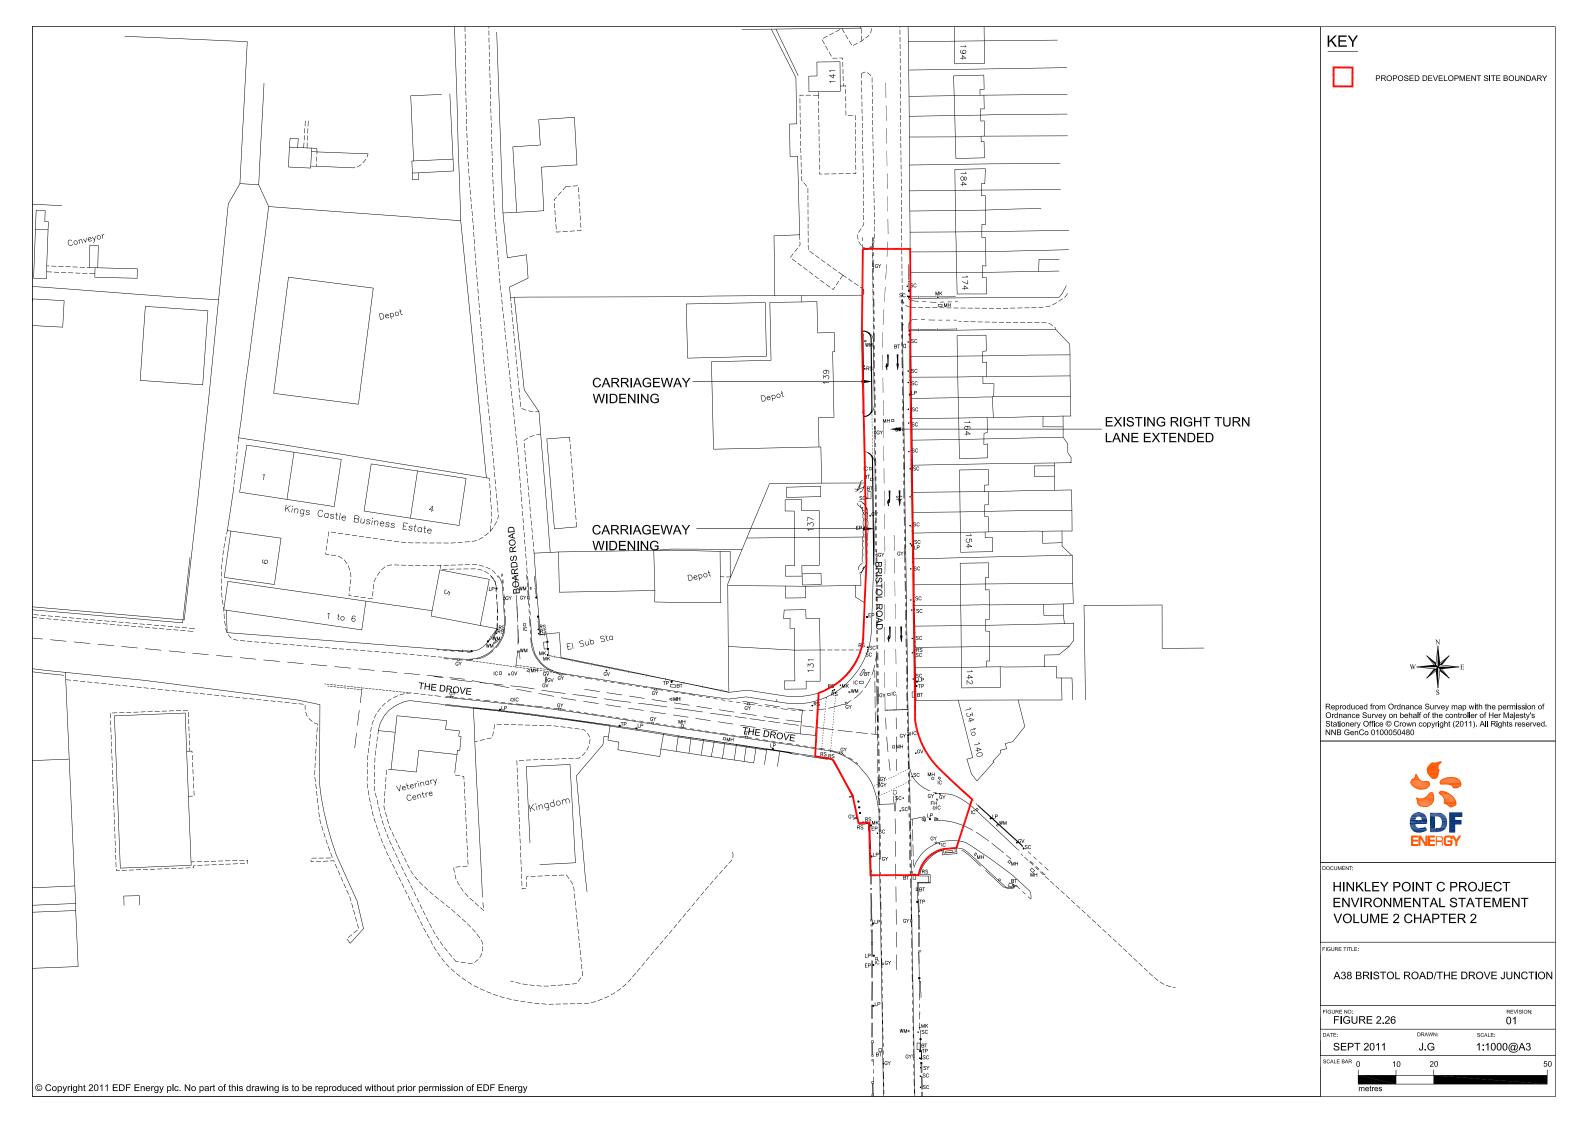
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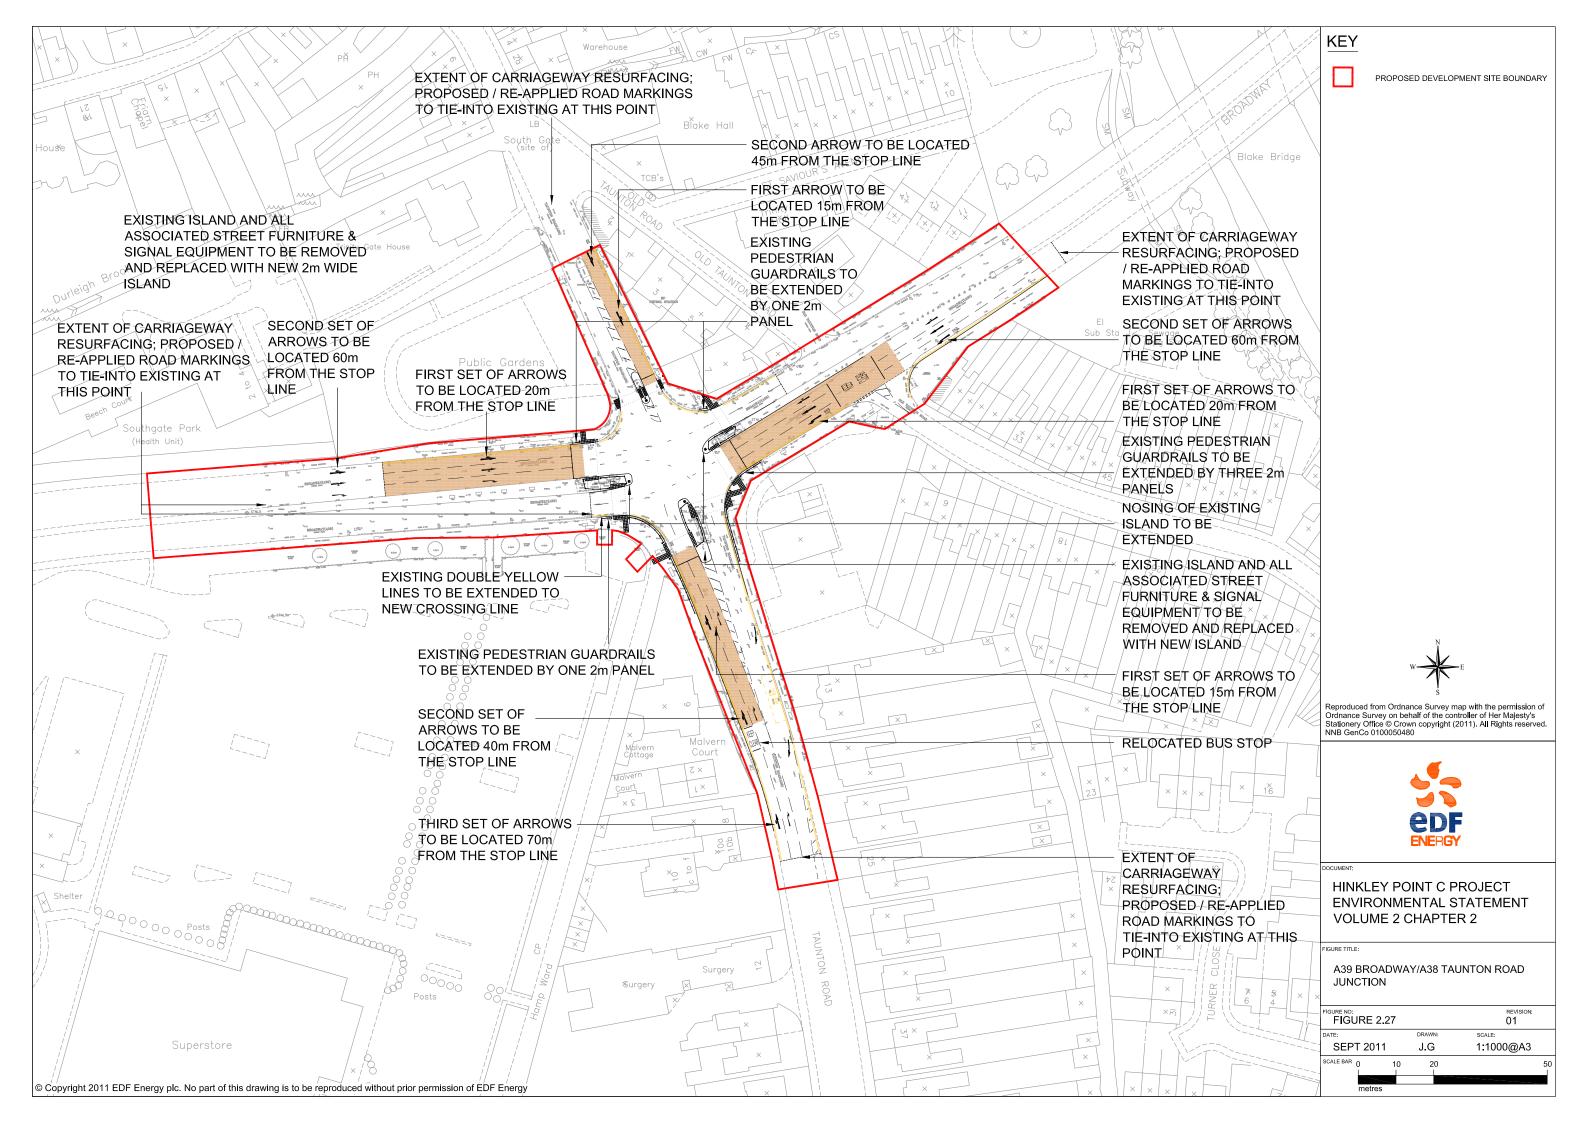
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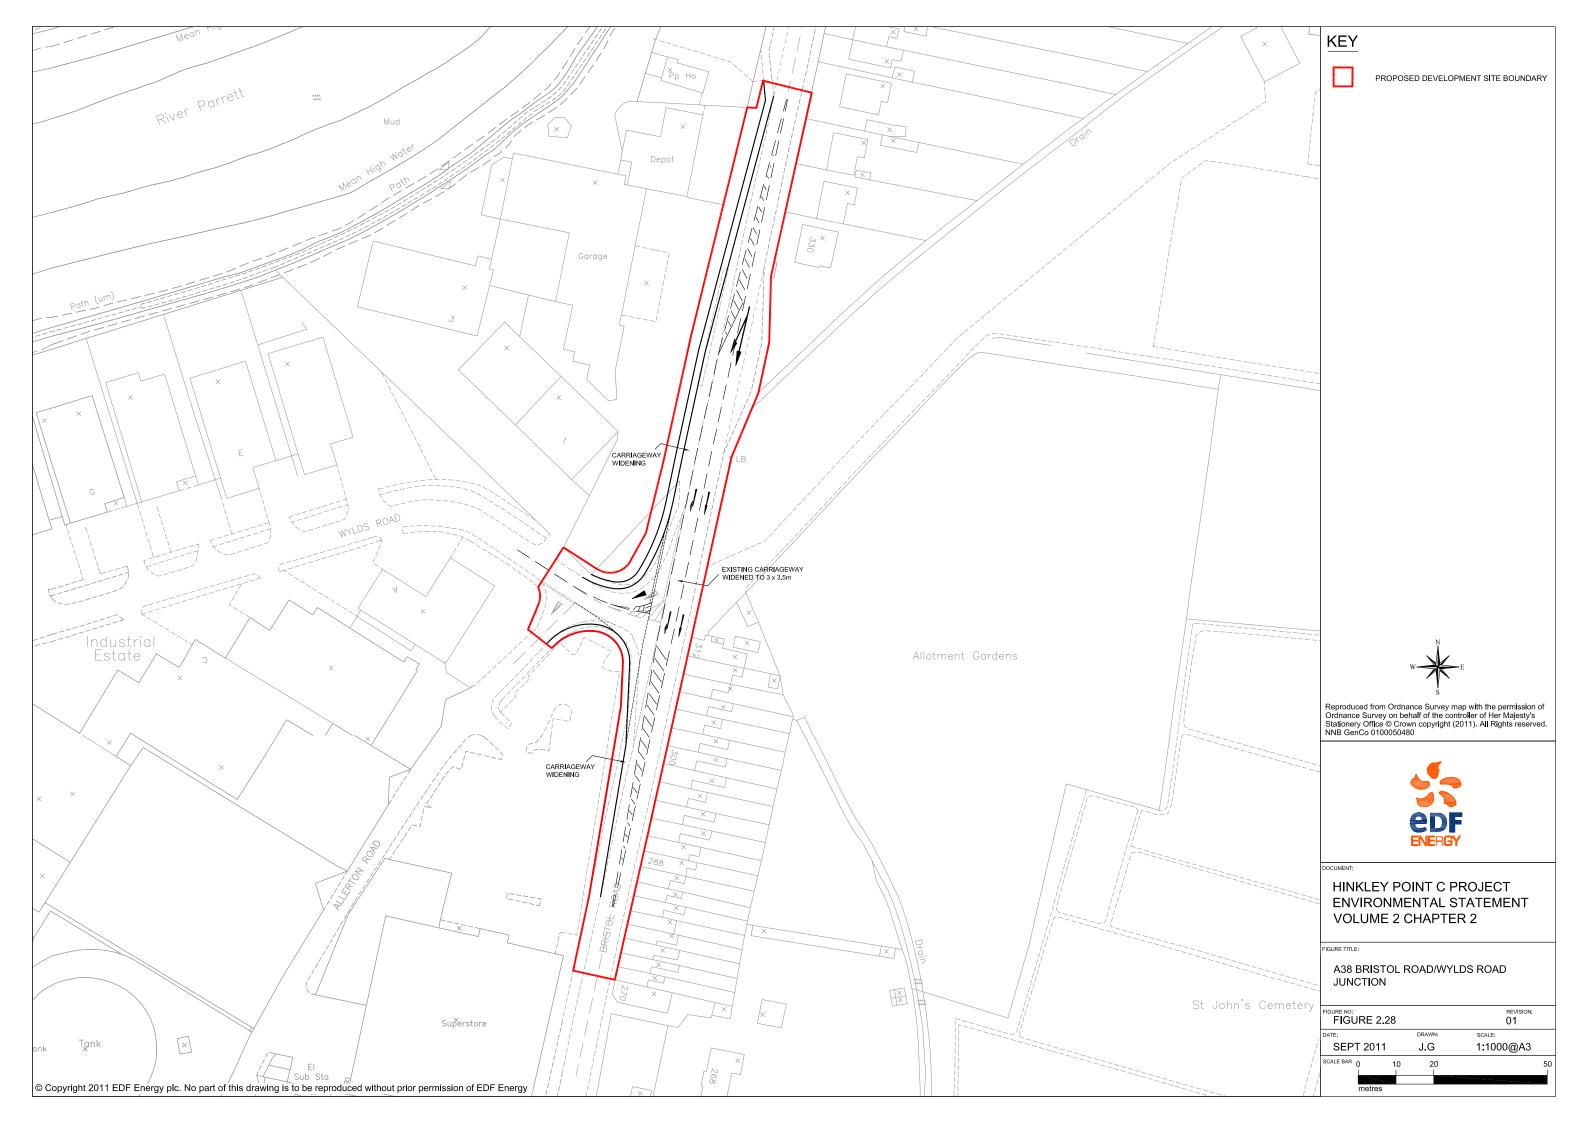
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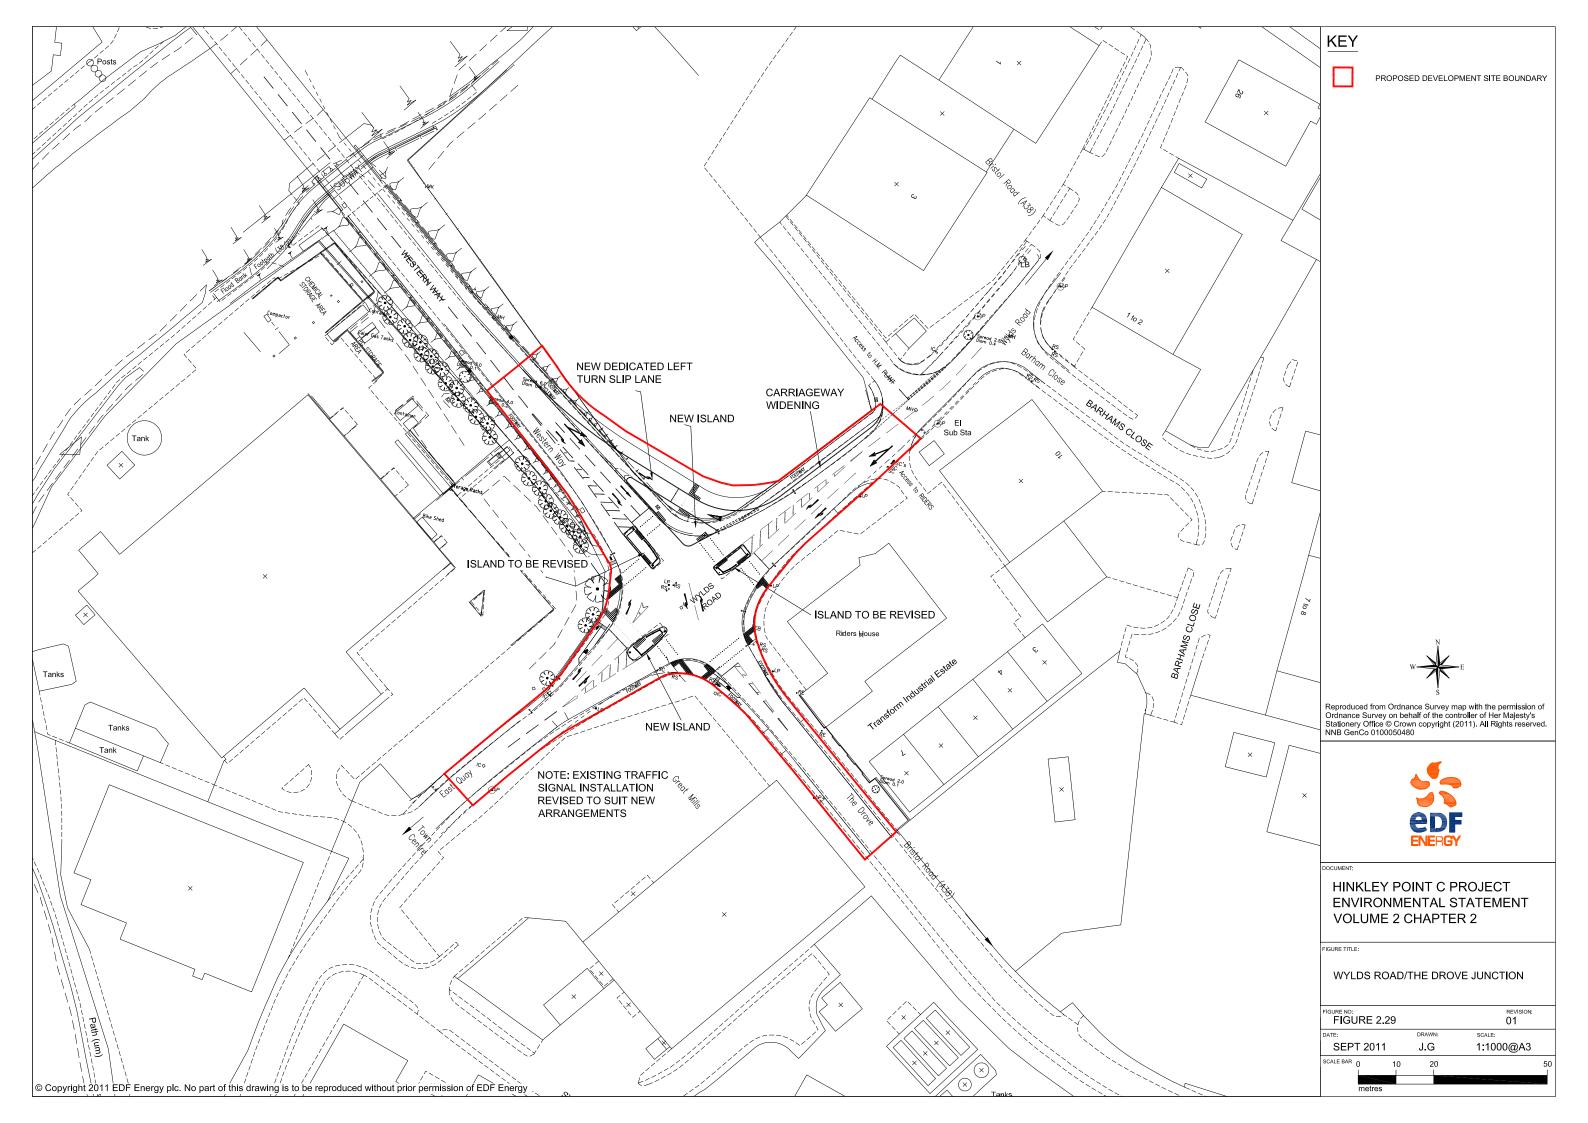
LOCATION OF THE HIGHWAY IMPROVEMENTS

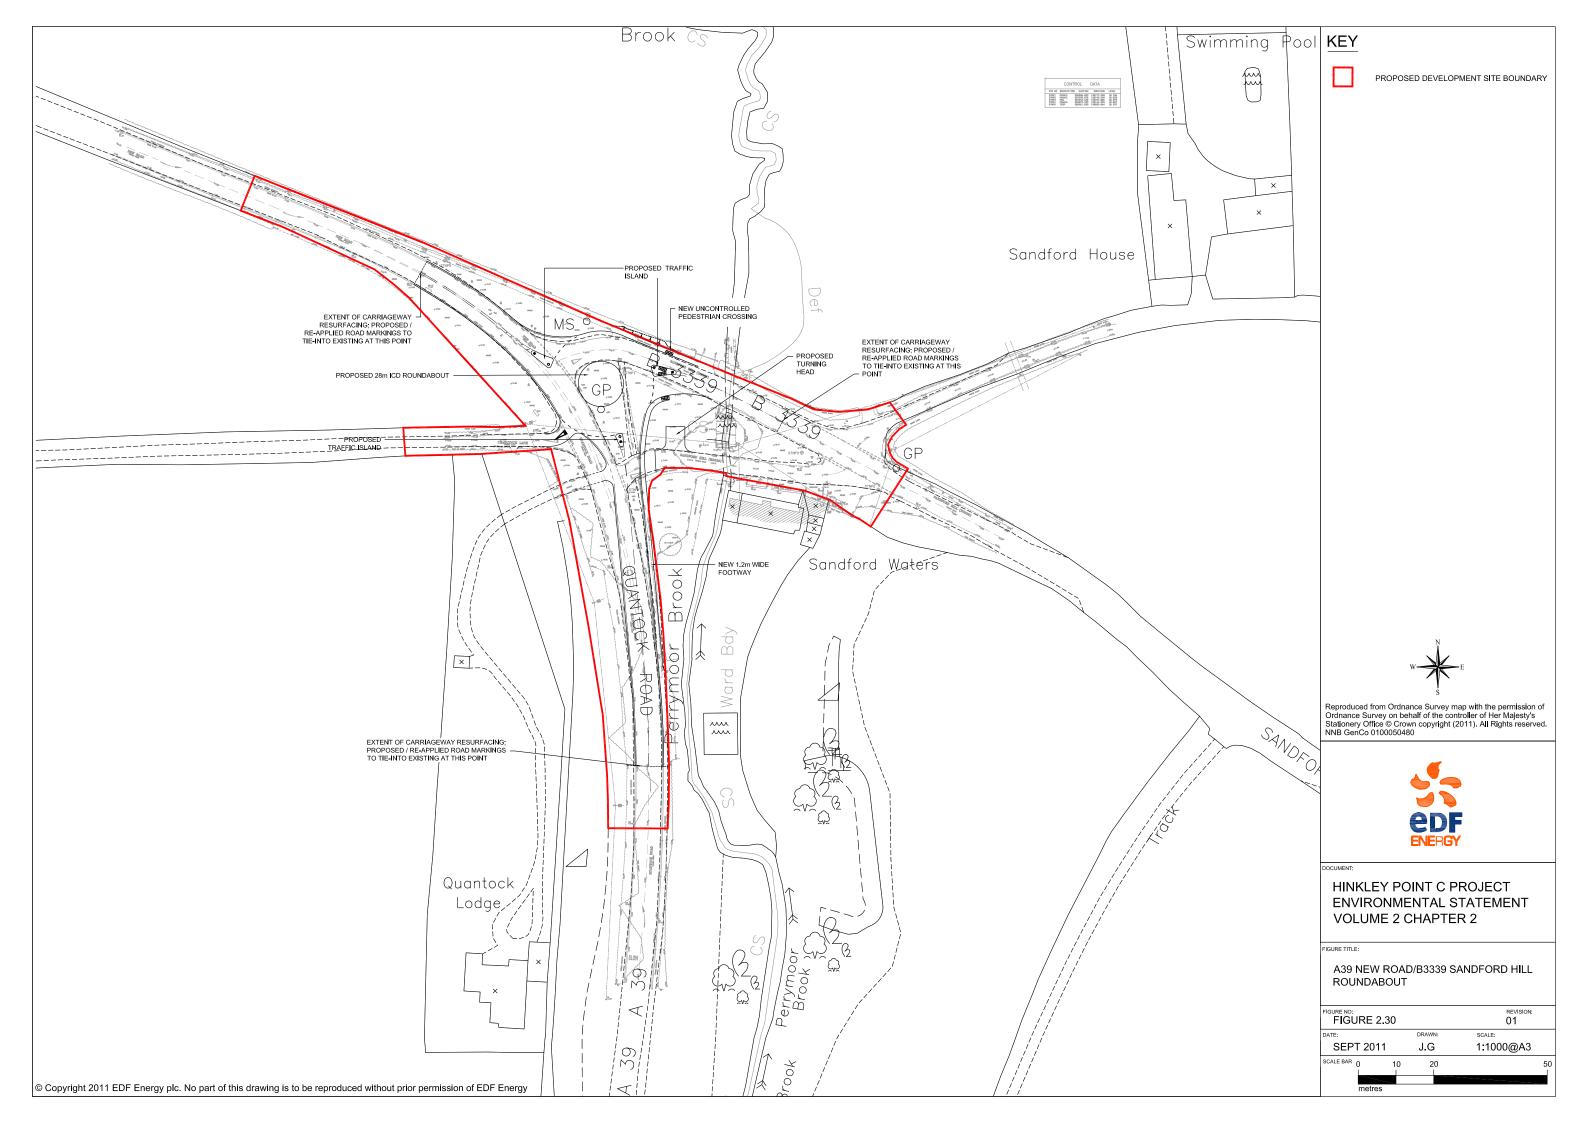
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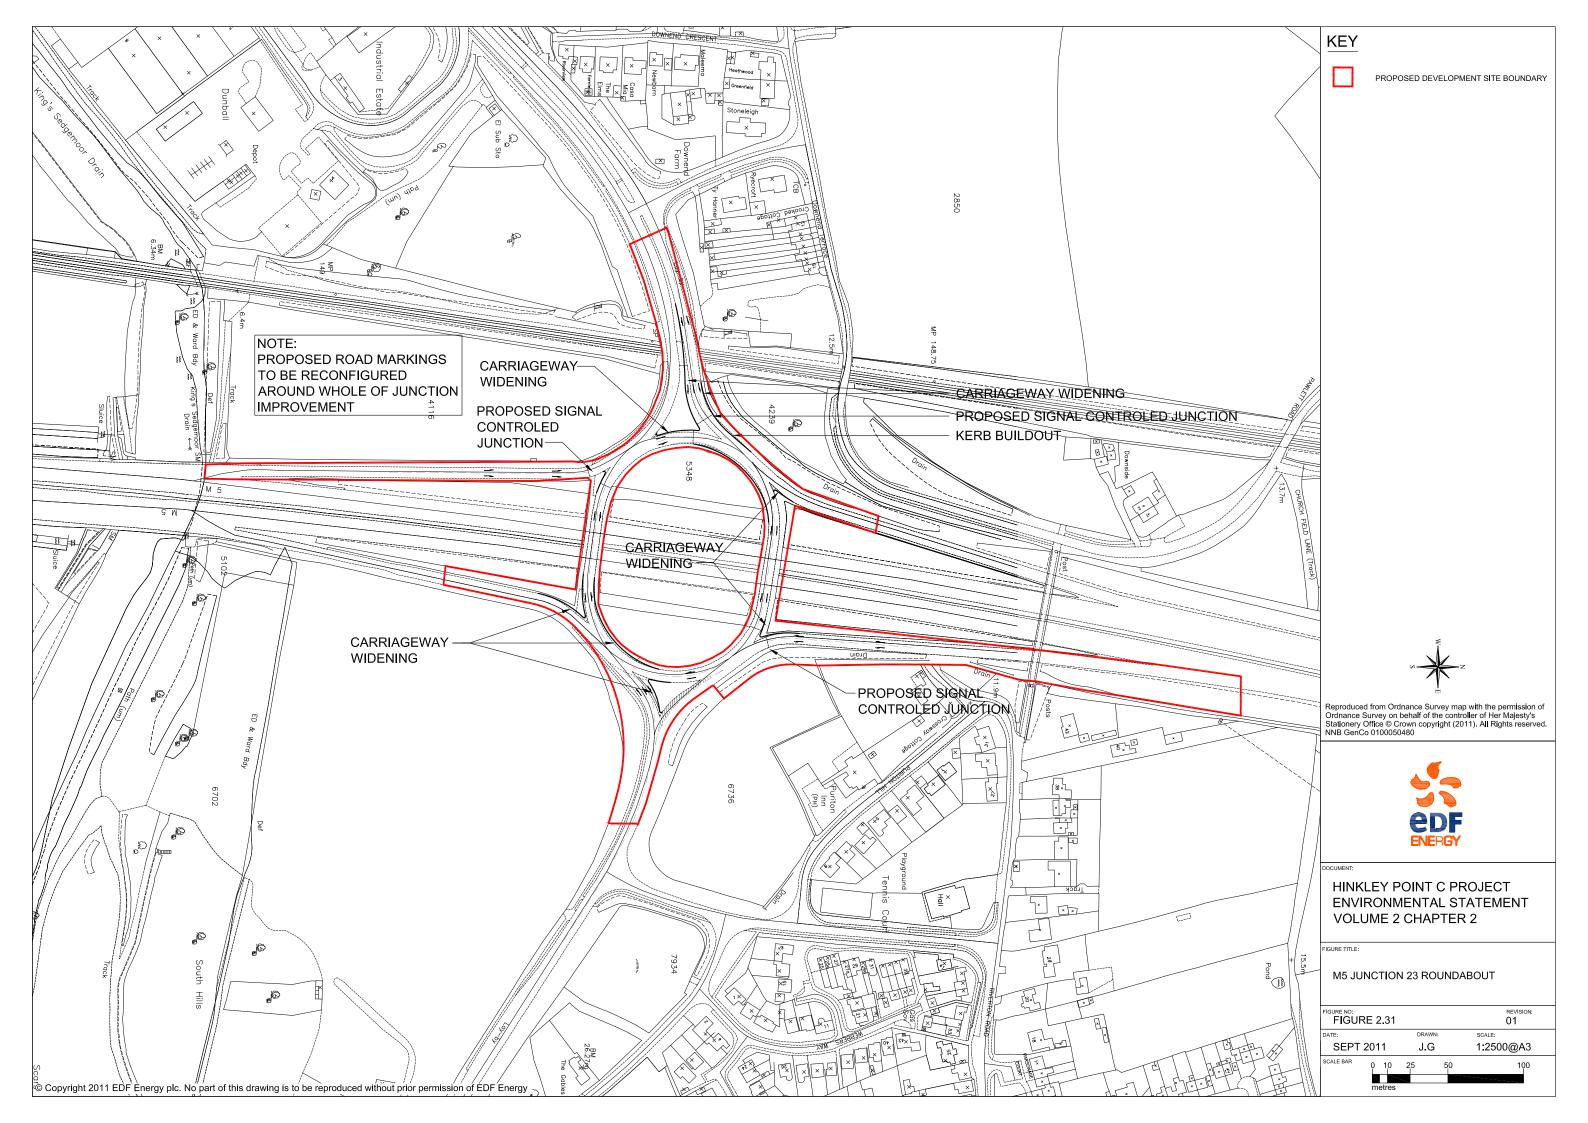


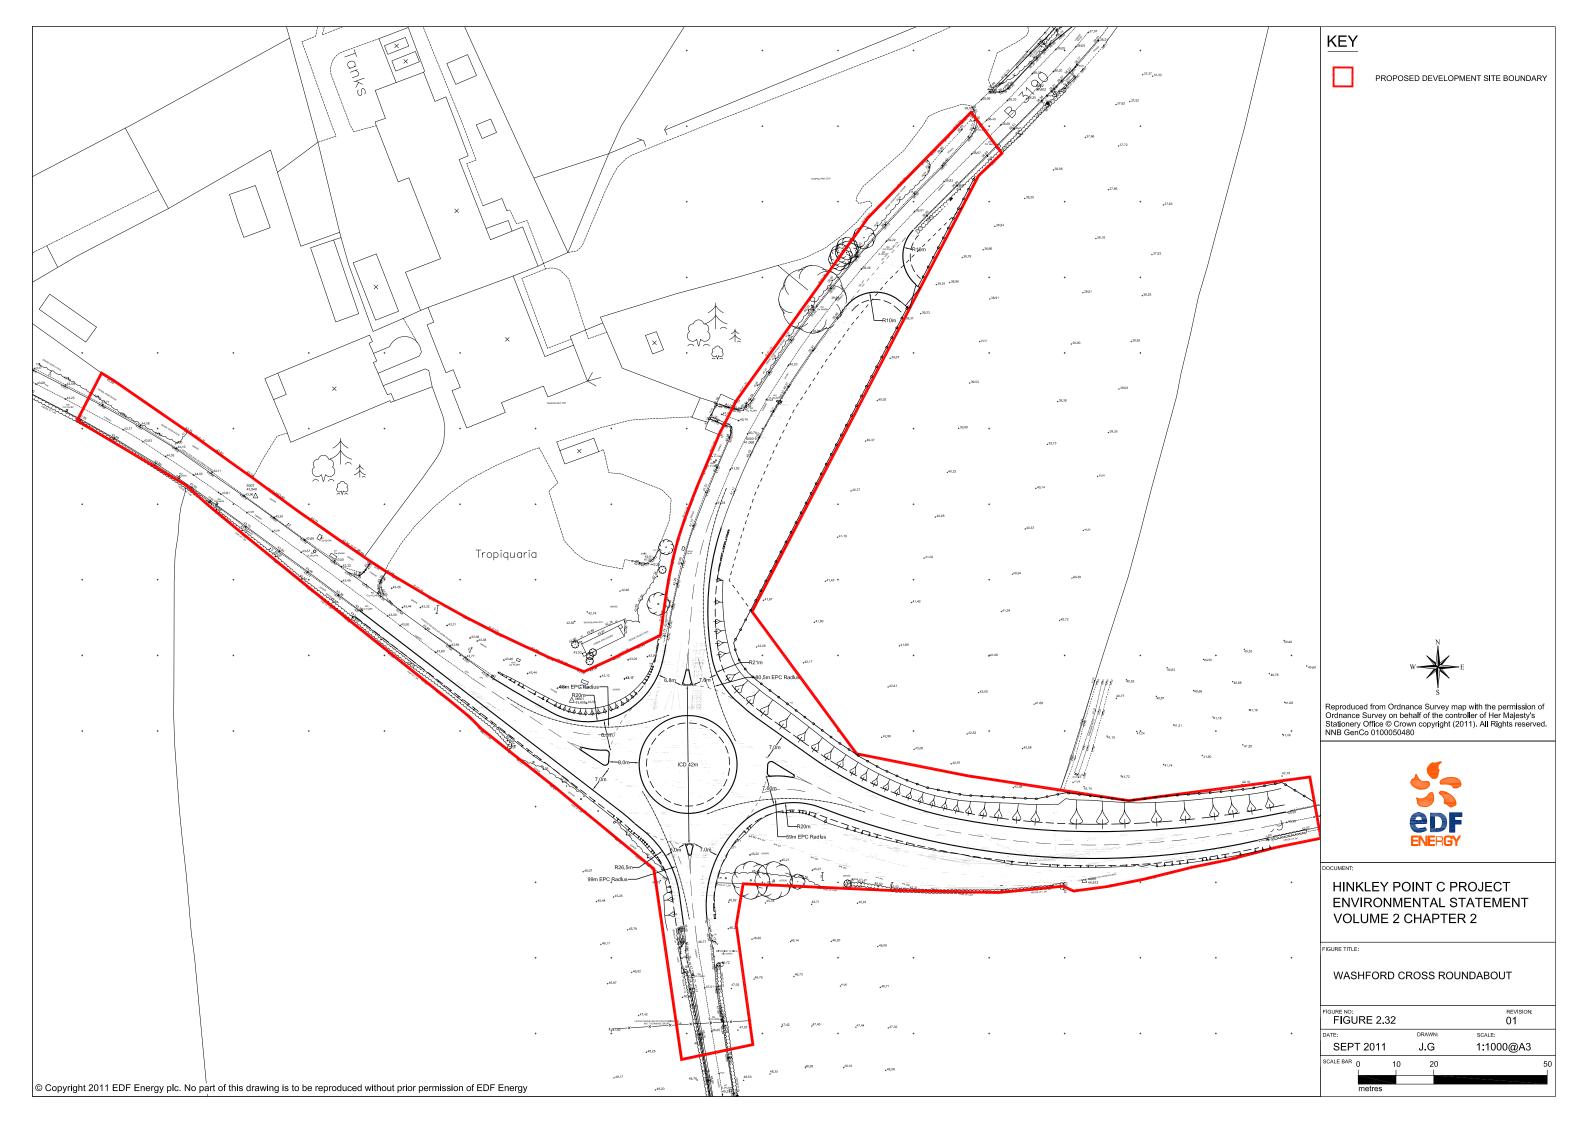


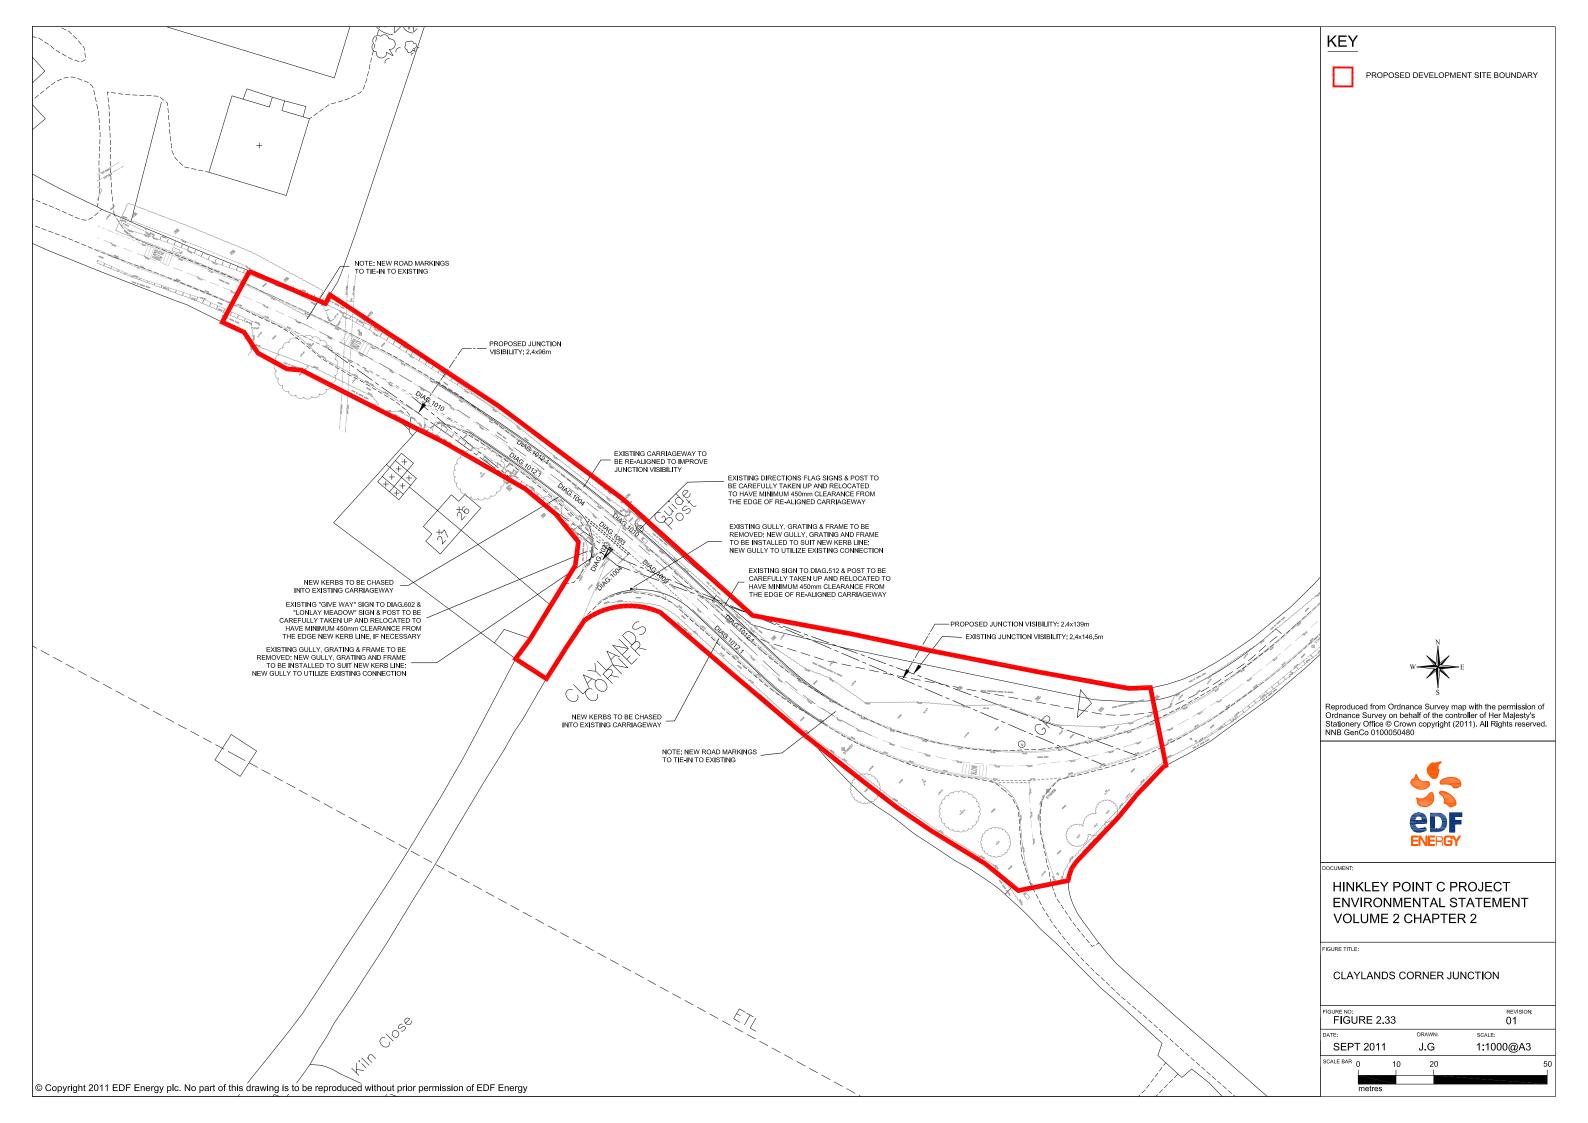


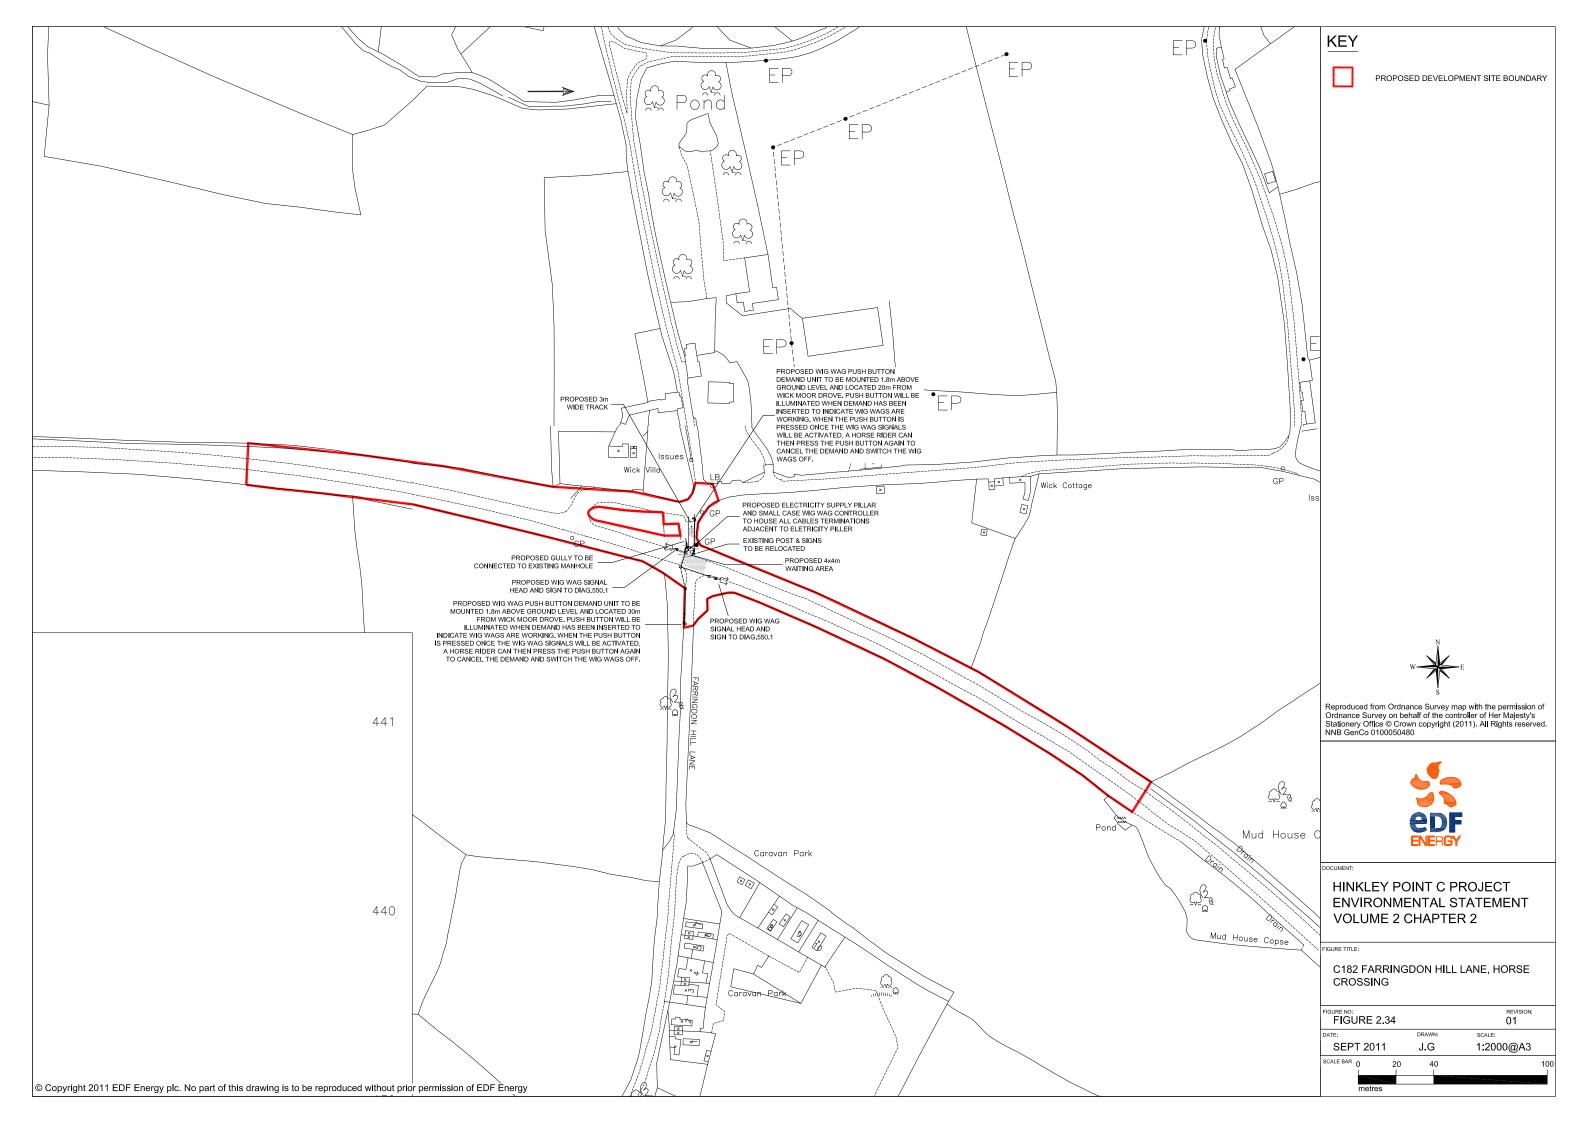


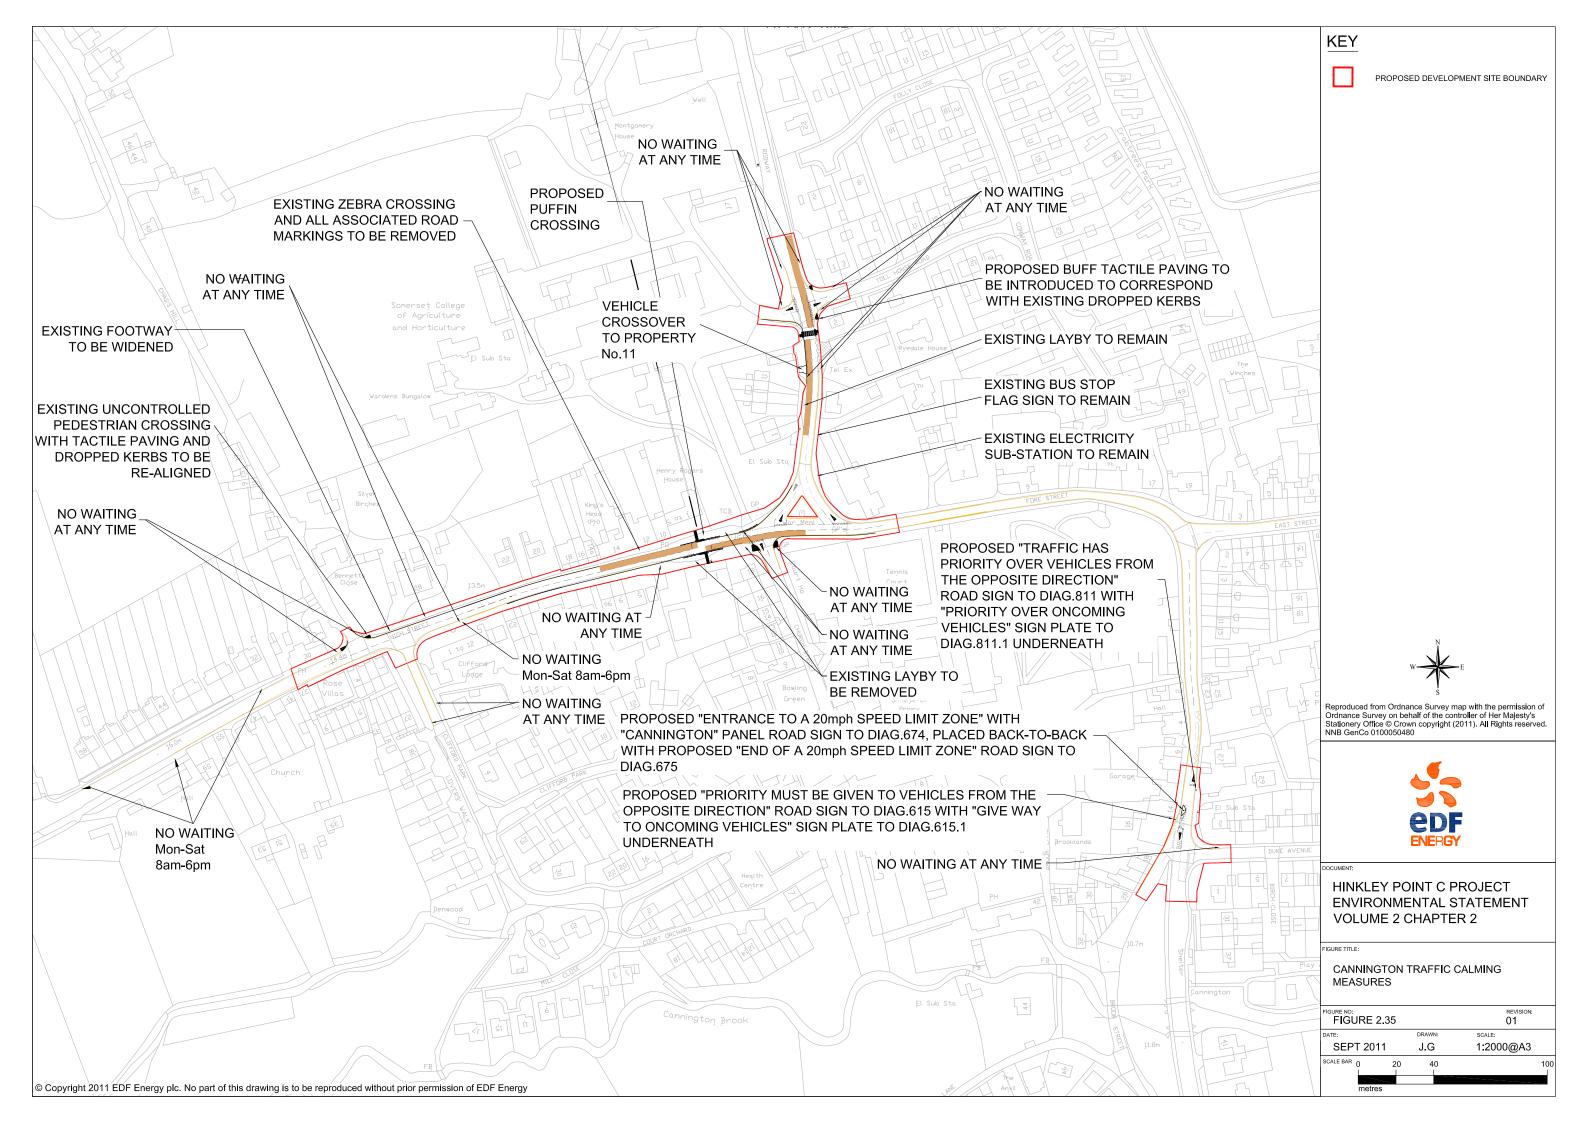


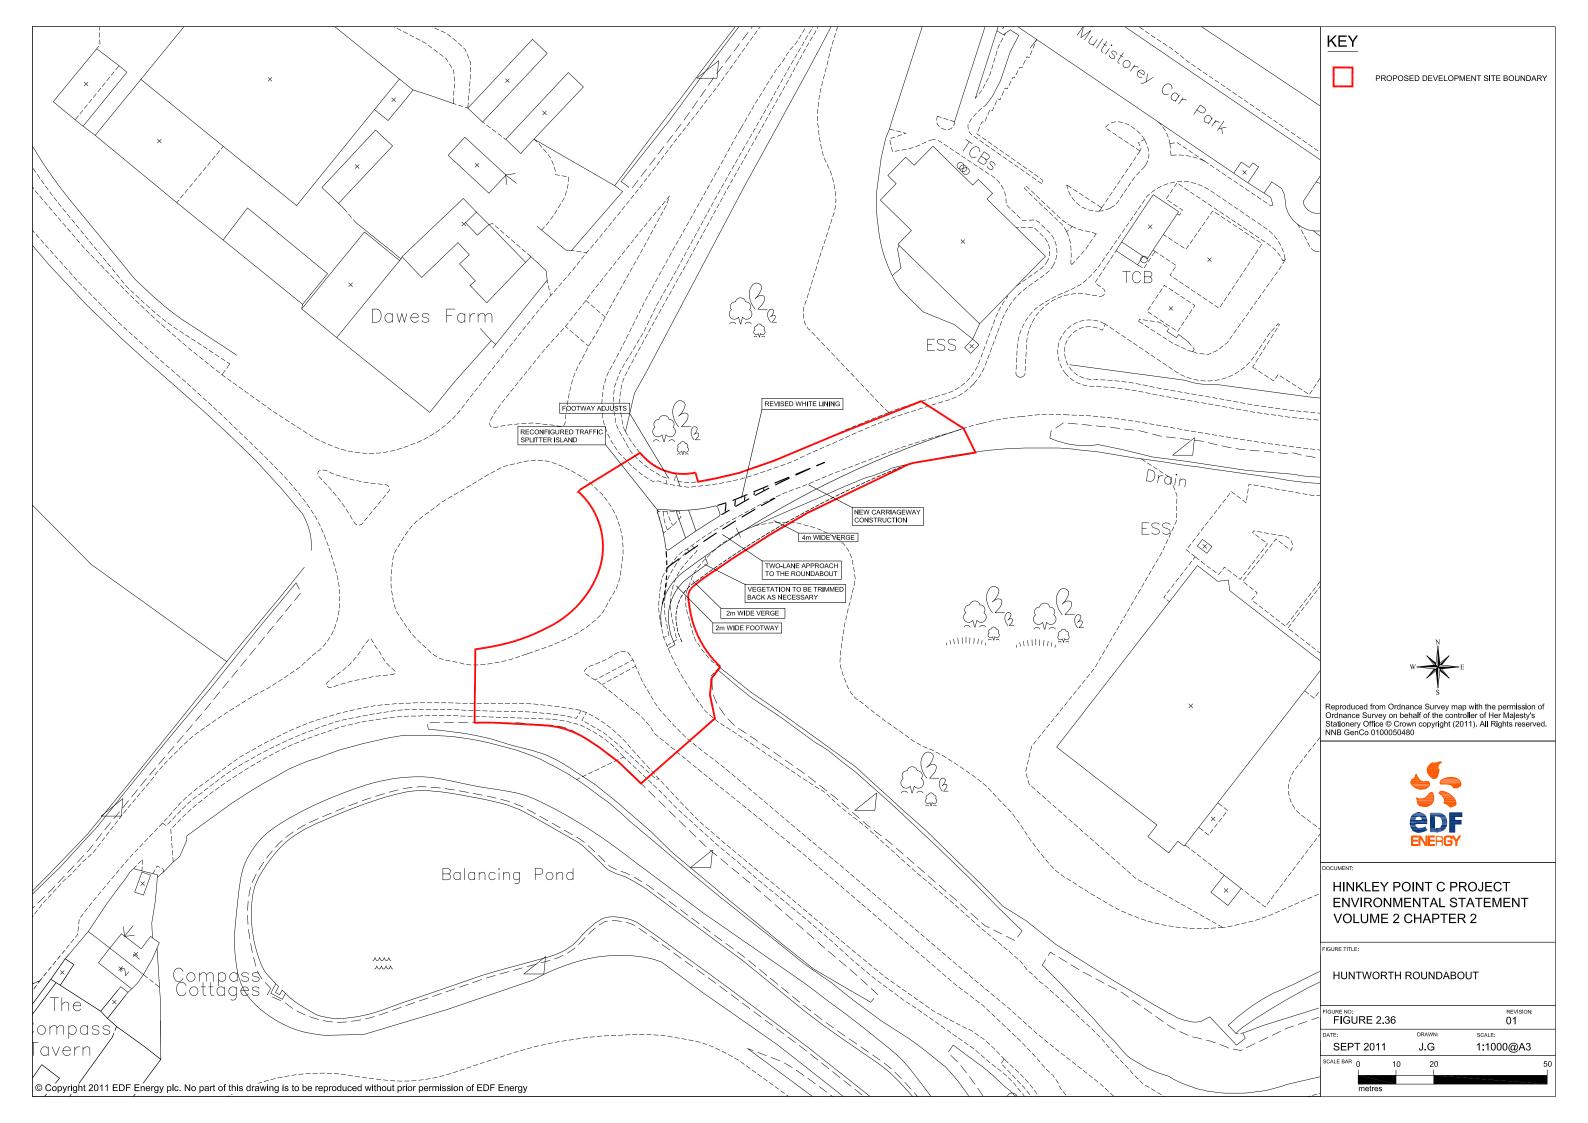


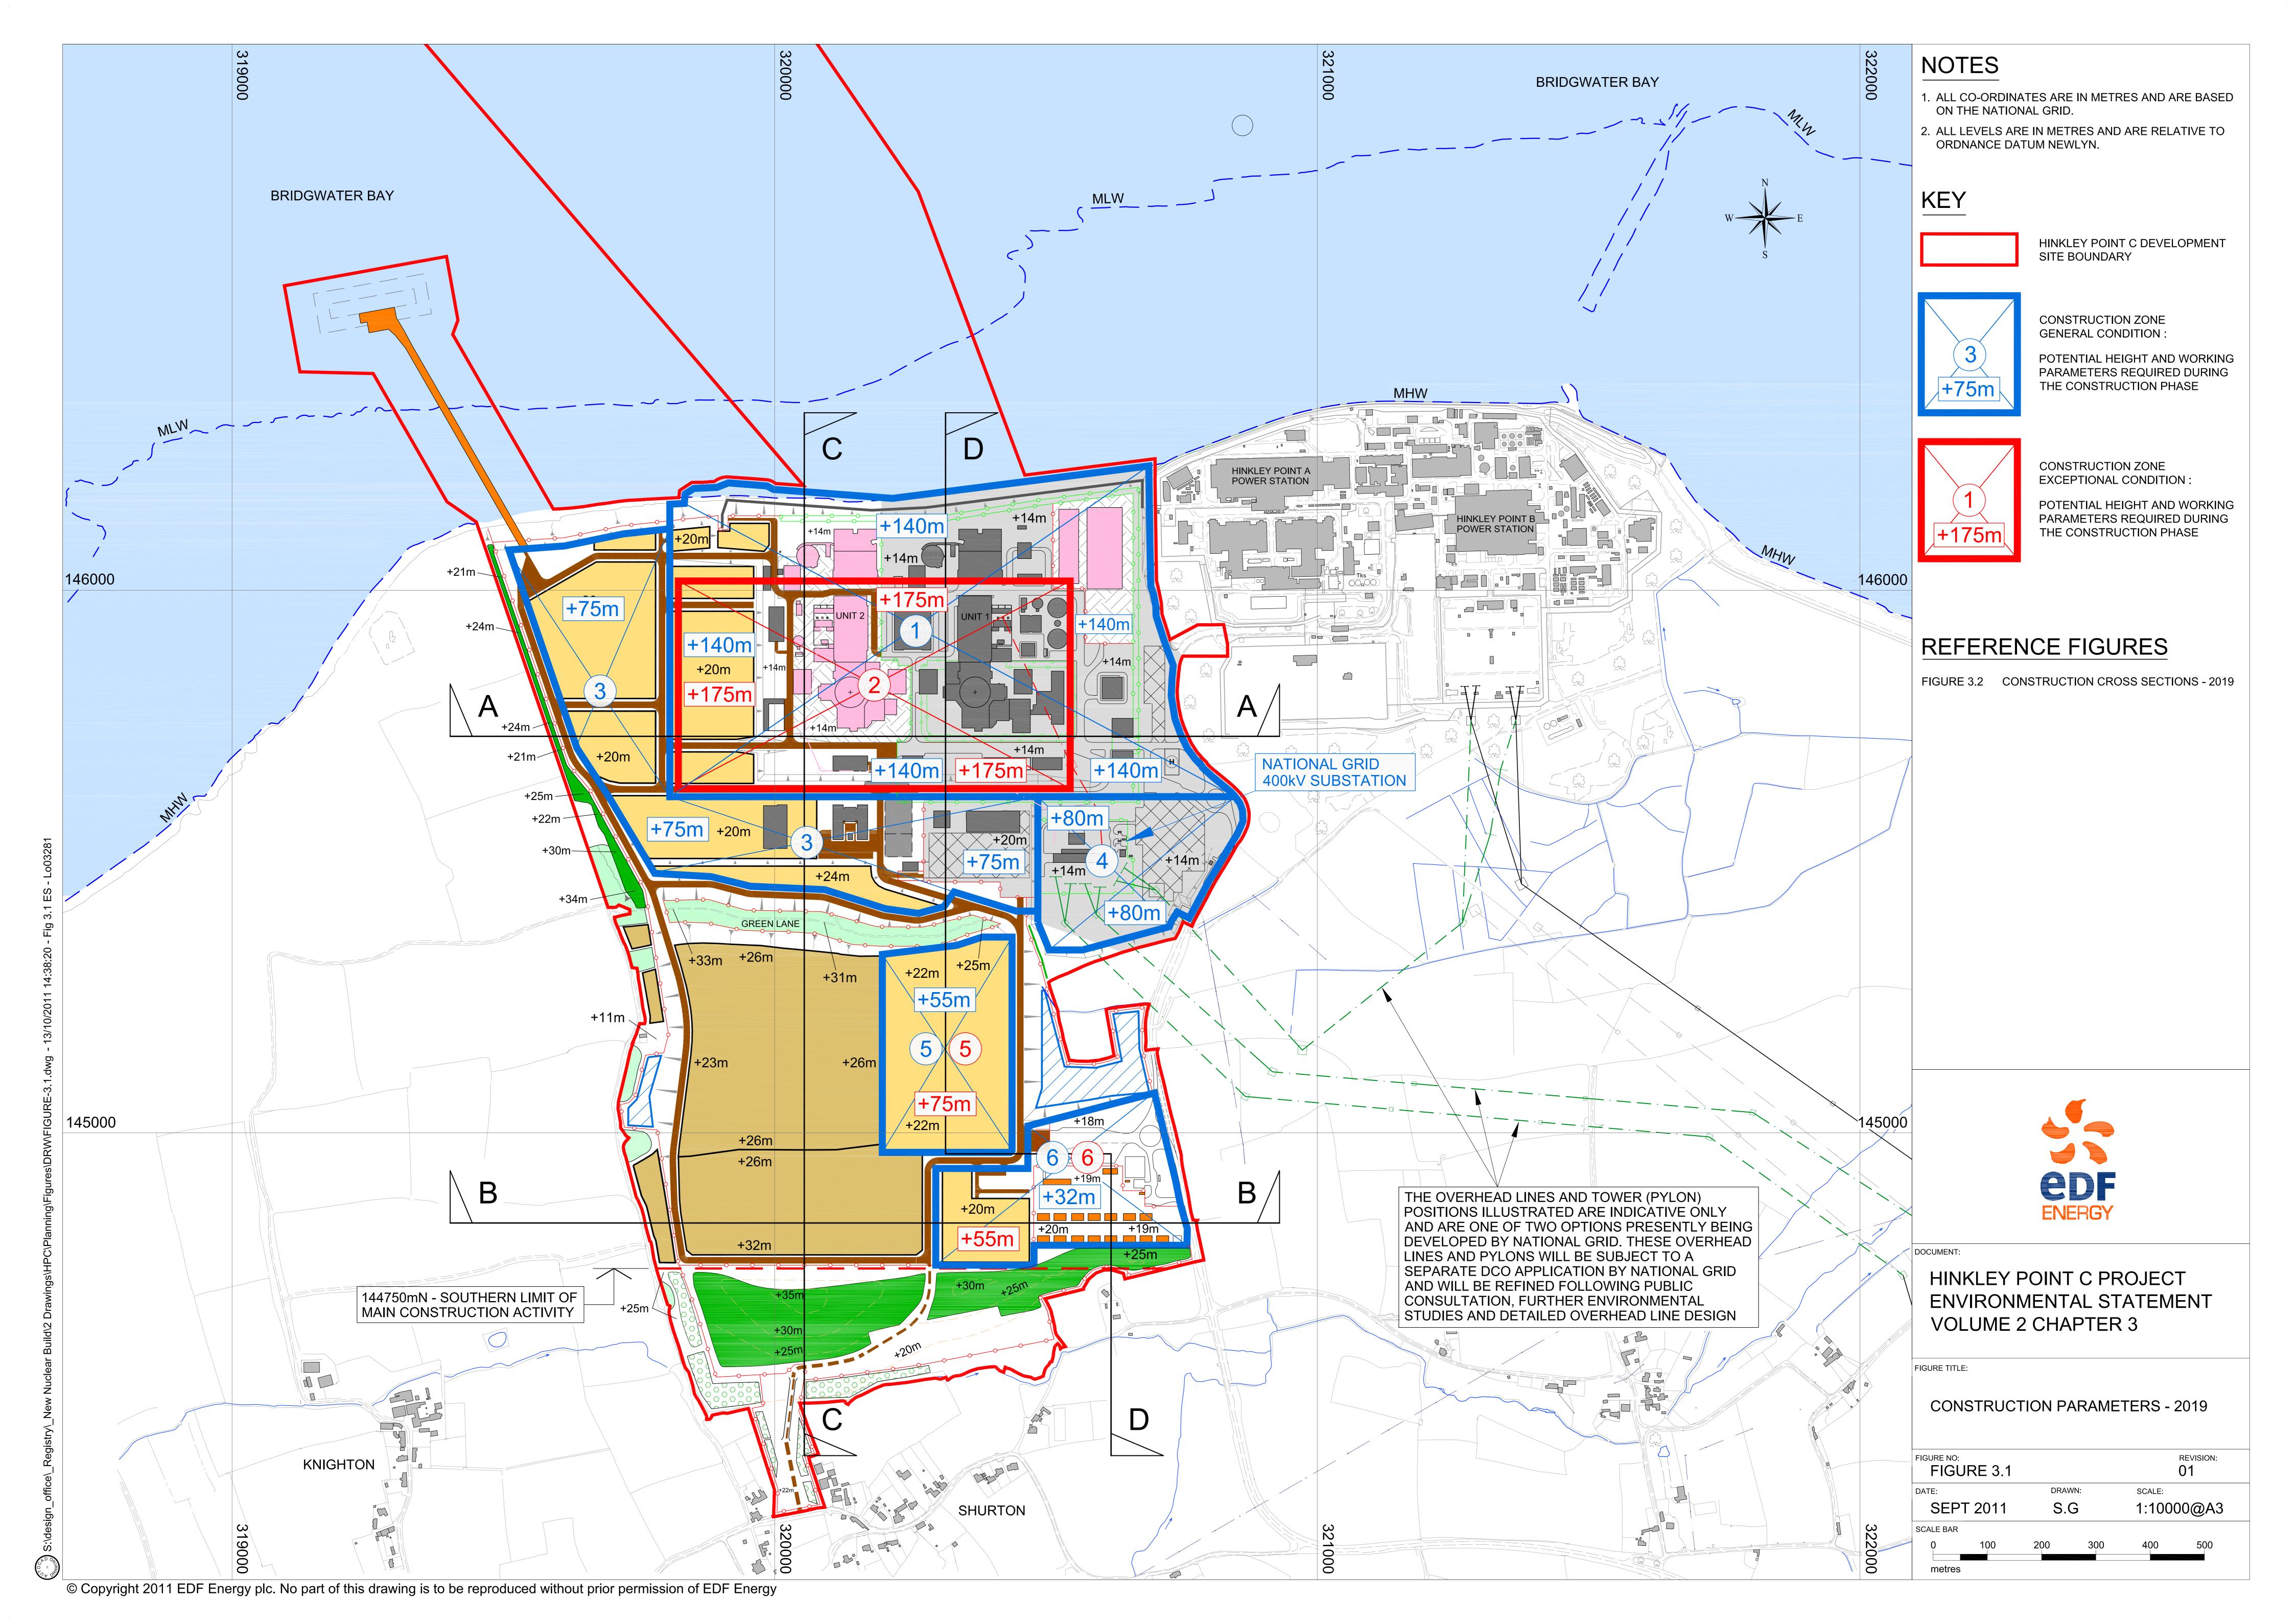


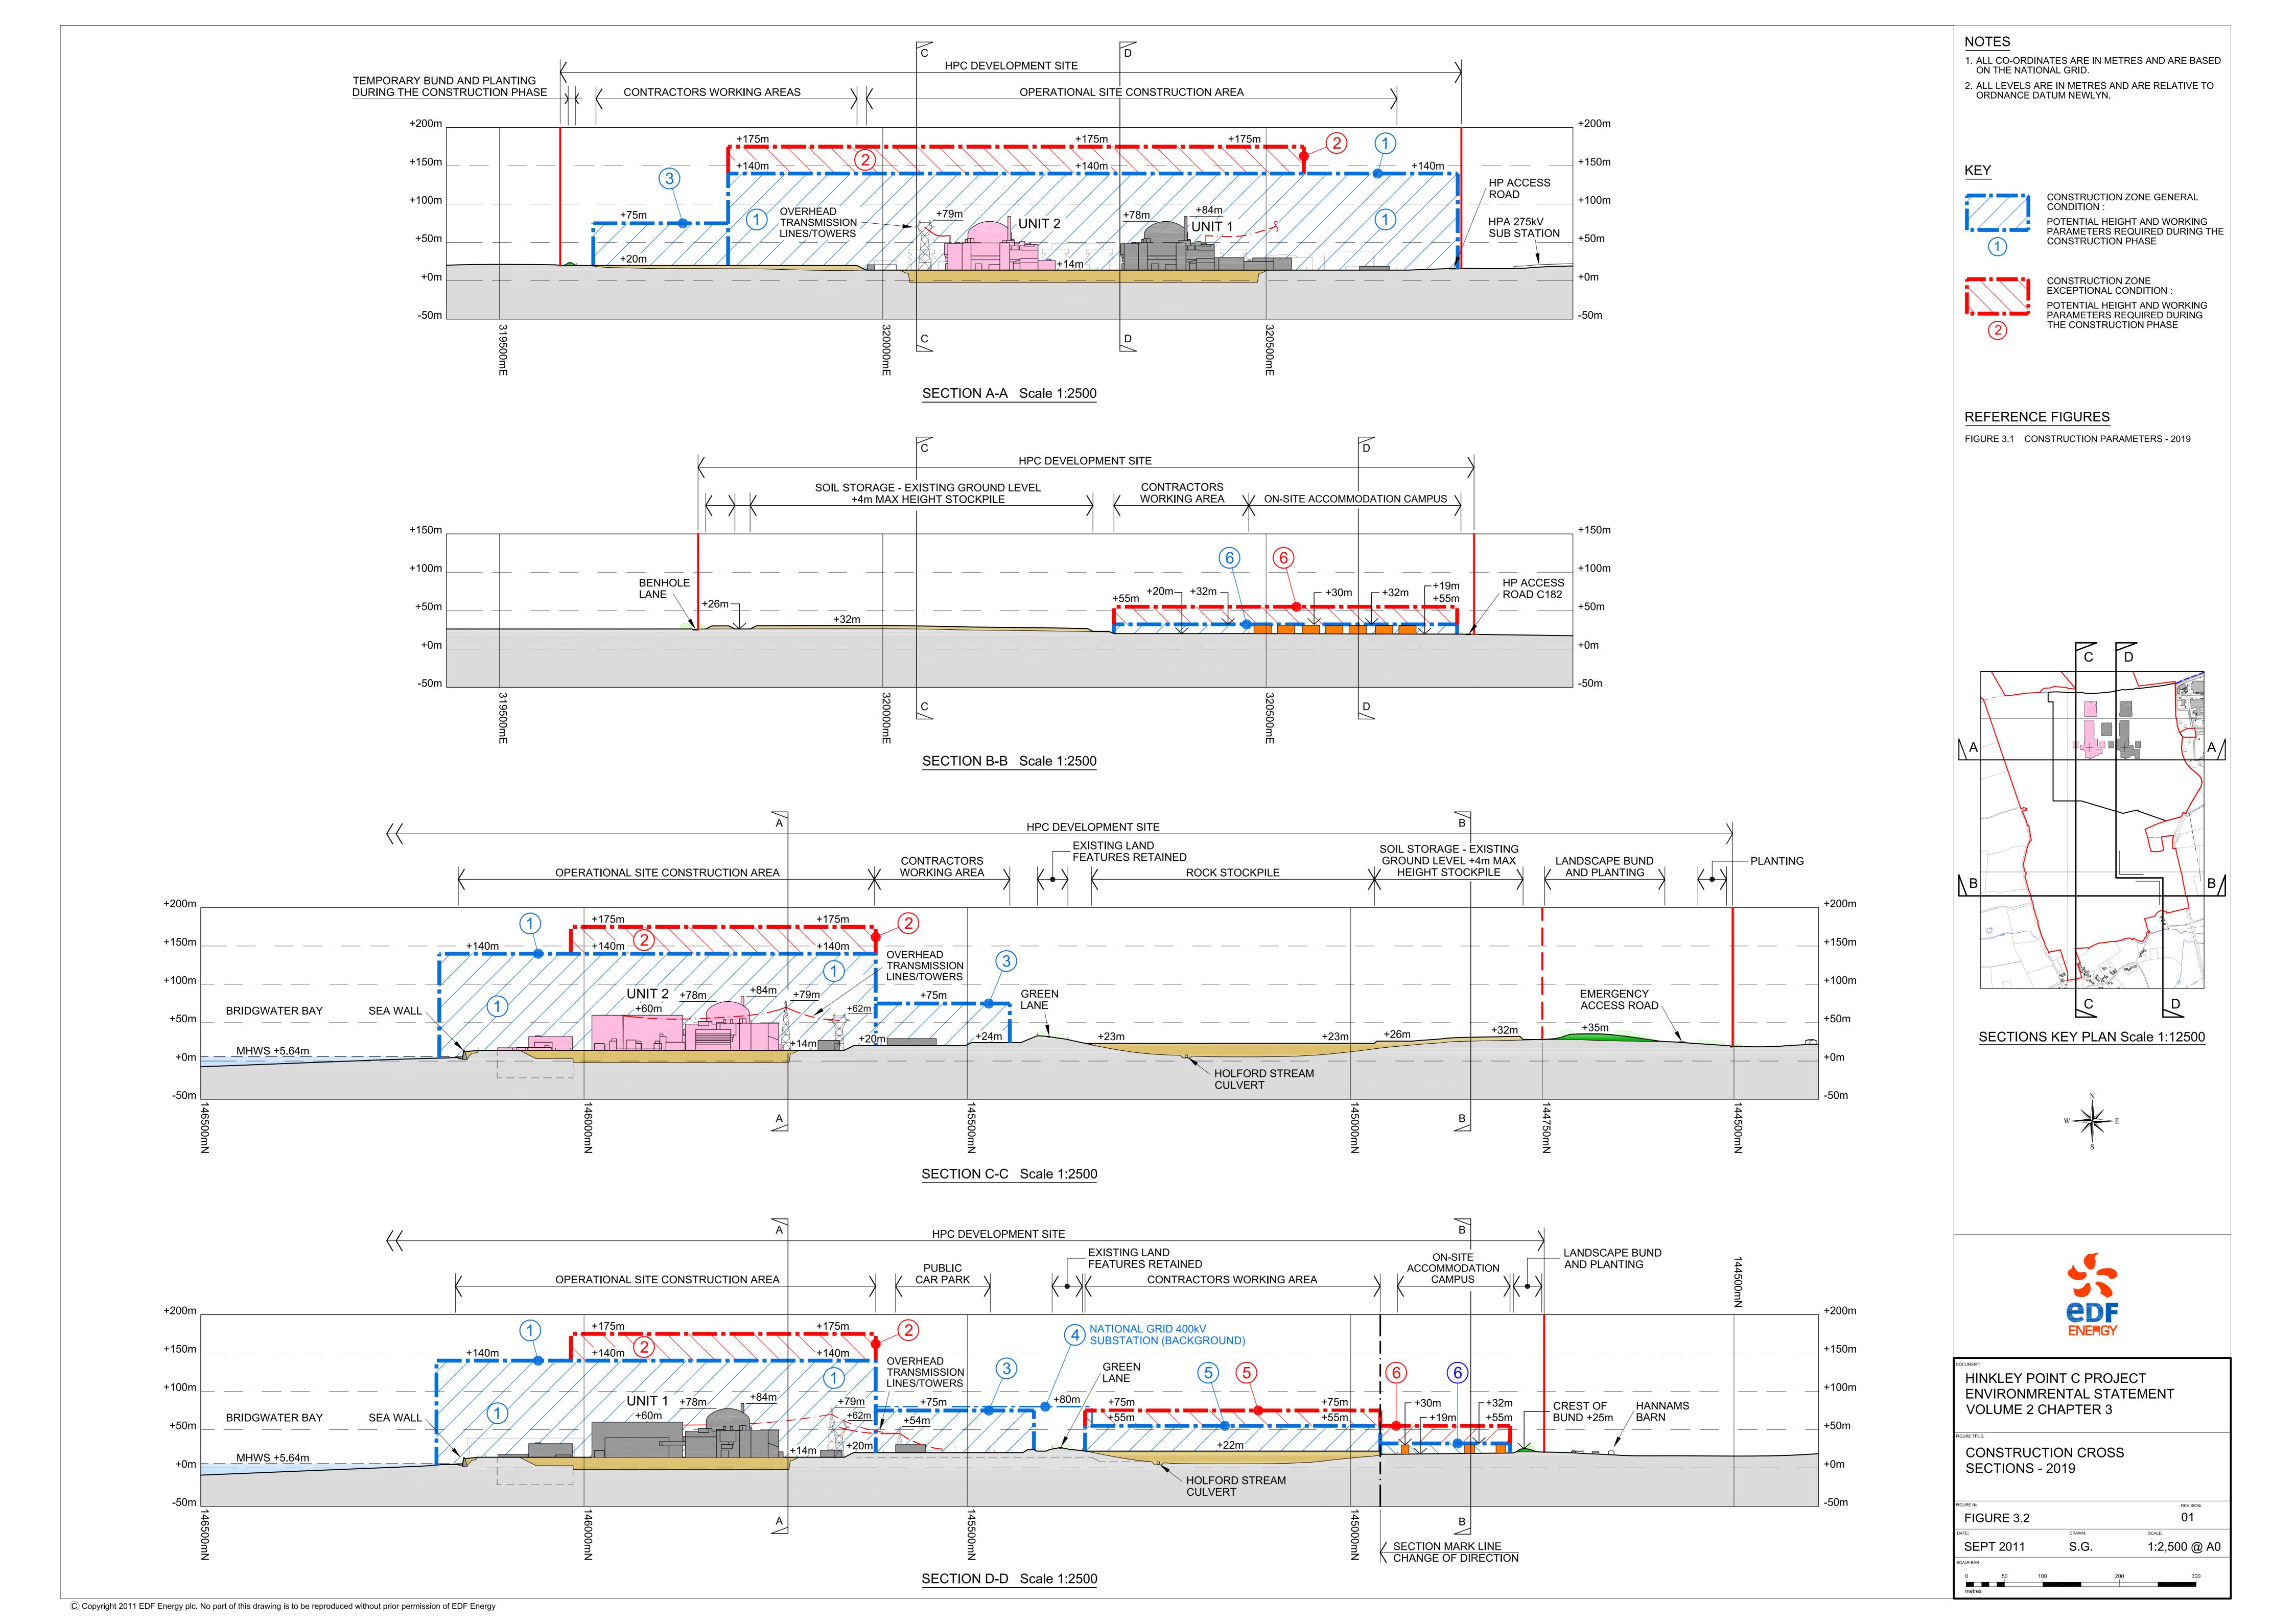
















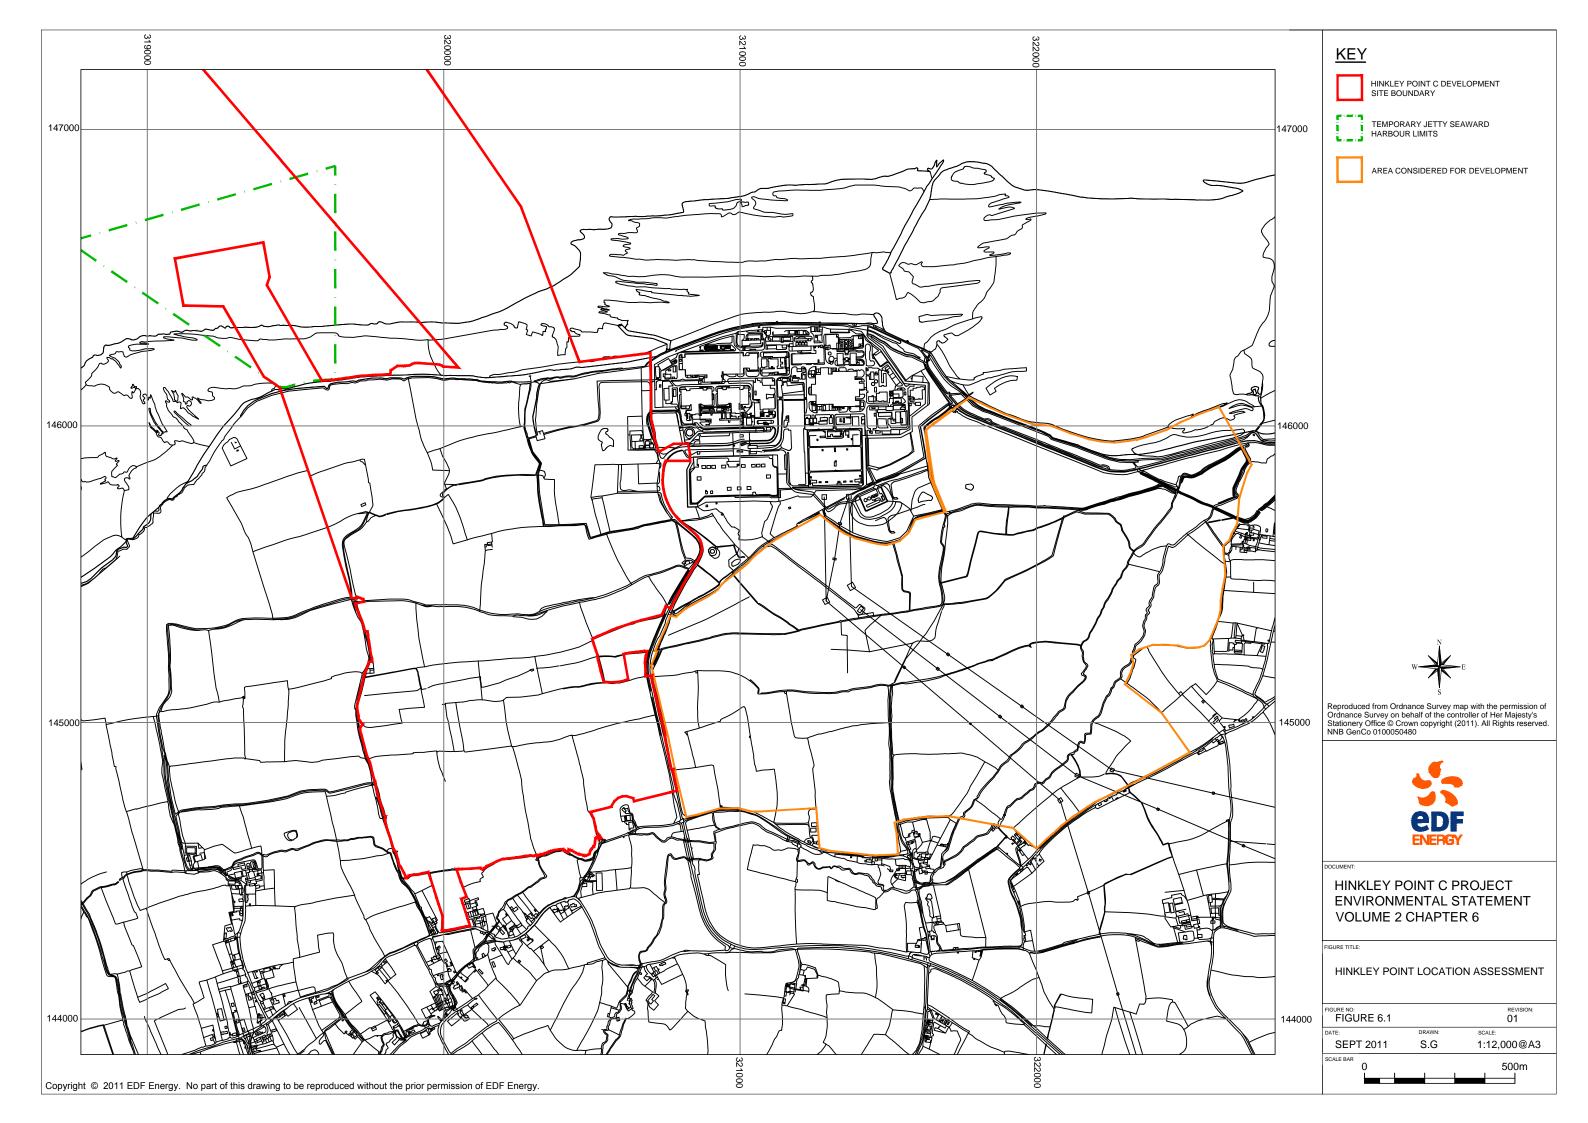
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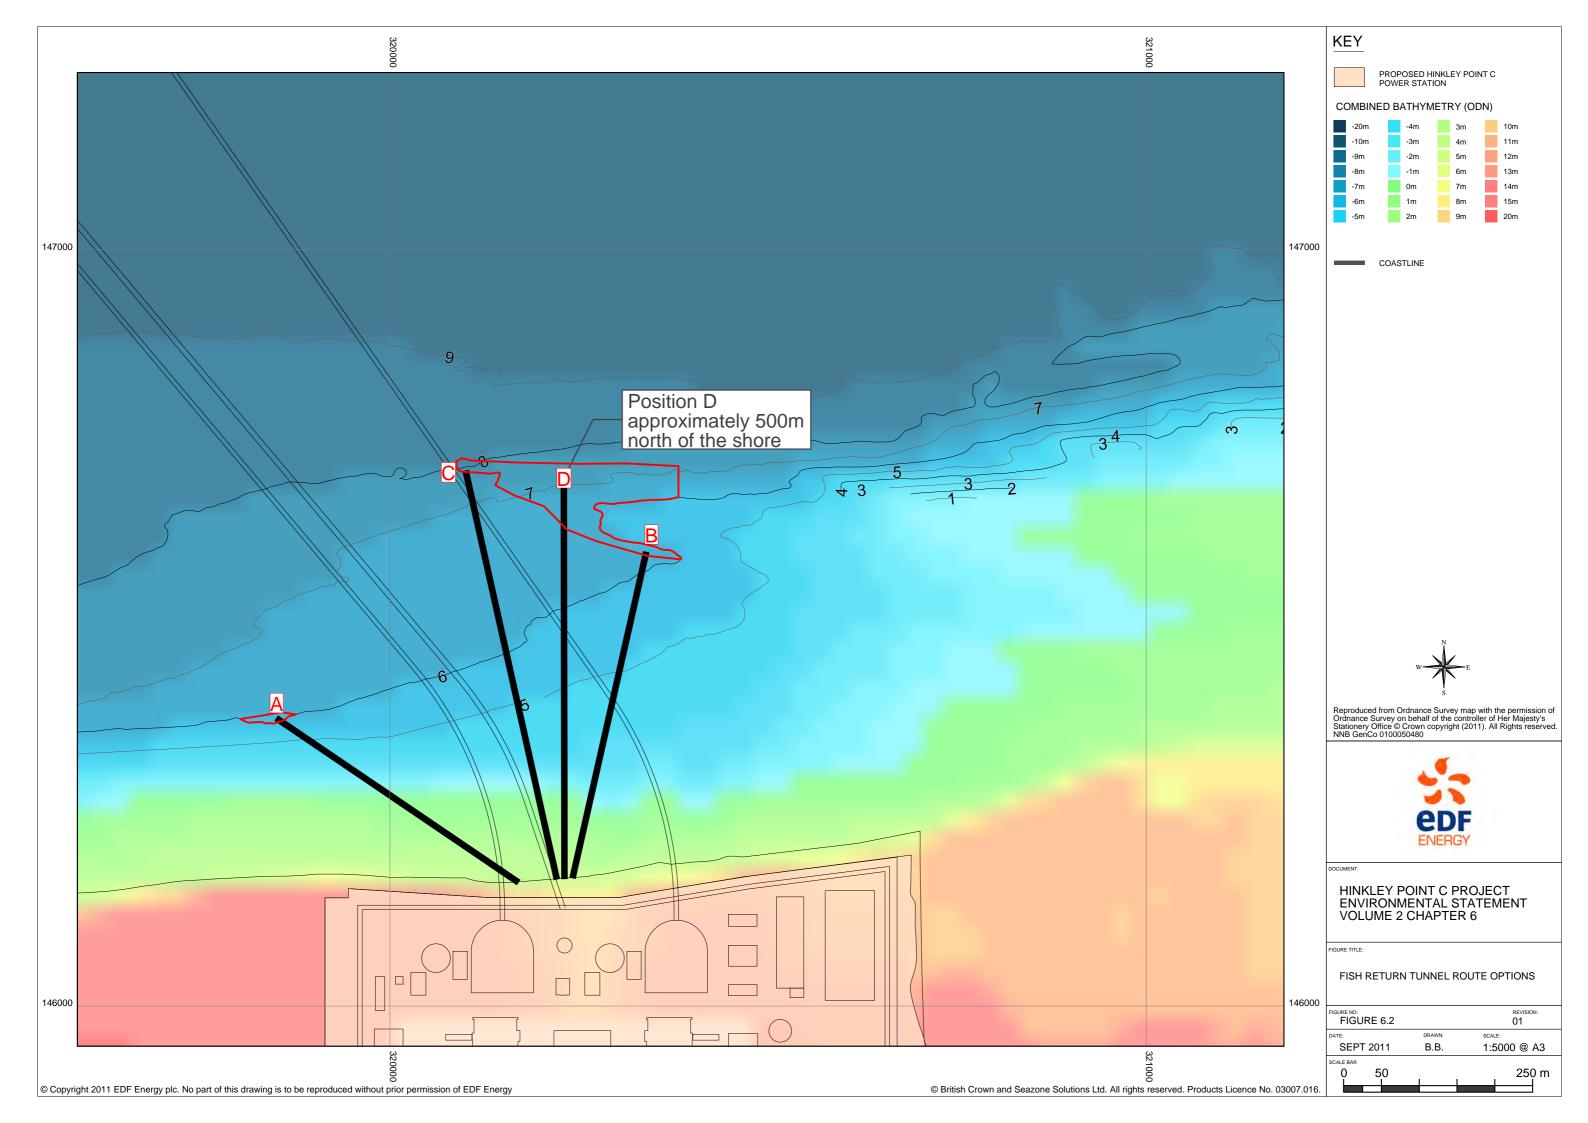



HINKLEY POINT C PROJECT **ENVIRONMENTAL STATEMENT VOLUME 2 CHAPTER 3**

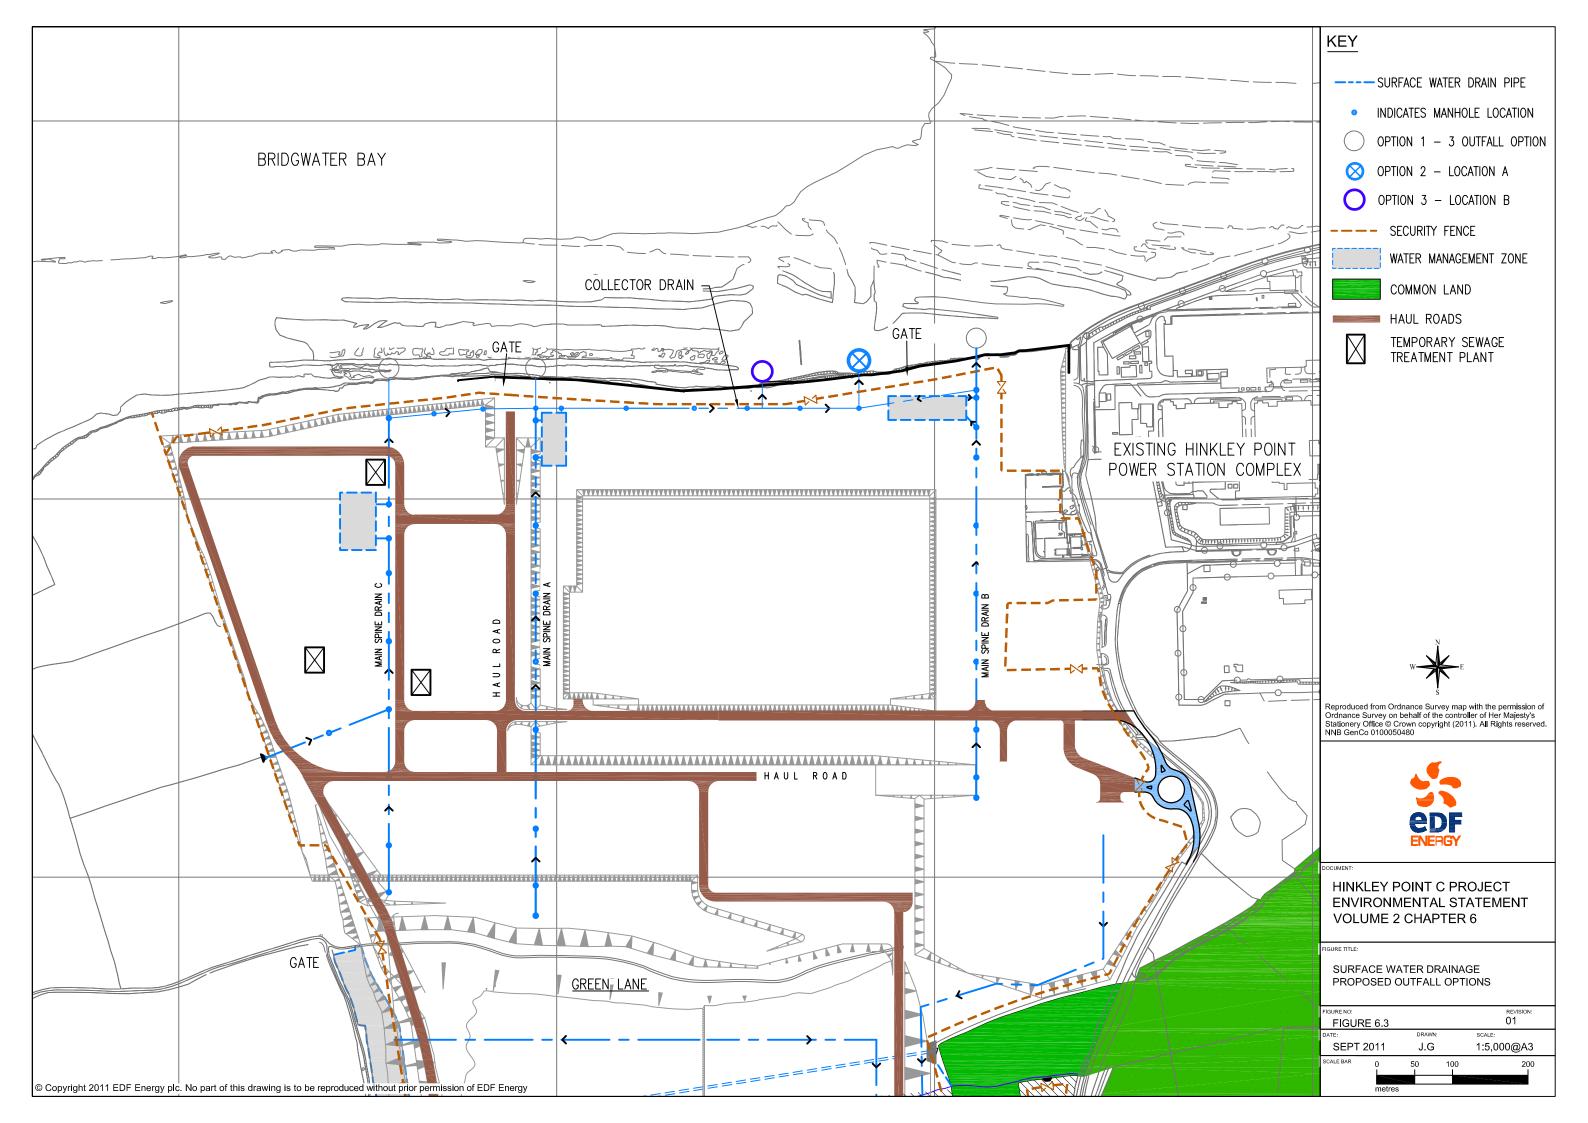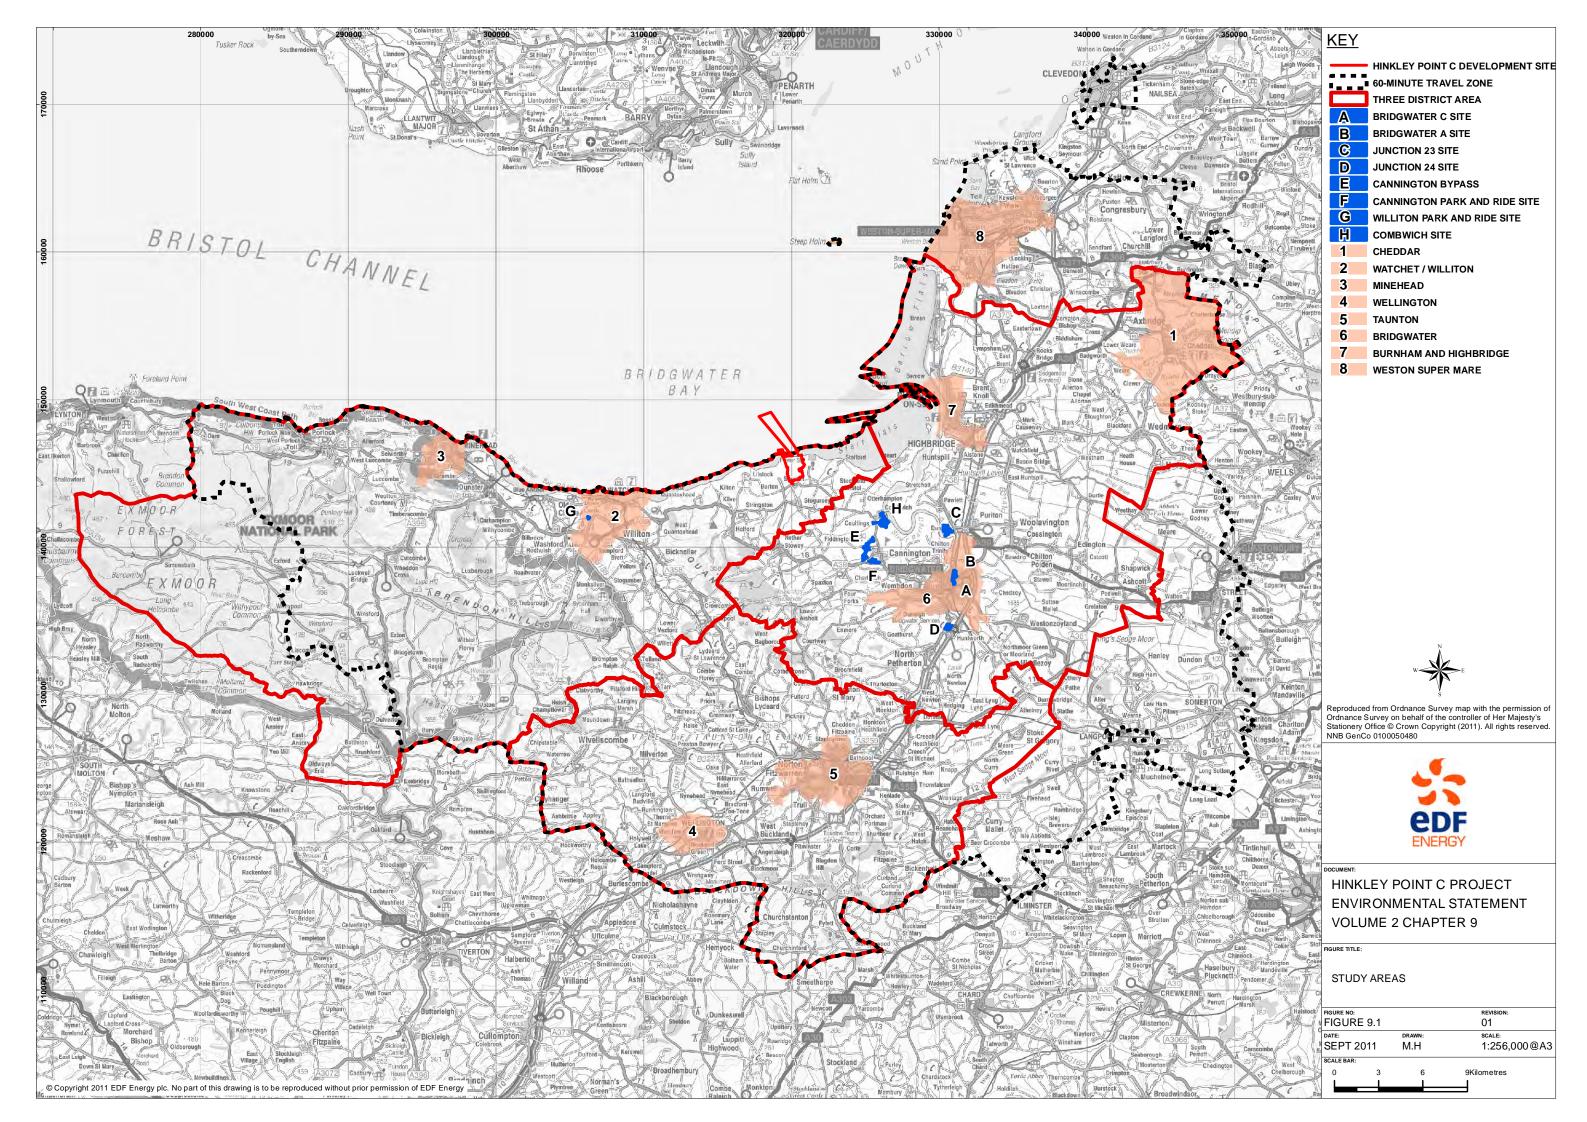
MASTERPLAN OF THE HPC ACCOMMODATION CAMPUS

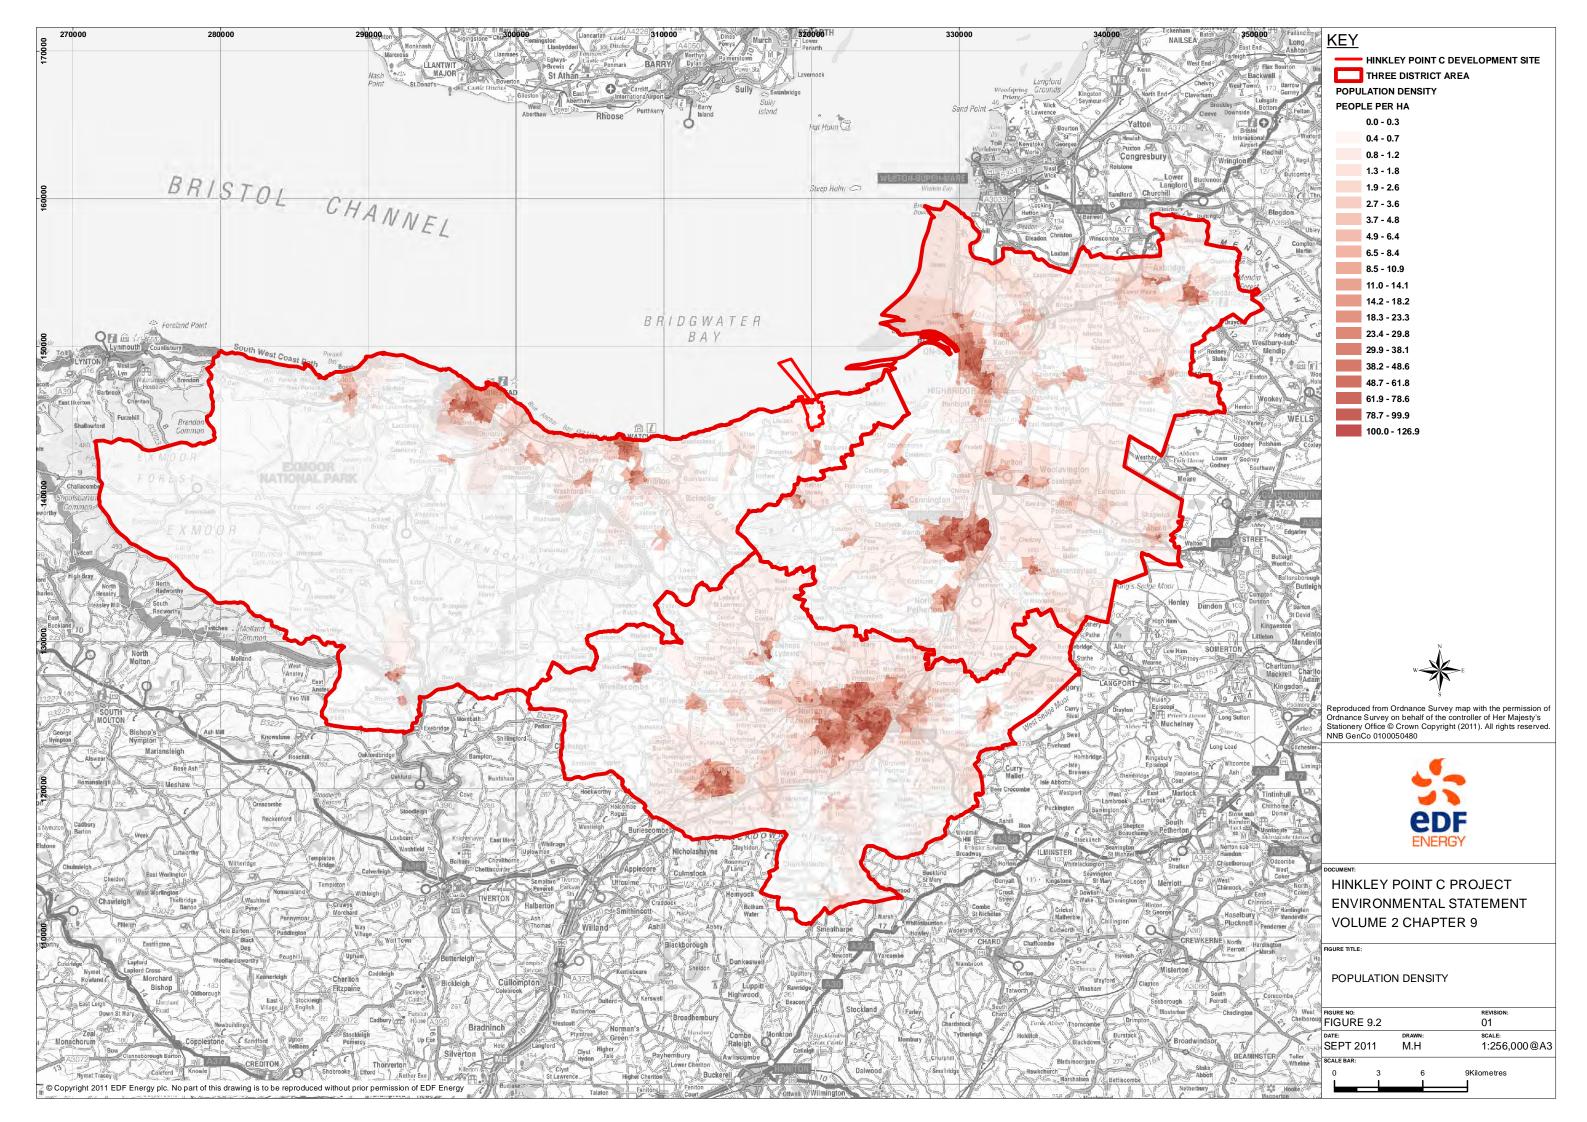
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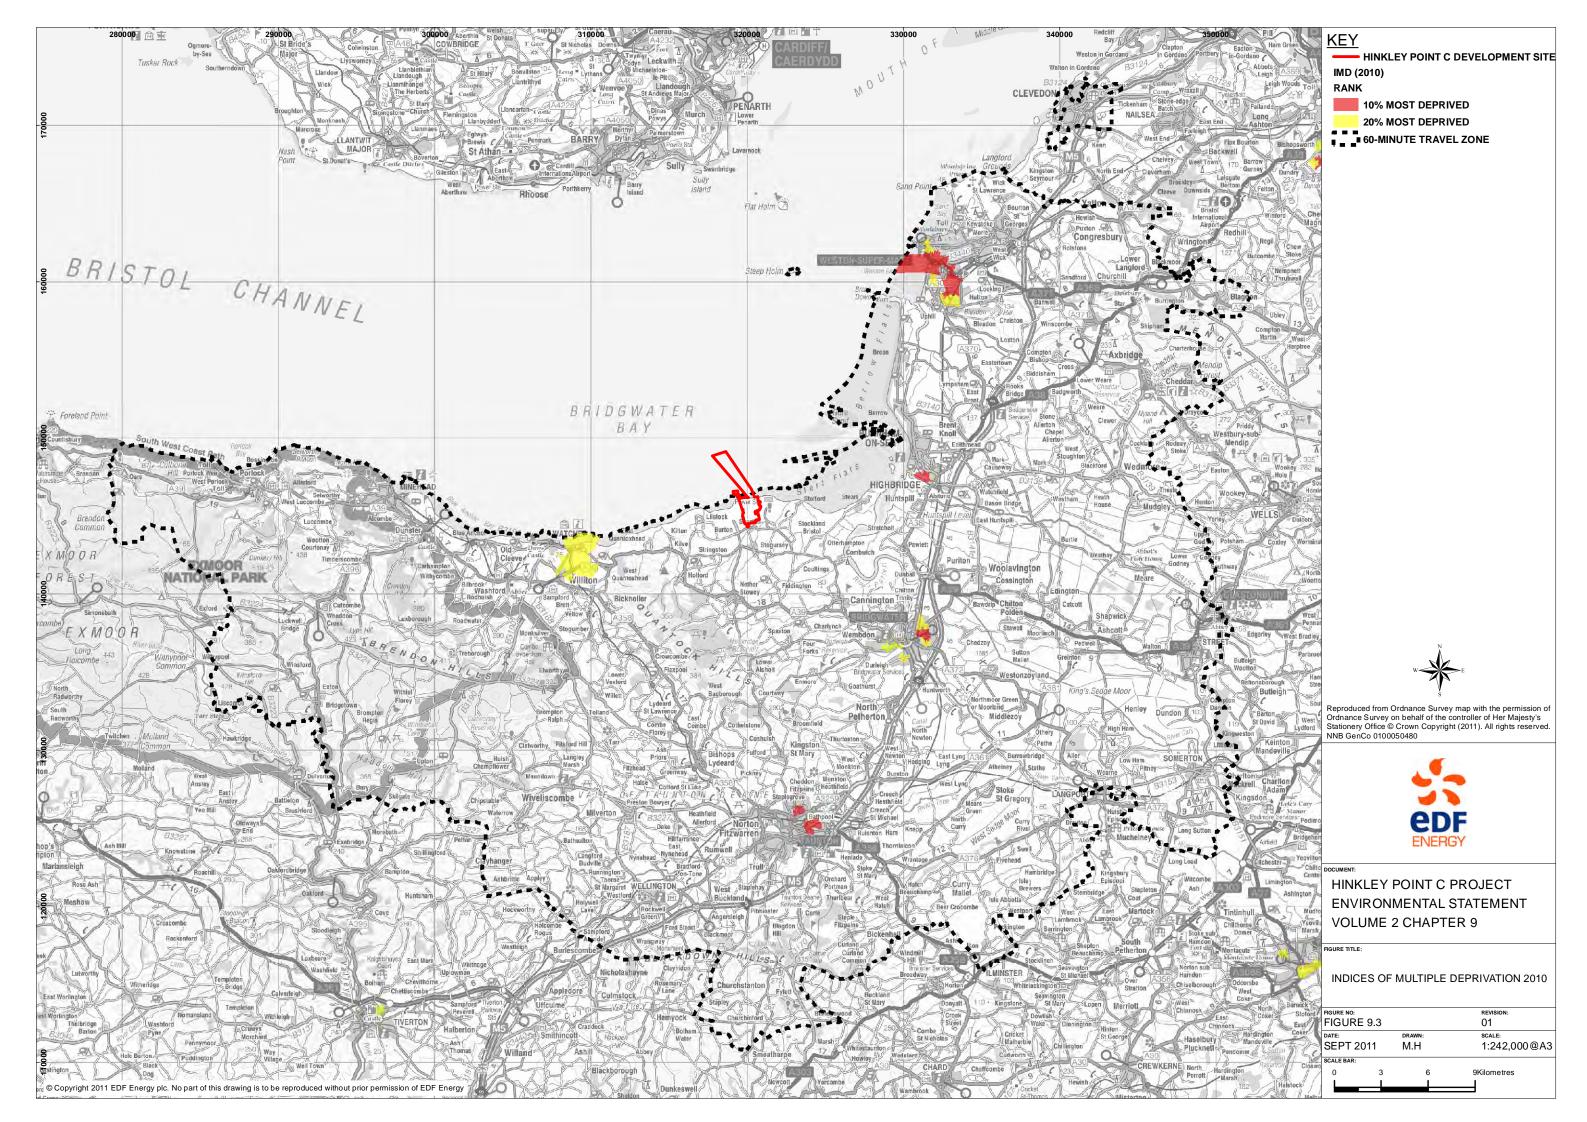


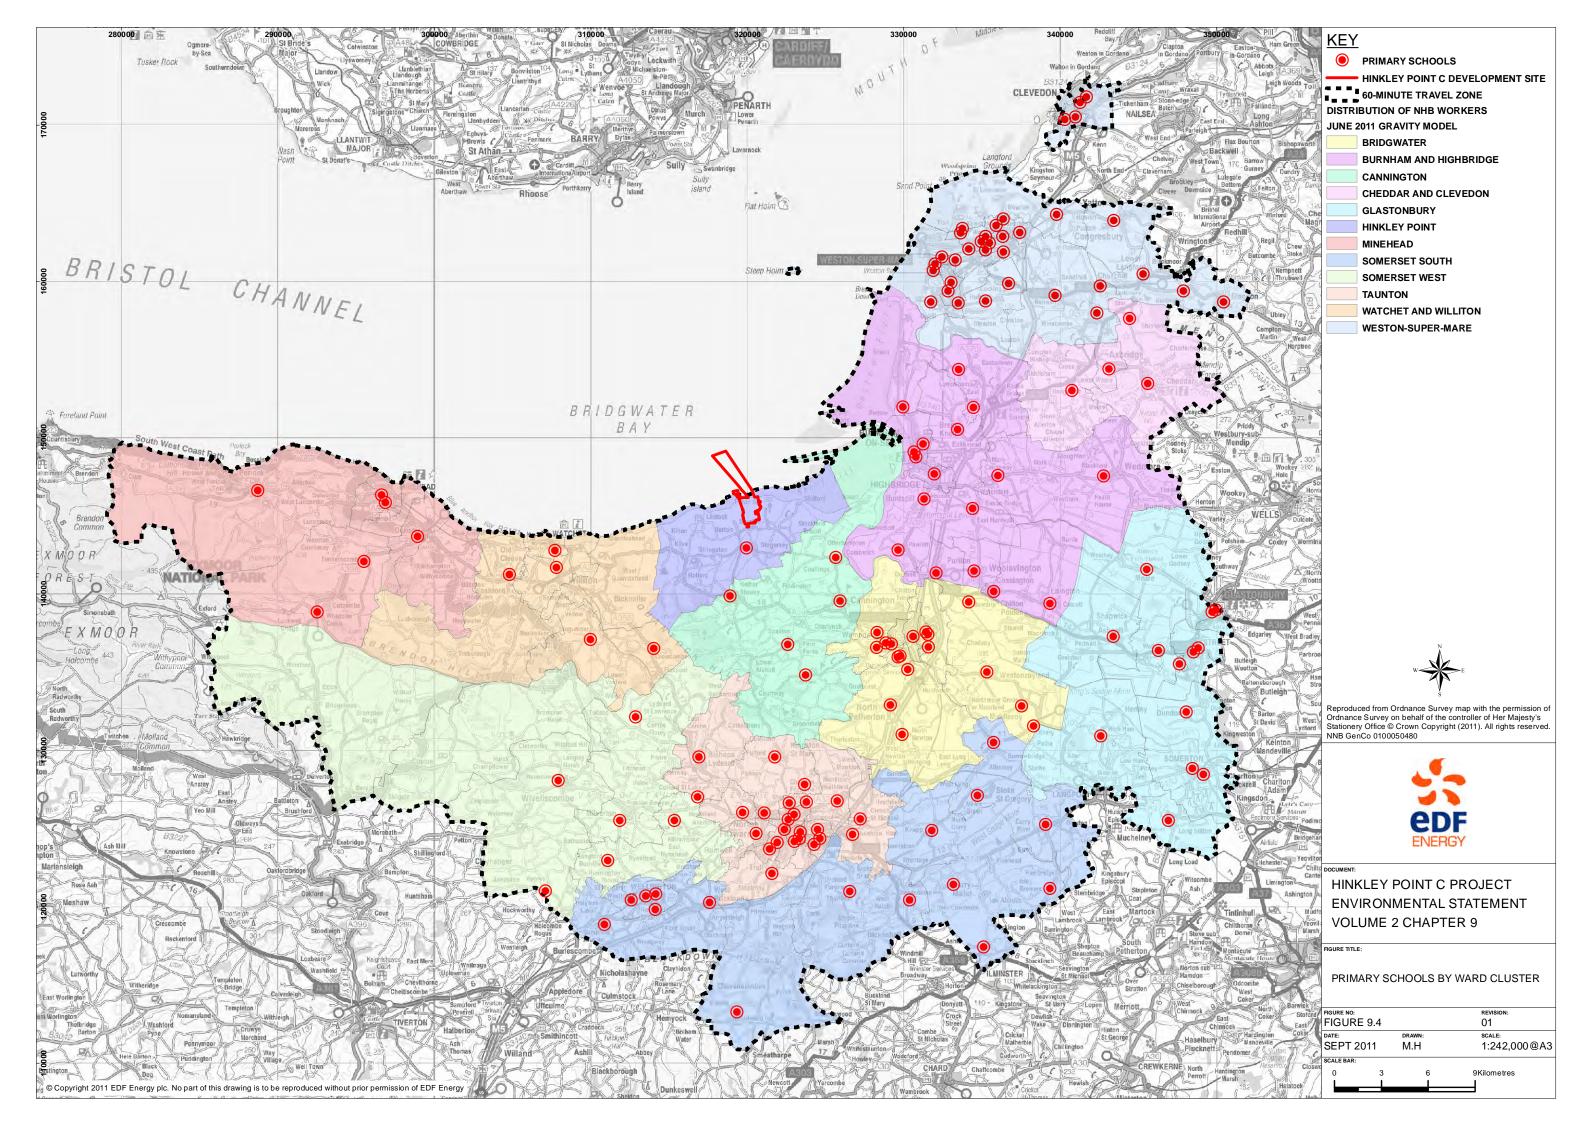


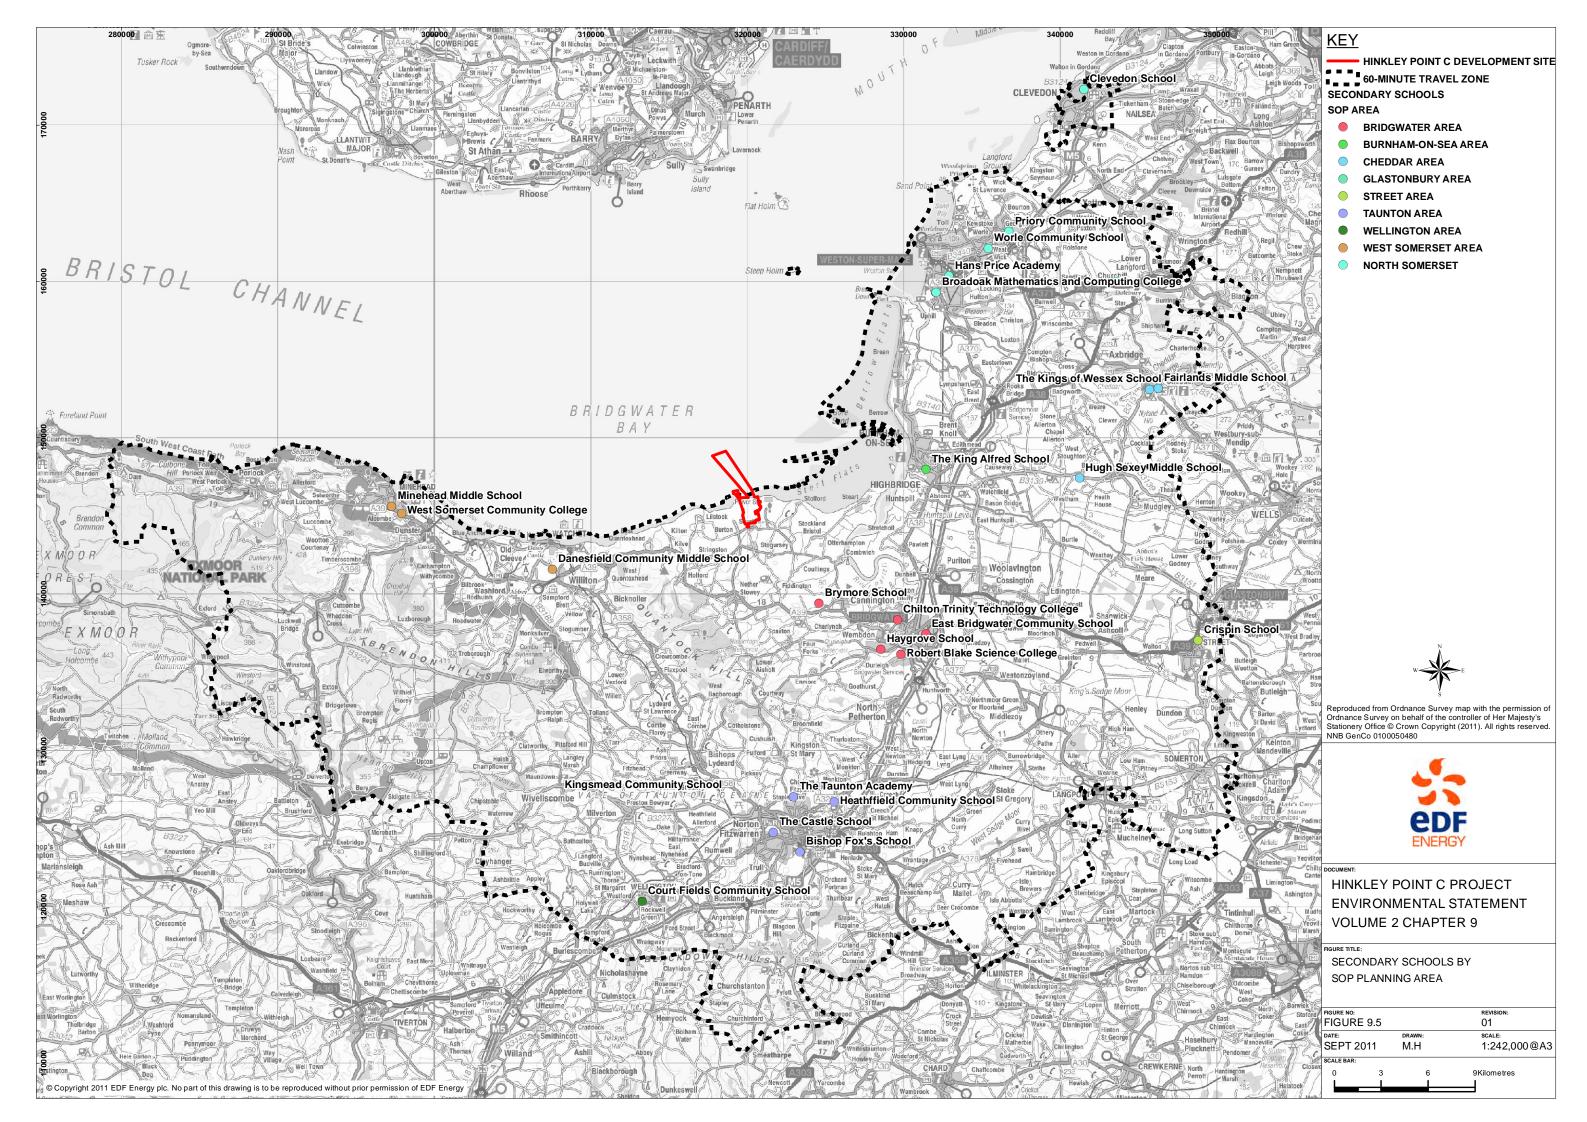


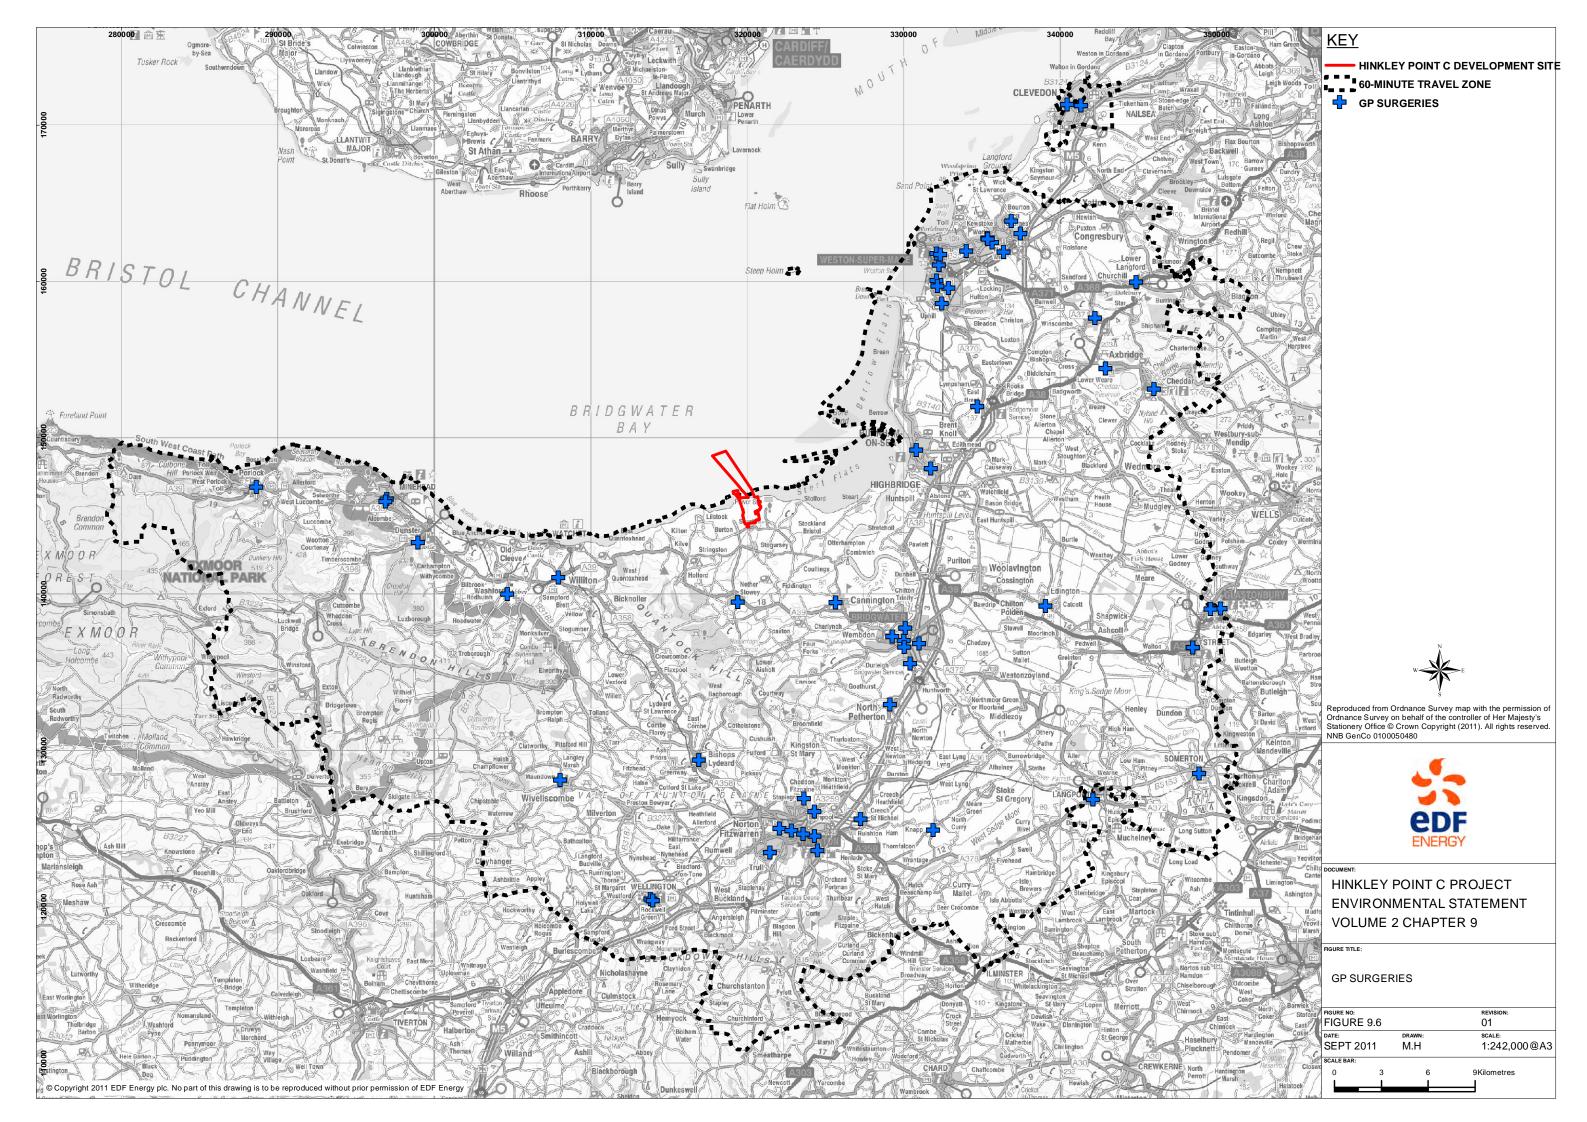


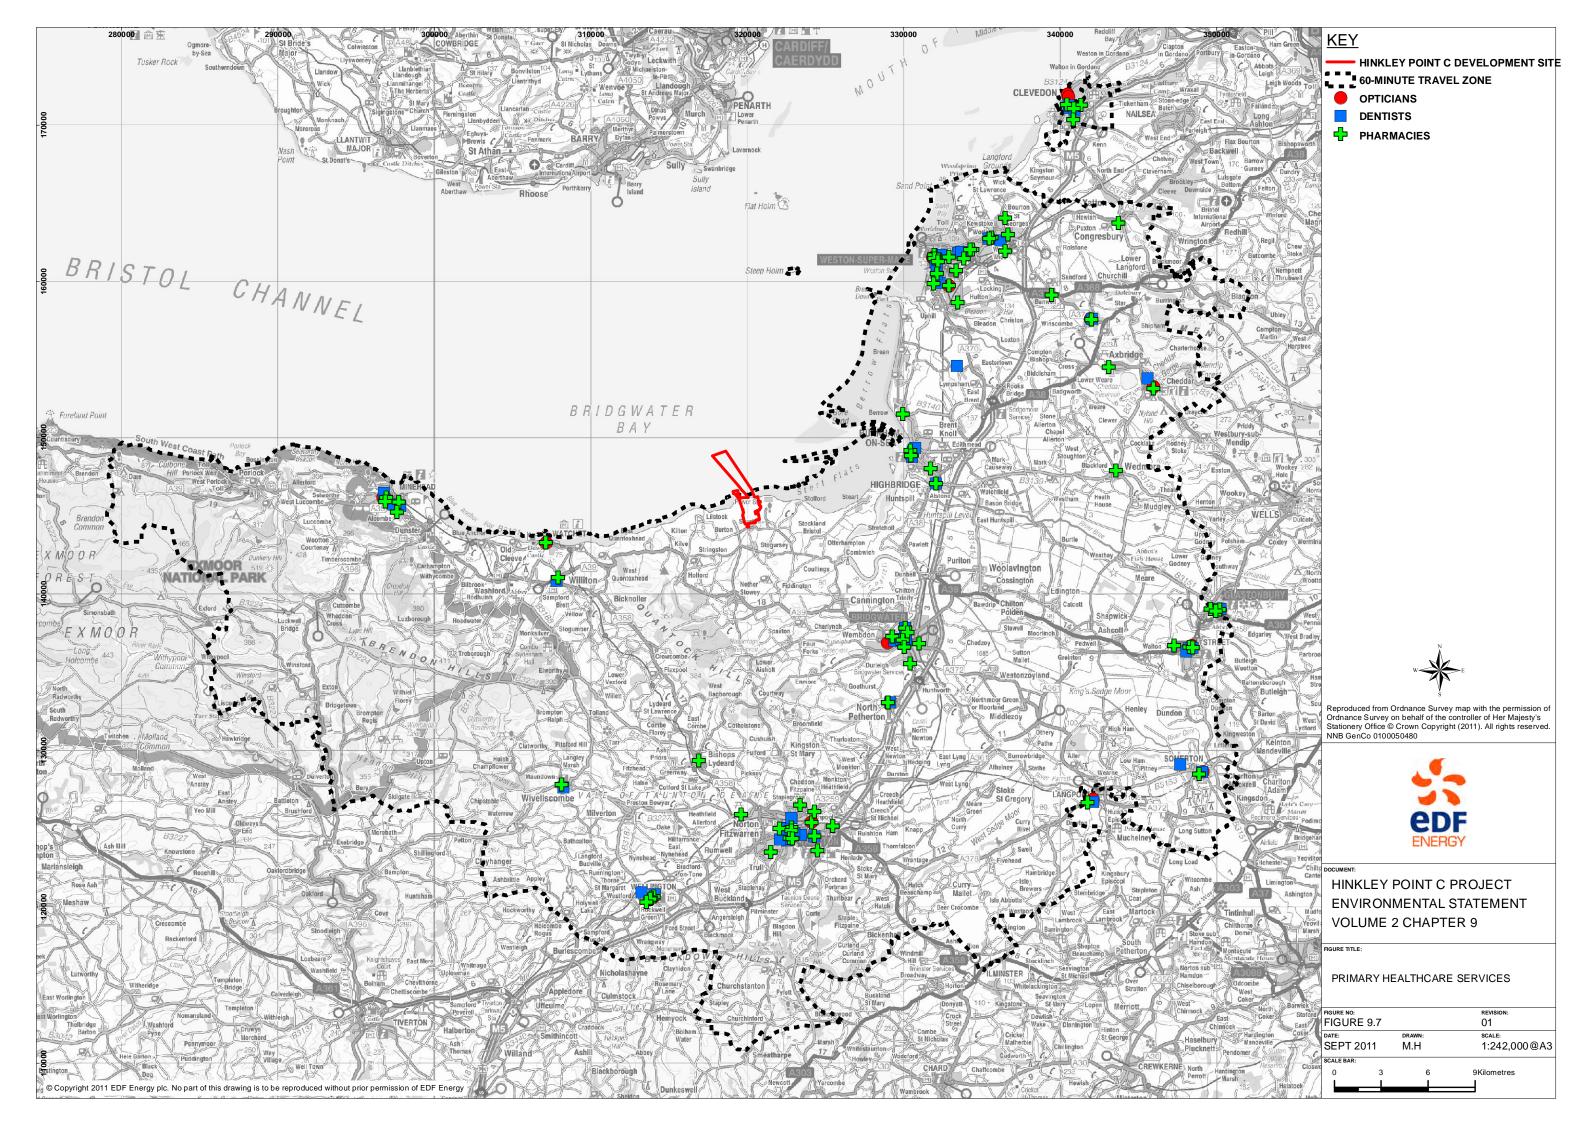


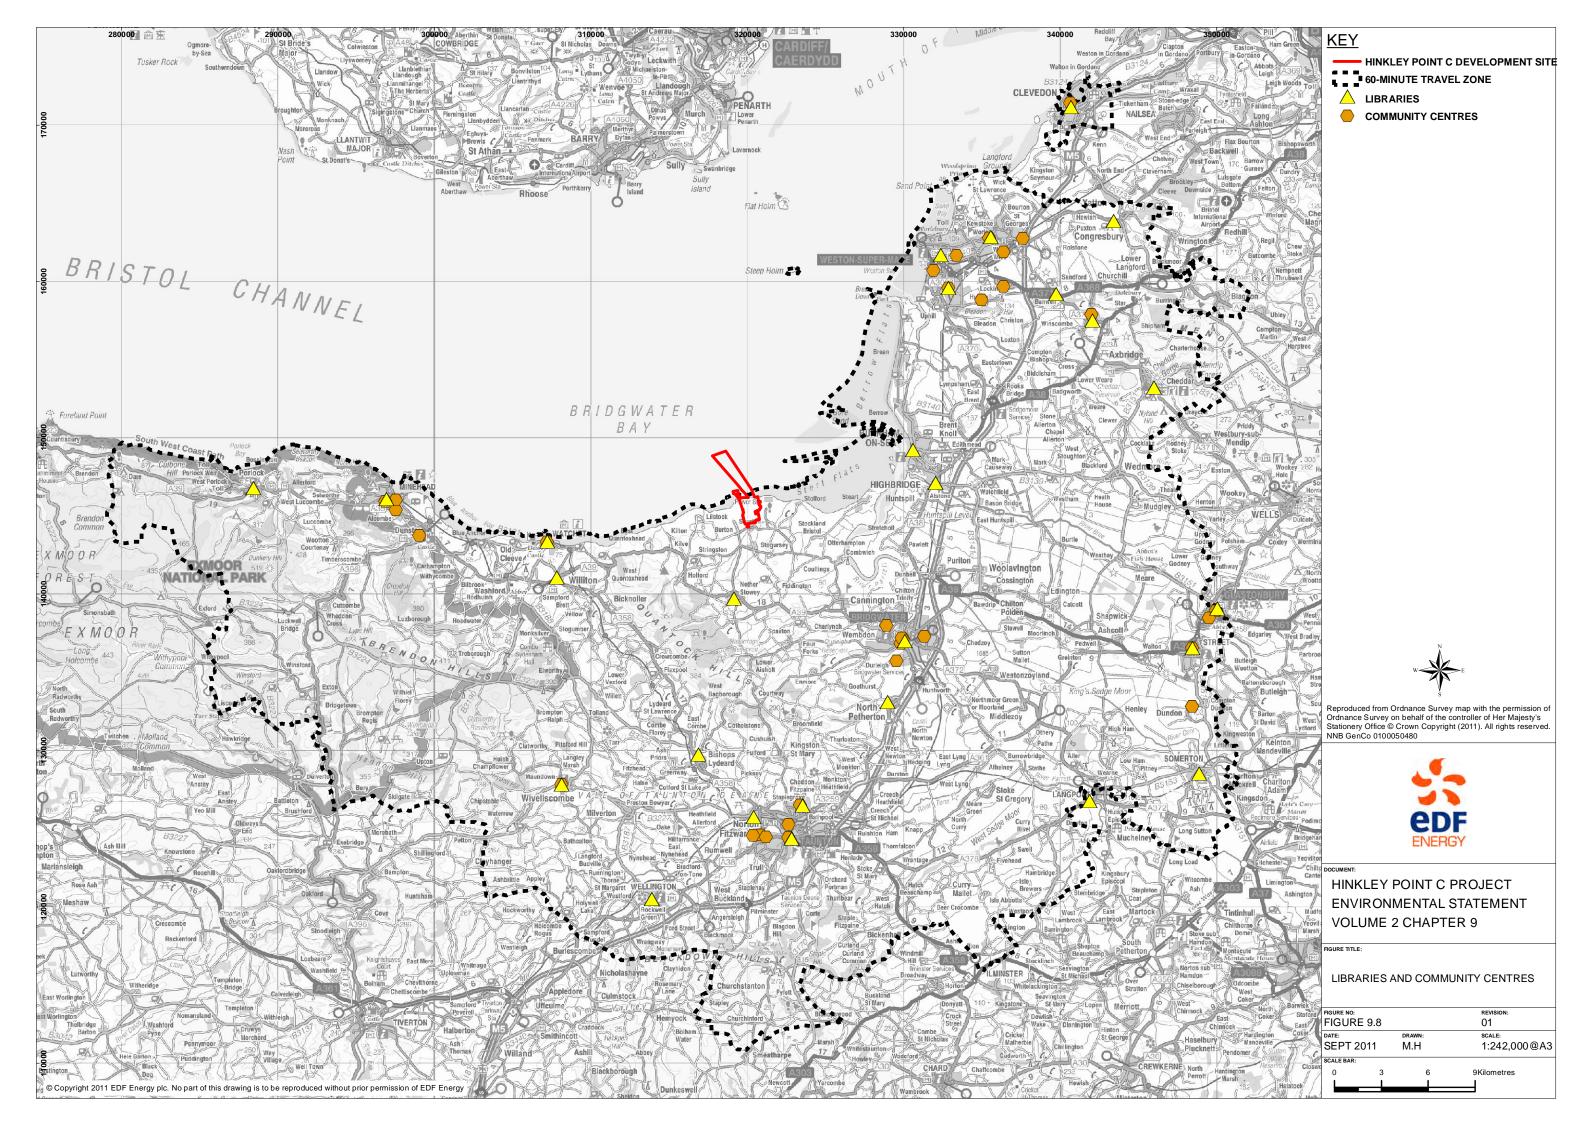


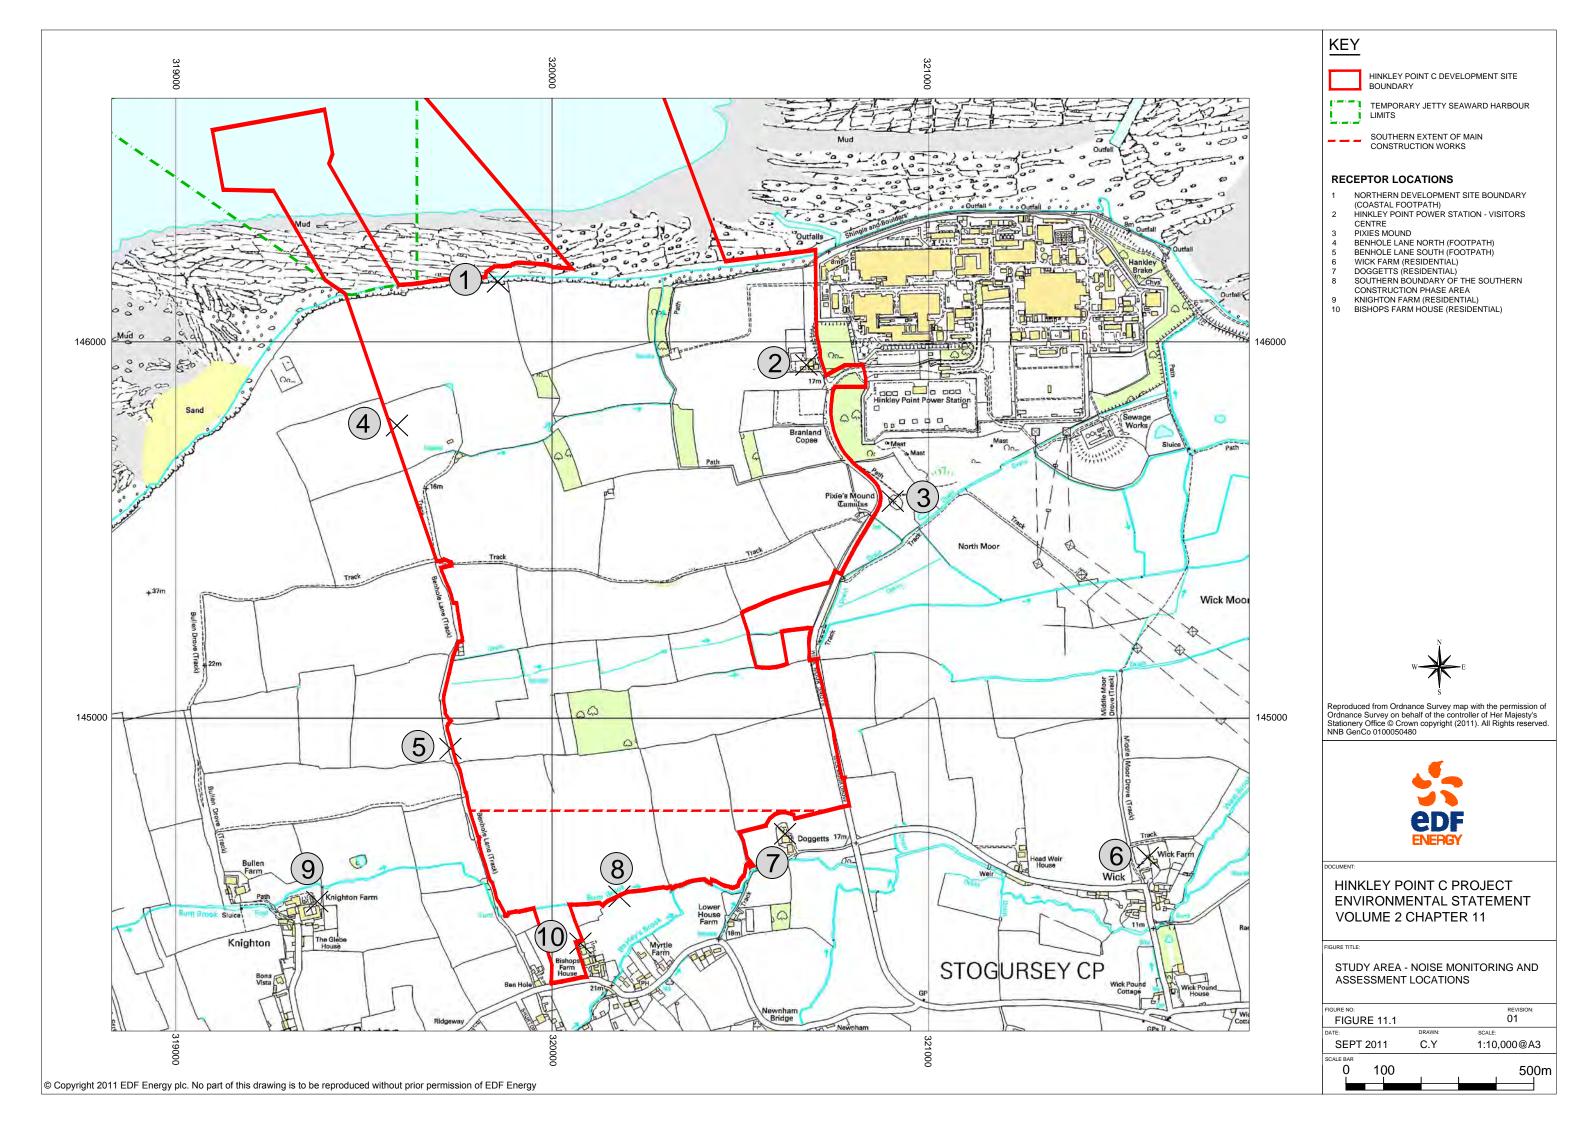


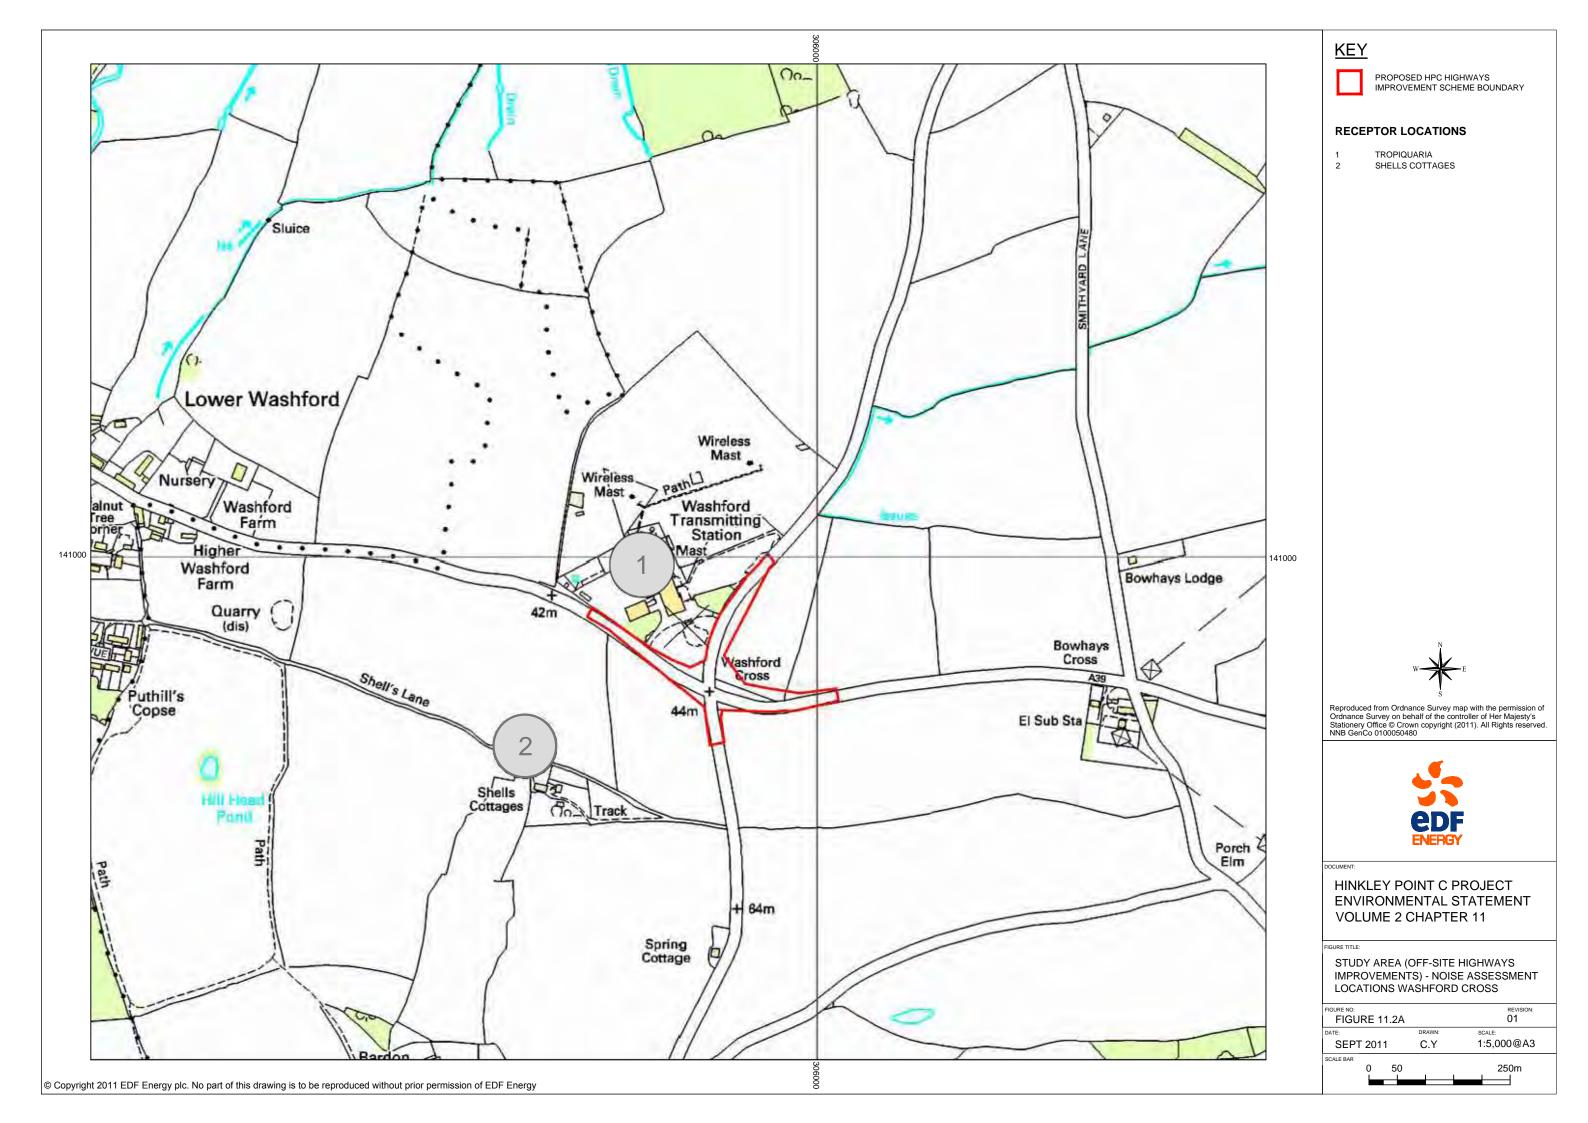


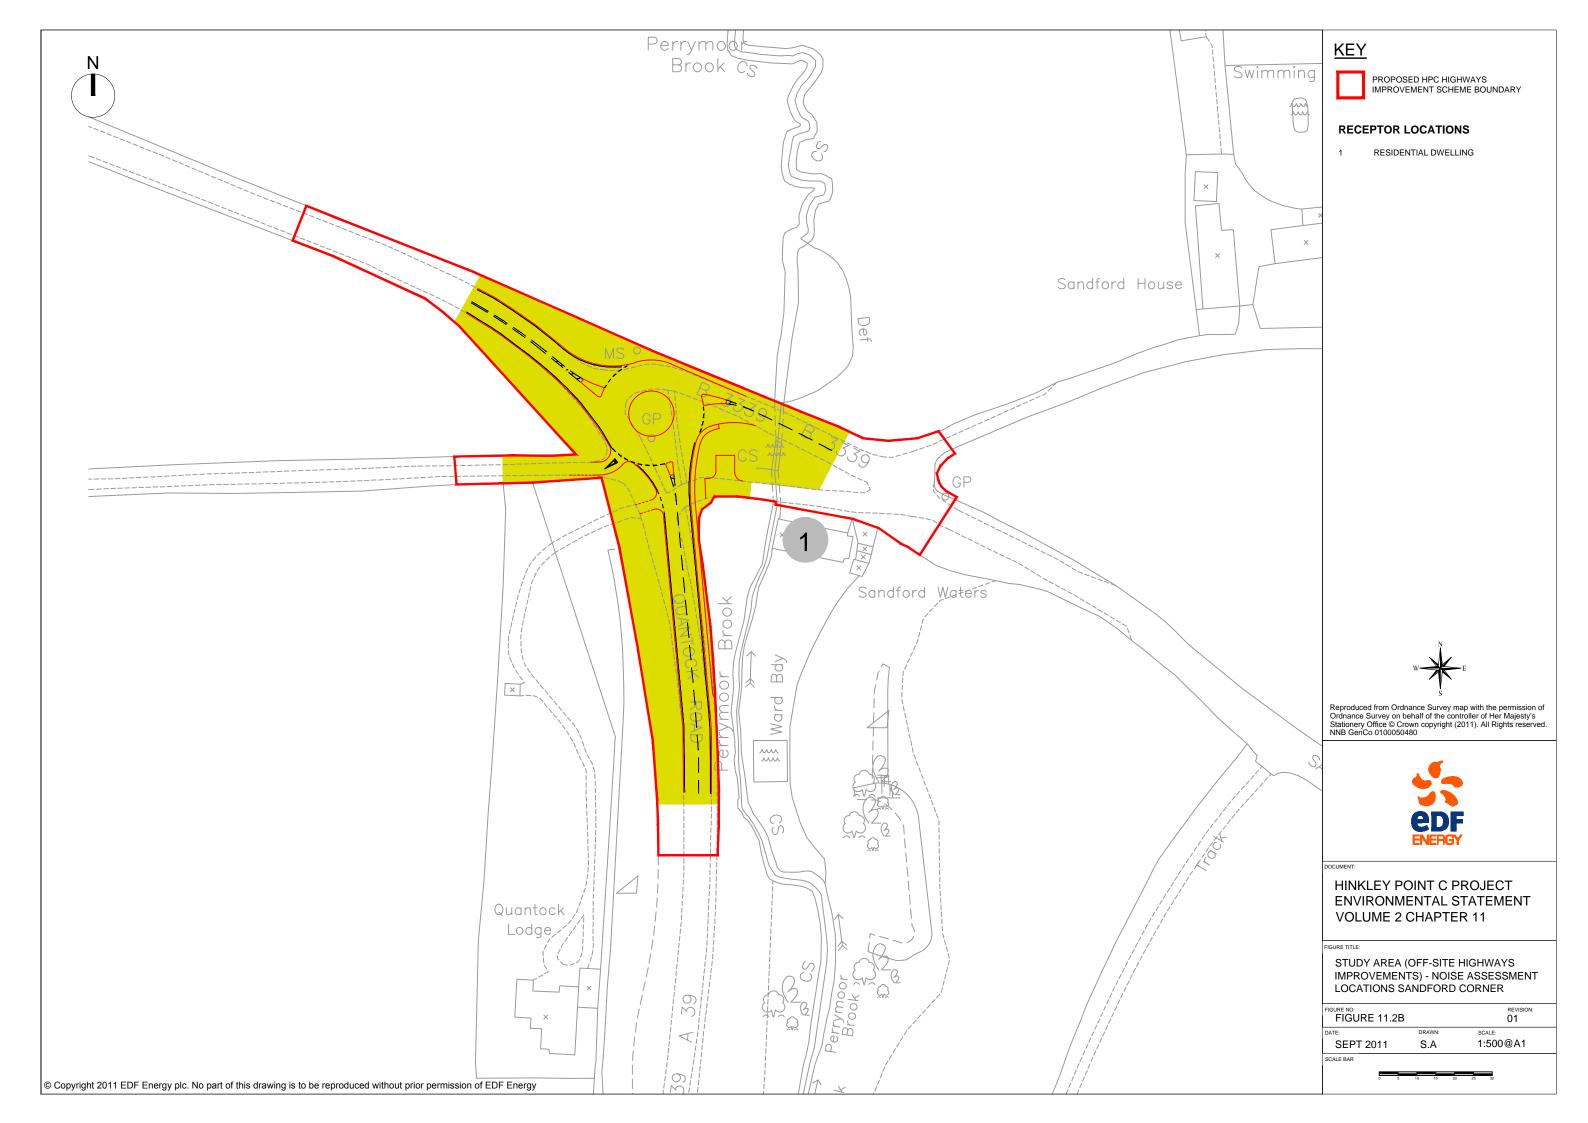


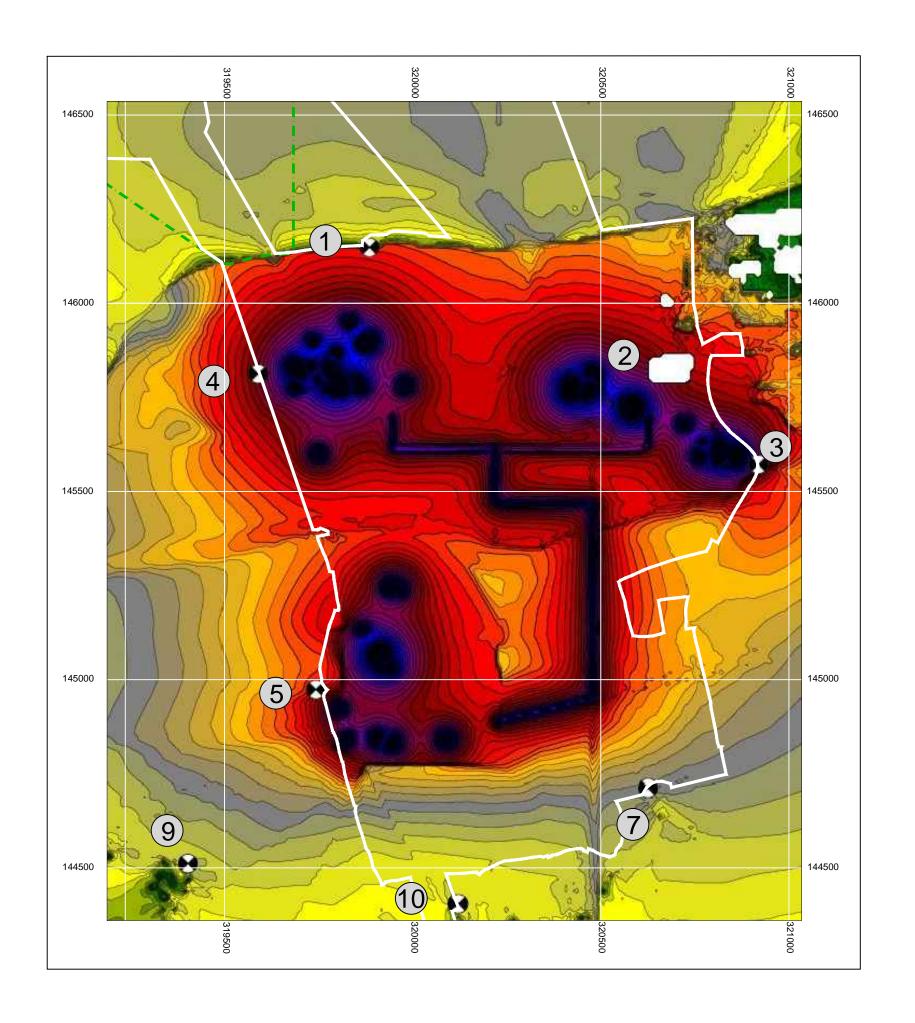



















TEMPORARY JETTY SEAWARD HARBOUR

RECEPTOR LOCATIONS

- NORTHERN DEVELOPMENT SITE BOUNDARY (COASTAL FOOTPATH) HINKLEY POINT POWER STATION VISITORS
- CENTRE
- PIXIES MOUND
- PIXIES MOUND
 BENHOLE LANE NORTH (FOOTPATH)
 BENHOLE LANE SOUTH (FOOTPATH)
 DOGGETTS (RESIDENTIAL)
 KNIGHTON FARM (RESIDENTIAL)

- BISHOPS FARM HOUSE (RESIDENTIAL)

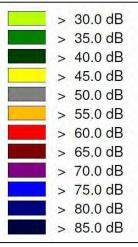$dB L_{Aeq,T}$






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HINKLEY POINT C PROJECT **ENVIRONMENTAL STATEMENT VOLUME 2 CHAPTER 11**

CONSTRUCTION NOISE CONTOURS - AT 4M ABOVE GROUND LEVEL (SCENARIO A)

FIGURE NO: FIGURE 11.3		REVISION: 01
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SCALE BAR		





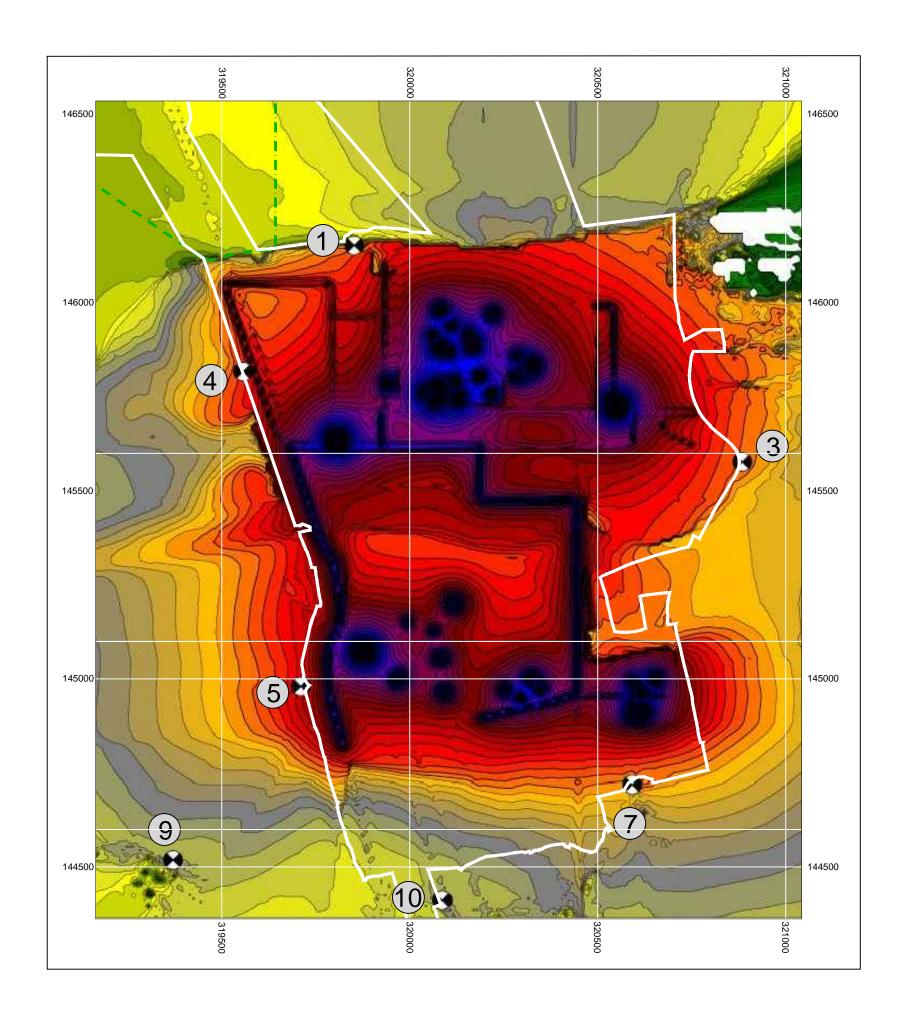

LIMITS

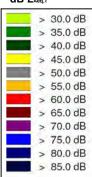
TEMPORARY JETTY SEAWARD HARBOUR

RECEPTOR LOCATIONS

- NORTHERN DEVELOPMENT SITE BOUNDARY
 (COASTAL FOOTPATH)
 PIXIES MOUND
 BENHOLE LANE NORTH (FOOTPATH)
 BENHOLE LANE SOUTH (FOOTPATH)

- DOGGETTS (RESIDENTIAL)
 KNIGHTON FARM (RESIDENTIAL)
 BISHOPS FARM HOUSE (RESIDENTIAL)

$dB L_{Aeq,T}$






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HINKLEY POINT C PROJECT **ENVIRONMENTAL STATEMENT VOLUME 2 CHAPTER 11**

CONSTRUCTION NOISE CONTOURS - AT 4M ABOVE GROUND LEVEL (SCENARIO B)

FIGURE 11.4		REVISION: 01
DATE:	DRAWN:	SCALE:
SEPT 2011	C.Y	1:10,000@A3
0 100		500m





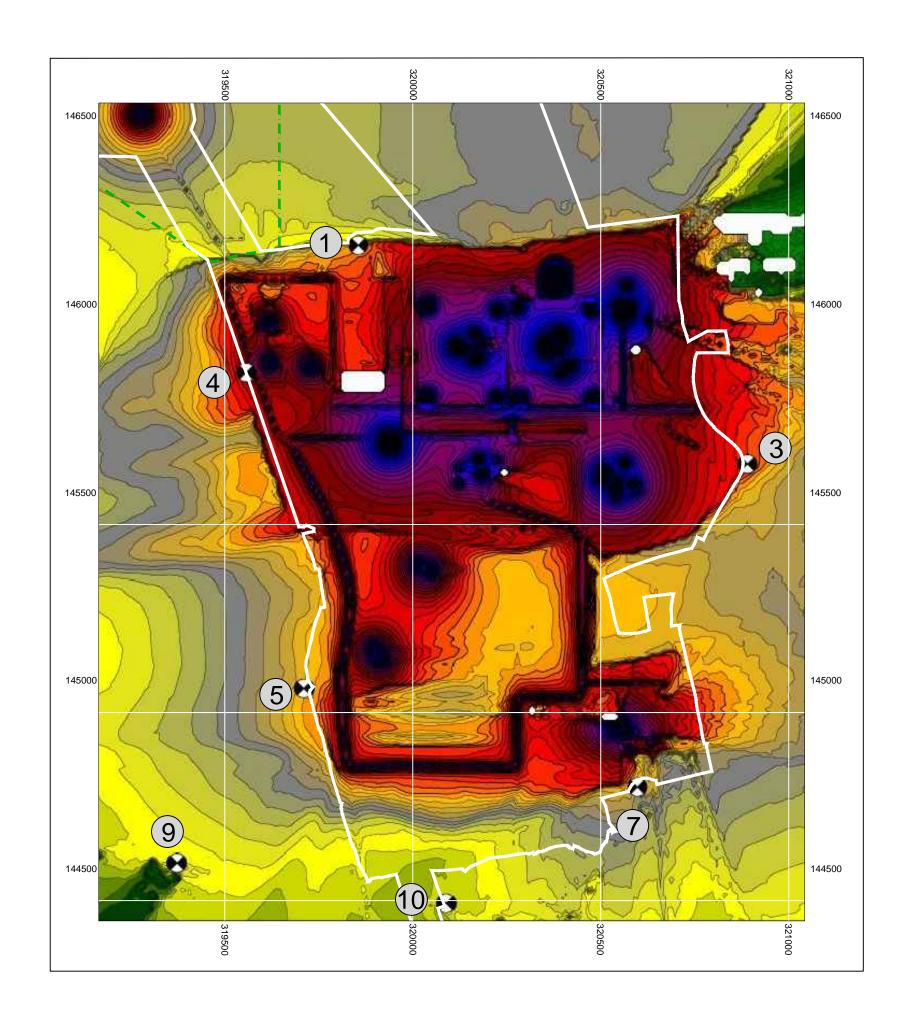



RECEPTOR LOCATIONS

- NORTHERN DEVELOPMENT SITE BOUNDARY (COASTAL FOOTPATH)
 PIXIES MOUND
- BENHOLE LANE NORTH (FOOTPATH)
 BENHOLE LANE SOUTH (FOOTPATH)
 DOGGETTS (RESIDENTIAL)
 KNIGHTON FARM (RESIDENTIAL)
 BISHOPS FARM HOUSE (RESIDENTIAL)

$\mathsf{d}\mathsf{B}\; L_{\mathsf{Aeq},\mathsf{T}}$






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HINKLEY POINT C PROJECT **ENVIRONMENTAL STATEMENT VOLUME 2 CHAPTER 11**

CONSTRUCTION NOISE CONTOURS - AT 4M ABOVE GROUND LEVEL (SCENARIO C)

FIGURE 11.5		REVISION: 01
DATE:	DRAWN:	SCALE:
SEPT 2011	C.Y	1:10.000@A3



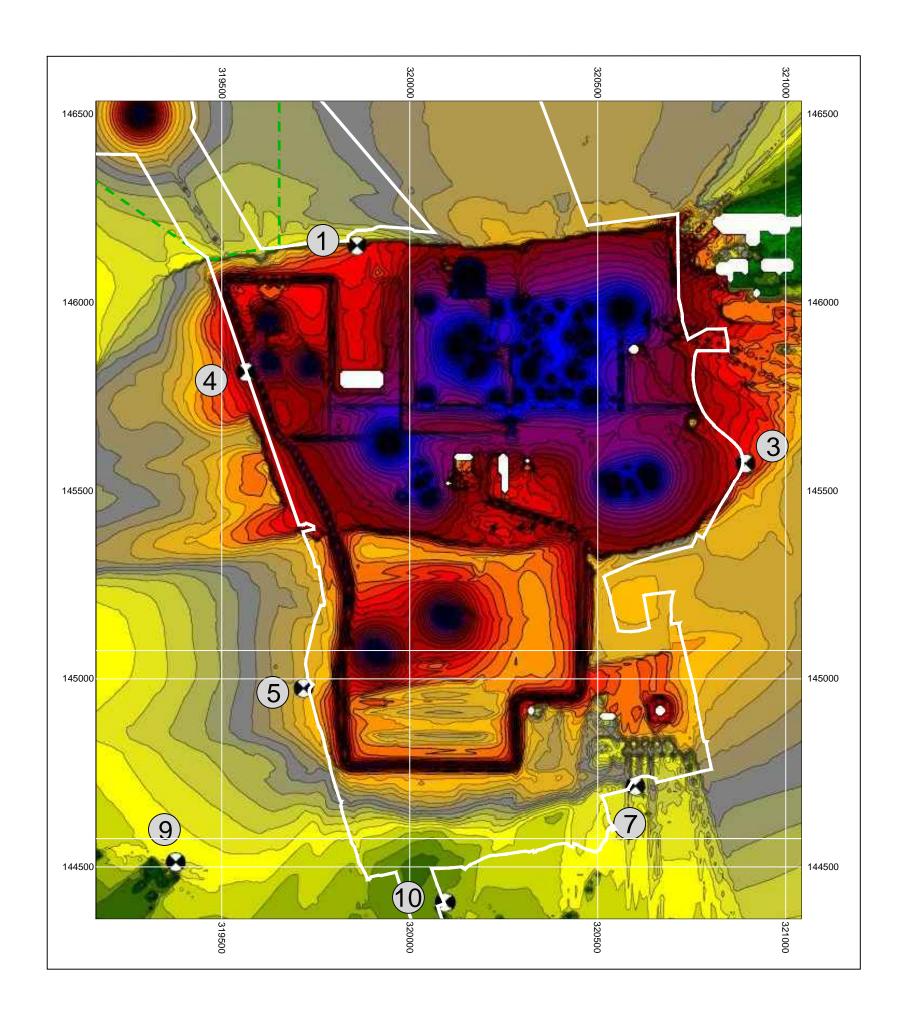HINKLEY POINT C DEVELOPMENT SITE


TEMPORARY JETTY SEAWARD HARBOUR LIMITS

RECEPTOR LOCATIONS

- NORTHERN DEVELOPMENT SITE BOUNDARY (COASTAL FOOTPATH)

- (COASTAL FOOTPATH)
 PIXIES MOUND
 BENHOLE LANE NORTH (FOOTPATH)
 BENHOLE LANE SOUTH (FOOTPATH)
 DOGGETTS (RESIDENTIAL)
 KNIGHTON FARM (RESIDENTIAL)
 BISHOPS FARM HOUSE (RESIDENTIAL)

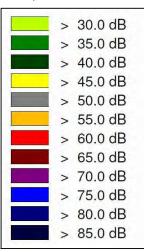$dB L_{Aeq,T}$






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HINKLEY POINT C PROJECT **ENVIRONMENTAL STATEMENT VOLUME 2 CHAPTER 11**

CONSTRUCTION NOISE CONTOURS - AT 4M ABOVE GROUND LEVEL (SCENARIO D)

FIGURE NO:	RE 11.6		REVISION: 01
DATE:		DRAWN:	SCALE:
SEPT	2011	C.Y	1:10,000@A3
SCALE BAR	100		500m



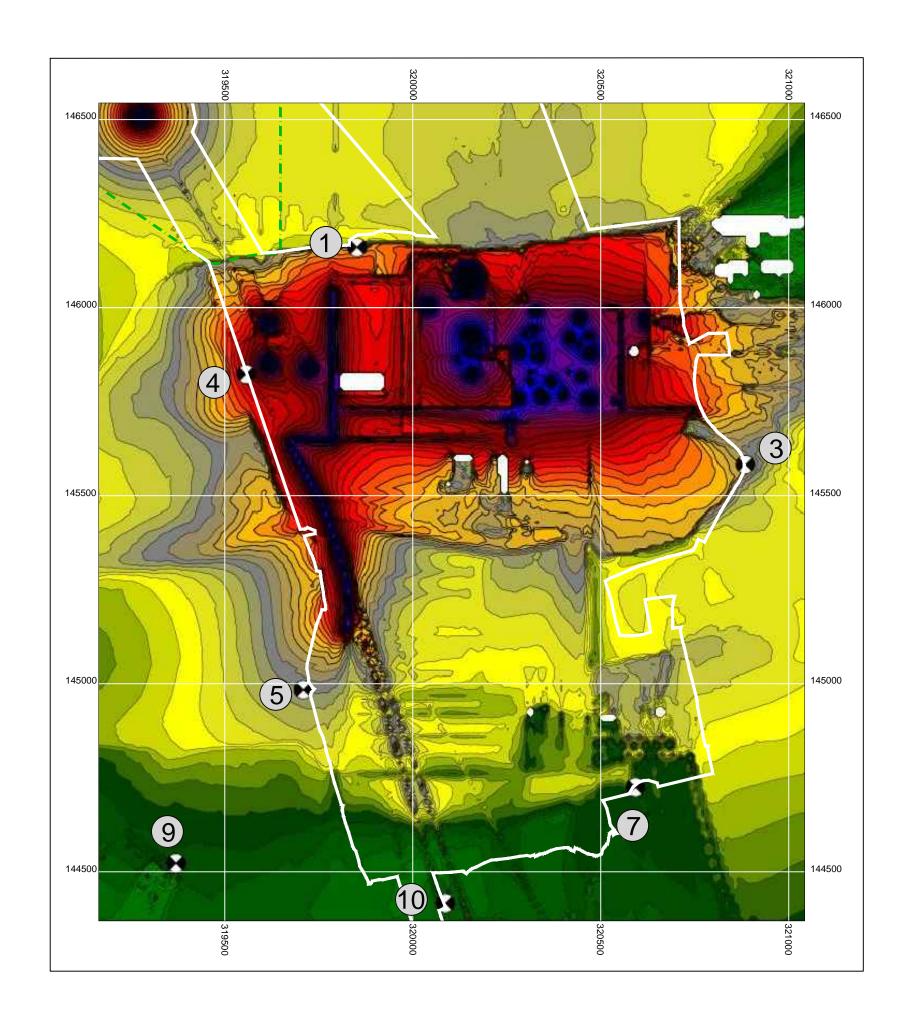


TEMPORARY JETTY SEAWARD HARBOUR

RECEPTOR LOCATIONS

- 1 NORTHERN DEVELOPMENT SITE BOUNDARY
 (COASTAL FOOTPATH)
 3 PIXIES MOUND
 4 BENHOLE LANE NORTH (FOOTPATH)
 5 BENHOLE LANE SOUTH (FOOTPATH)
 7 DOGGETTS (RESIDENTIAL)
 9 KNIGHTON FARM (RESIDENTIAL)
 10 BISHOPS FARM HOUSE (RESIDENTIAL)

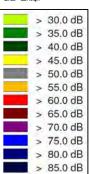$dB L_{Aeq,T}$





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HINKLEY POINT C PROJECT **ENVIRONMENTAL STATEMENT VOLUME 2 CHAPTER 11**

CONSTRUCTION NOISE CONTOURS - AT 4M ABOVE GROUND LEVEL (SCENARIO E)

FIGURE 11	.7	REVISION: 01
DATE:	DRAWN:	SCALE:
SEPT 2011	C.Y	1:10,000@A3
SCALE BAR 0 10	0 .	500m



HINKLEY POINT C DEVELOPMENT SITE BOUNDARY

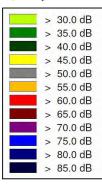


TEMPORARY JETTY SEAWARD HARBOUR LIMITS

RECEPTOR LOCATIONS

- WICK FARM (RESIDENTIAL)
- DOGGETTS (RESIDENTIAL)
 KNIGHTON FARM (RESIDENTIAL)

$\mathsf{dB}\; L_{\mathsf{Aeq},\mathsf{T}}$





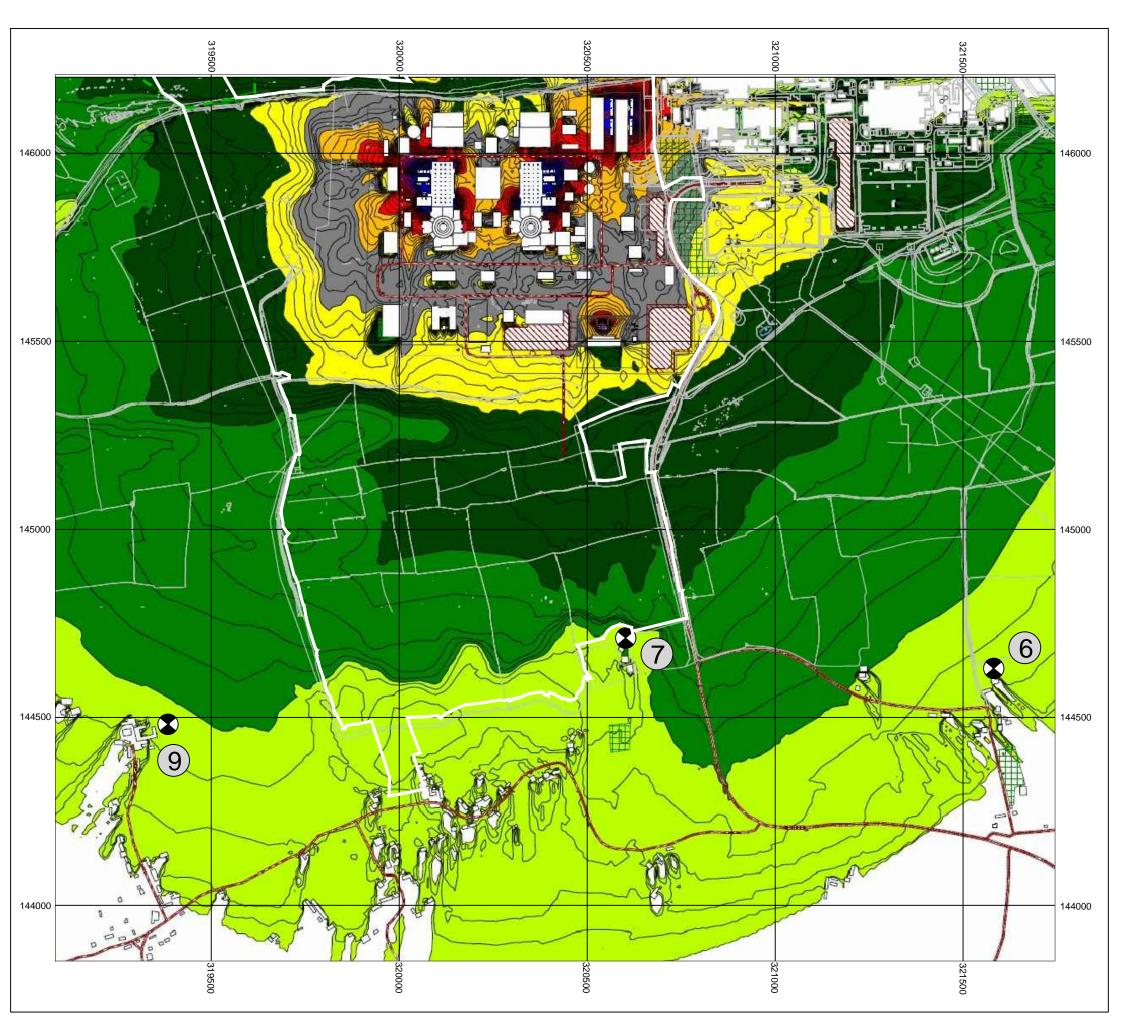
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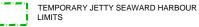
HINKLEY POINT C PROJECT **ENVIRONMENTAL STATEMENT VOLUME 2 CHAPTER 11**

NOISE CONTOURS (TWO OPERATIONAL UK EPR'S)- AT 4M ABOVE GROUND LEVEL UNDER NEUTRAL WIND CONDITIONS

FIGURE 11.8		REVISION: 01
DATE:	DRAWN:	SCALE:
SEPT 2011	C.Y	1:10.000@A3



HINKLEY POINT C DEVELOPMENT SITE



- RECEPTOR LOCATIONS
 6 WICK FARM (RESIDENTIAL)
 7 DOGGETTS (RESIDENTIAL)
 9 KNIGHTON FARM (RESIDENTIAL)

$\mathsf{dB}\; \boldsymbol{\mathit{L}}_{\mathsf{Aeq},\mathsf{T}}$






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HINKLEY POINT C PROJECT **ENVIRONMENTAL STATEMENT VOLUME 2 CHAPTER 11**

NOISE CONTOURS (TWO OPERATIONAL UK EPR'S) - AT 4M ABOVE GROUND LEVEL UNDER AVERAGE WIND CONDITIONS

FIGURE 11.9		REVISION: 01
DATE:	DRAWN:	SCALE:
SEPT 2011	C.Y	1:10,000@A3
SCALE BAR 100		500m



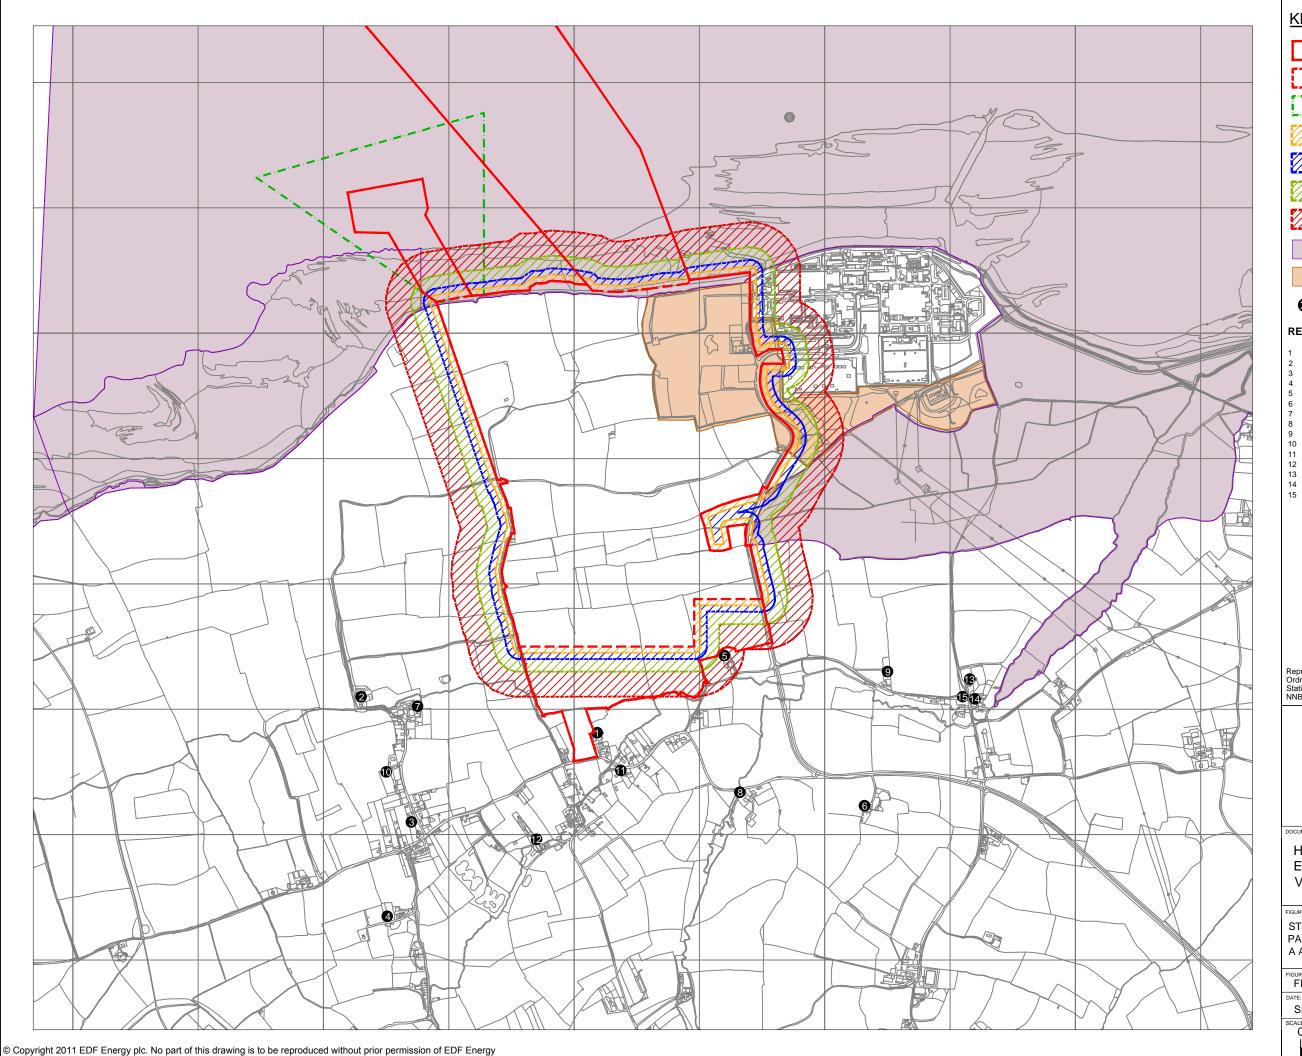HINKLEY POINT C DEVELOPMENT SITE BOUNDARY



SCENARIOS A AND C ASSESSMENT AREA BOUNDARY



TEMPORARY JETTY SEAWARD HARBOUR LIMITS



AREA WITHIN 25 METRES OF SITE BOUNDARY



AREA WITHIN 50 METRES OF SITE BOUNDARY





AREA WITHIN 100 METRES OF SITE BOUNDARY



AREA WITHIN 200 METRES OF SITE BOUNDARY



ECOLOGICAL SITES (INCLUDING SPA, RAMSAR, SSSI, SAC, NNR)



HINKLEY COUNTY WILDLIFE SITE



HUMAN RECEPTOR

RECEPTOR LOCATIONS

- BISHOPS FARM HOUSE
- BULLEN FARM BURTON VILLAGE COLE POOL DOGGETTS

- GUNTER'S GROVE
- KNIGHTON FARM NEWNHAM BRIDGE
- POINT WEST OF WICK
- POINT SOUTH OF KNIGHTON SHURTON VILLAGE WARREN'S FARM
- WICK FARM
- WICK HOUSE FARM WICK VILLAGE




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HINKLEY POINT C PROJECT **ENVIRONMENTAL STATEMENT VOLUME 2 CHAPTER 12**

STUDY AREA FOR FUGITIVE DUST AND PARTICULATES ASSESSMENT-SCENARIOS A AND C

FIGURE 12.1		REVISION: 01
DATE:	DRAWN:	SCALE:
SEPT 2011	T.S	1:15,000@A3
SCALE BAR	400	800m



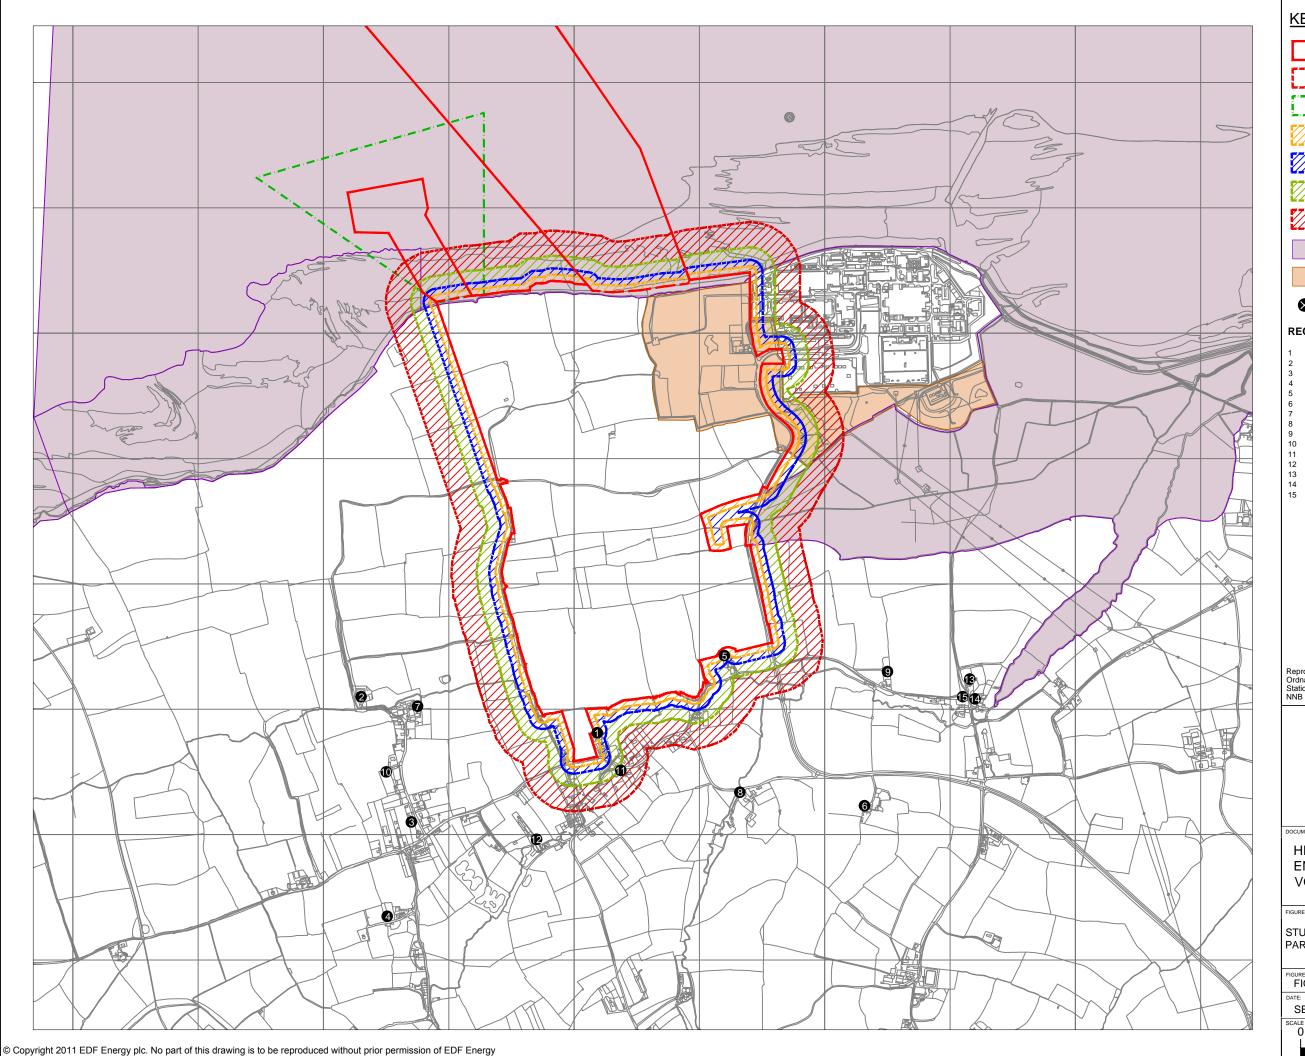HINKLEY POINT C DEVELOPMENT SITE BOUNDARY



SCENARIO B ASSESSMENT AREA BOUNDARY



TEMPORARY JETTY SEAWARD HARBOUR LIMITS



AREA WITHIN 25 METRES OF SITE BOUNDARY



AREA WITHIN 50 METRES OF SITE BOUNDARY





AREA WITHIN 100 METRES OF SITE BOUNDARY



AREA WITHIN 200 METRES OF SITE BOUNDARY



ECOLOGICAL SITES (INCLUDING SPA, RAMSAR, SSSI, SAC, NNR)



HINKLEY COUNTY WILDLIFE SITE



HUMAN RECEPTOR

RECEPTOR LOCATIONS

BISHOPS FARM HOUSE BULLEN FARM

- BURTON VILLAGE COLE POOL DOGGETTS

- GUNTER'S GROVE
- KNIGHTON FARM NEWNHAM BRIDGE
- POINT WEST OF WICK
- POINT SOUTH OF KNIGHTON
- SHURTON VILLAGE WARREN'S FARM
- WICK FARM
- WICK HOUSE FARM WICK VILLAGE




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HINKLEY POINT C PROJECT **ENVIRONMENTAL STATEMENT VOLUME 2 CHAPTER 12**

STUDY AREA FOR FUGITIVE DUST AND PARTICULATES ASSESSMENT - SCENARIO B

FIGURE 12.2		REVISION: 01
DATE:	DRAWN:	SCALE:
SEPT 2011	T.S	1:15,000@A3
SCALE BAR	400	800m



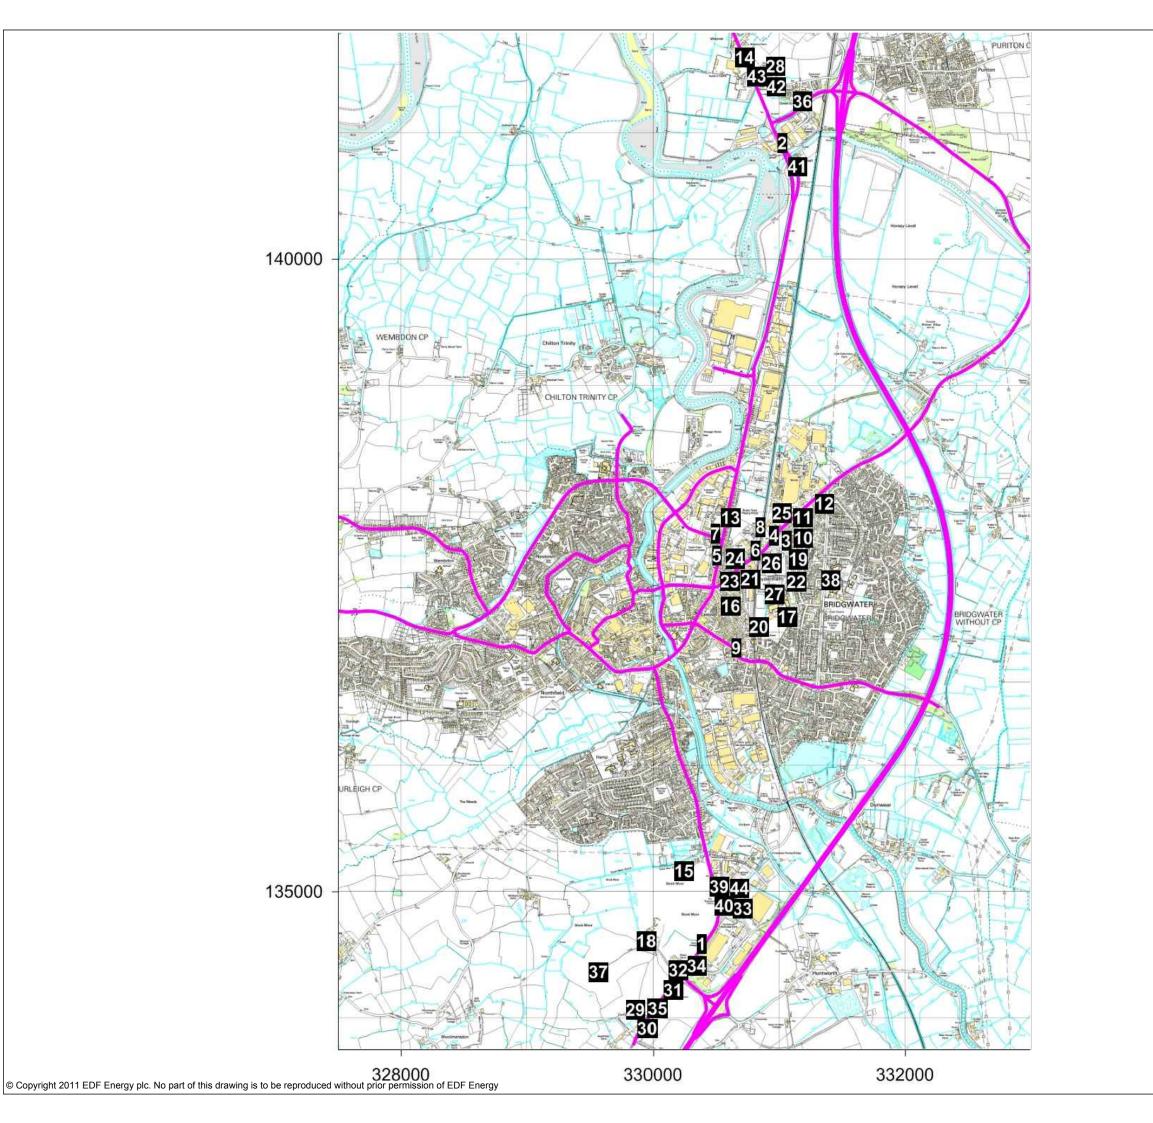

ROAD SOURCES



HUMAN RECEPTOR

RECEPTOR LOCATIONS

- 1 DAWS FARM COTTAGES
- 10 BRISTOL ROAD 100C BATH ROAD
- 104 BATH ROAD
- 128 UNION STREET 131 LOWER BATH ROAD
- 131 THE DROVE 135 BATH ROAD
- 141 ST. JOHN STREET 144 BATH ROAD
- 150 FREDERICK ROAD
- 170 BATH ROAD 196 BRISTOL ROAD 2 WALPOLE COTTAGE BRISTOL ROAD 28 LIMOUSIN WAY 3 CORNBOROUGH PLACE 4 ELIZABETH WAY

- 46 SANDALWOOD RIDE 62A FAIRFAX ROAD
- 64 CLARKS ROAD
- 69 BATH ROAD 74 FAIRFAX ROAD

- 74 FAIRFAX ROAD
 78 BATH ROAD
 86 BATH ROAD
 BATH ROAD NEWS 167 BATH ROAD
 BRIDGWATER & ALBION RUGBY FOOTBALL CLUB
 BRIDGWATER COLLEGE

- BRIDGWATER COLLEGE
 CHESTNUT HOUSE, DOWNEND ROAD
 COMPASS HOUSE, TAUNTON ROAD (BACK)
 COMPASS HOUSE, TAUNTON ROAD
 COMPASS INN, TAUNTON ROAD

- DAWS FARM, TAUNTON ROAD
 DWELLING AT CORNER OF MARSH LANE
 MOTO HOSPITALITY SERVICES
- QUANTOCK VIEW HOUSE, TAUNTON ROAD RIVERVIEW, DOWNEND CRESCENT
- SITE OF FUTURE HOUSING DEVELOPMENT SOMERSET SKILLS & LEARNING PARKWAY
- THE BRAINWAVE CENTRE
 THE BRAINWAVE CENTRE (ACCOMMODATION
- THE OLD POST HOUSE, BRISTOL ROAD
 THE WOODLANDS, DOWNEND ROAD

- TREE TOPS, BRISTOL ROAD UNIQUE HEALTH AND FITNESS



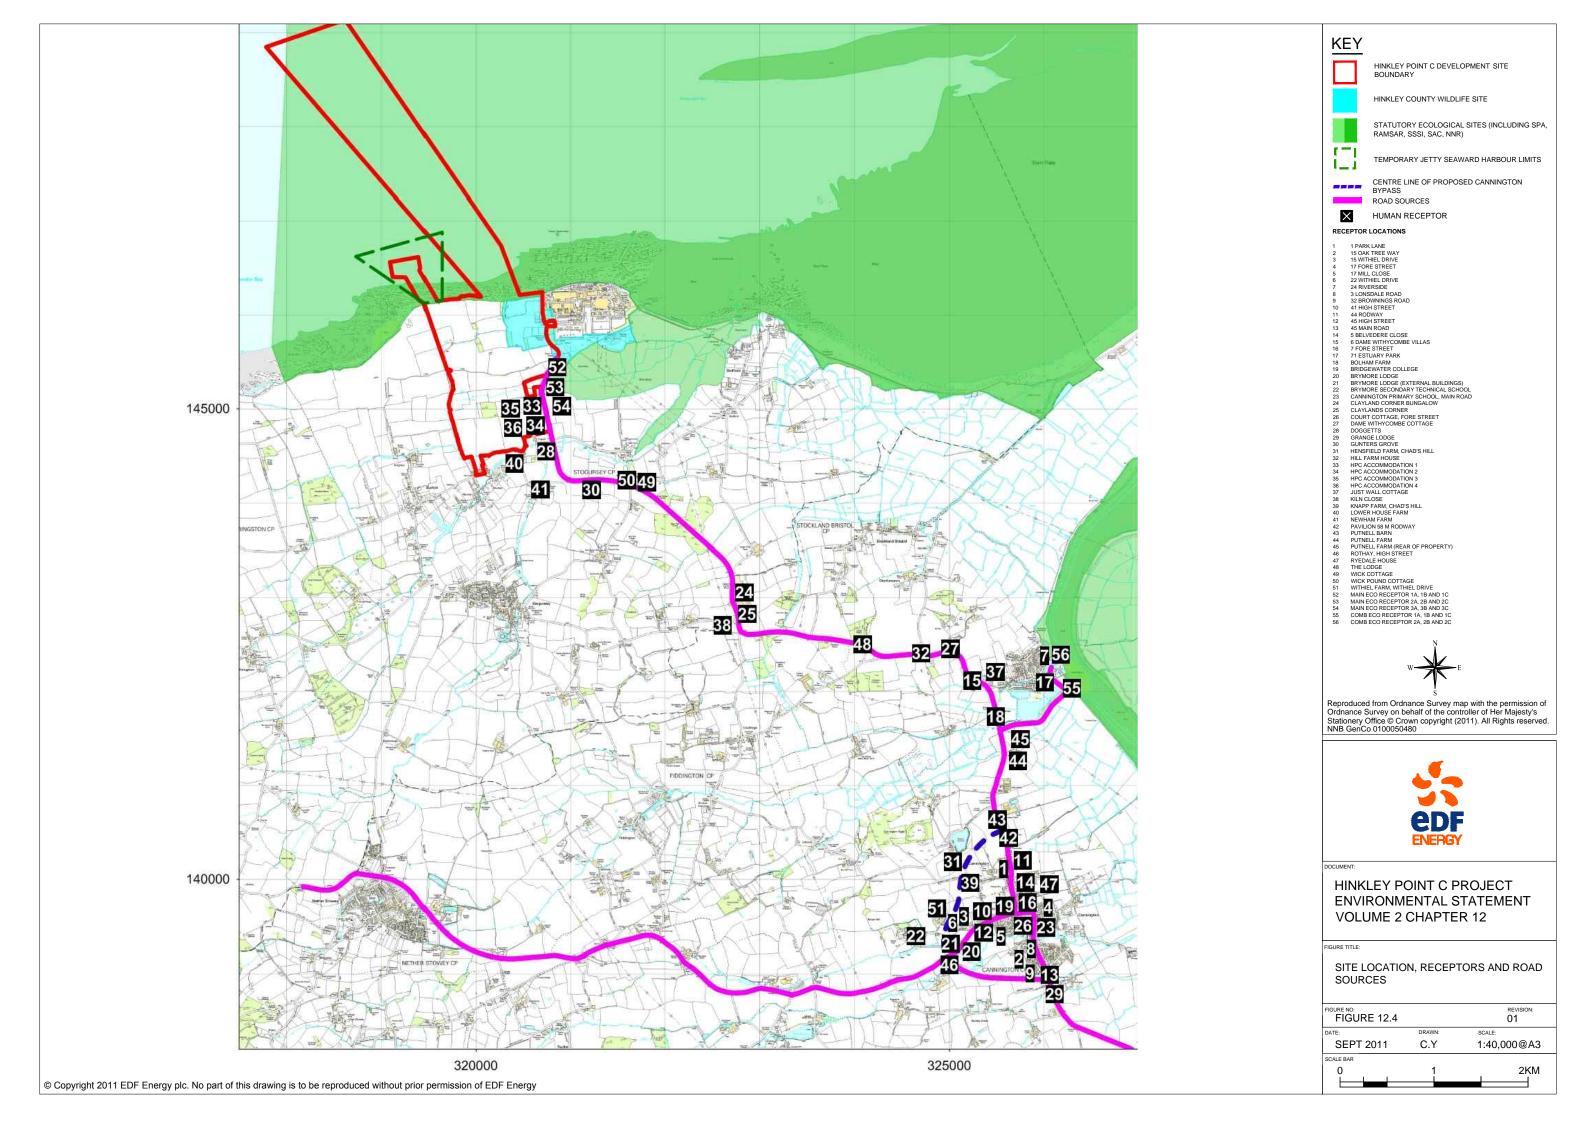
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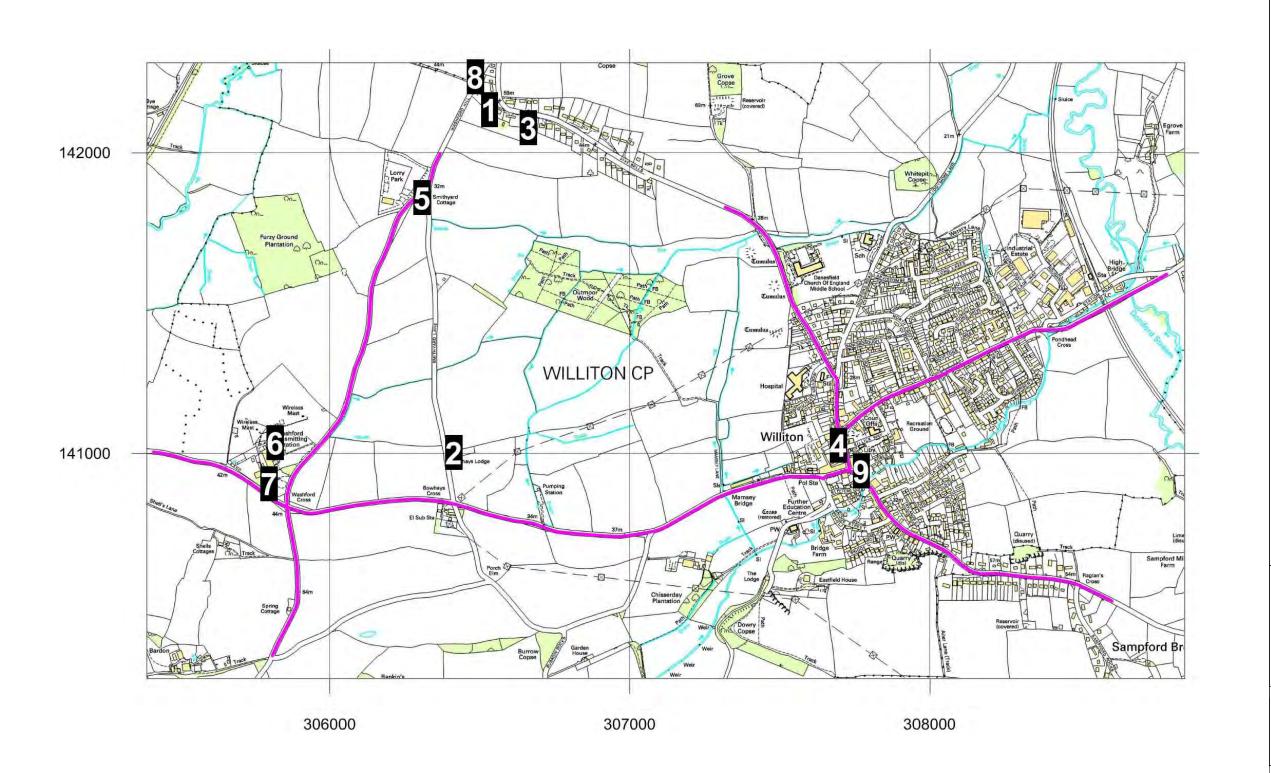


HINKLEY POINT C PROJECT **ENVIRONMENTAL STATEMENT VOLUME 2 CHAPTER 12**

STUDY AREA FOR VEHICULAR EXHAUST EMISSIONS ASSESSMENT - BRIDGWATER ADMS ROADS MODEL

FIGURE 12.3		REVISION: 01
DATE:	DRAWN:	SCALE:
SEPT 2011	T.S	1:30,000@A3
SCALE BAR		
0	0.5	1KM







ROAD SOURCES



HUMAN RECEPTOR

RECEPTOR LOCATIONS

- 39 FIVE BELLS BOHAYS LODGE, SMITHYARD LANE KAFUE, 33 FIVE BELLS
- POST OFFICE
- SMITHYARD COTTAGE
- TROPIQUARIA ZOO (BACK)
- TROPIQUARIA ZOO (FRONT)
- WASHFORD HILL
- WILLITON COUNTY STORES



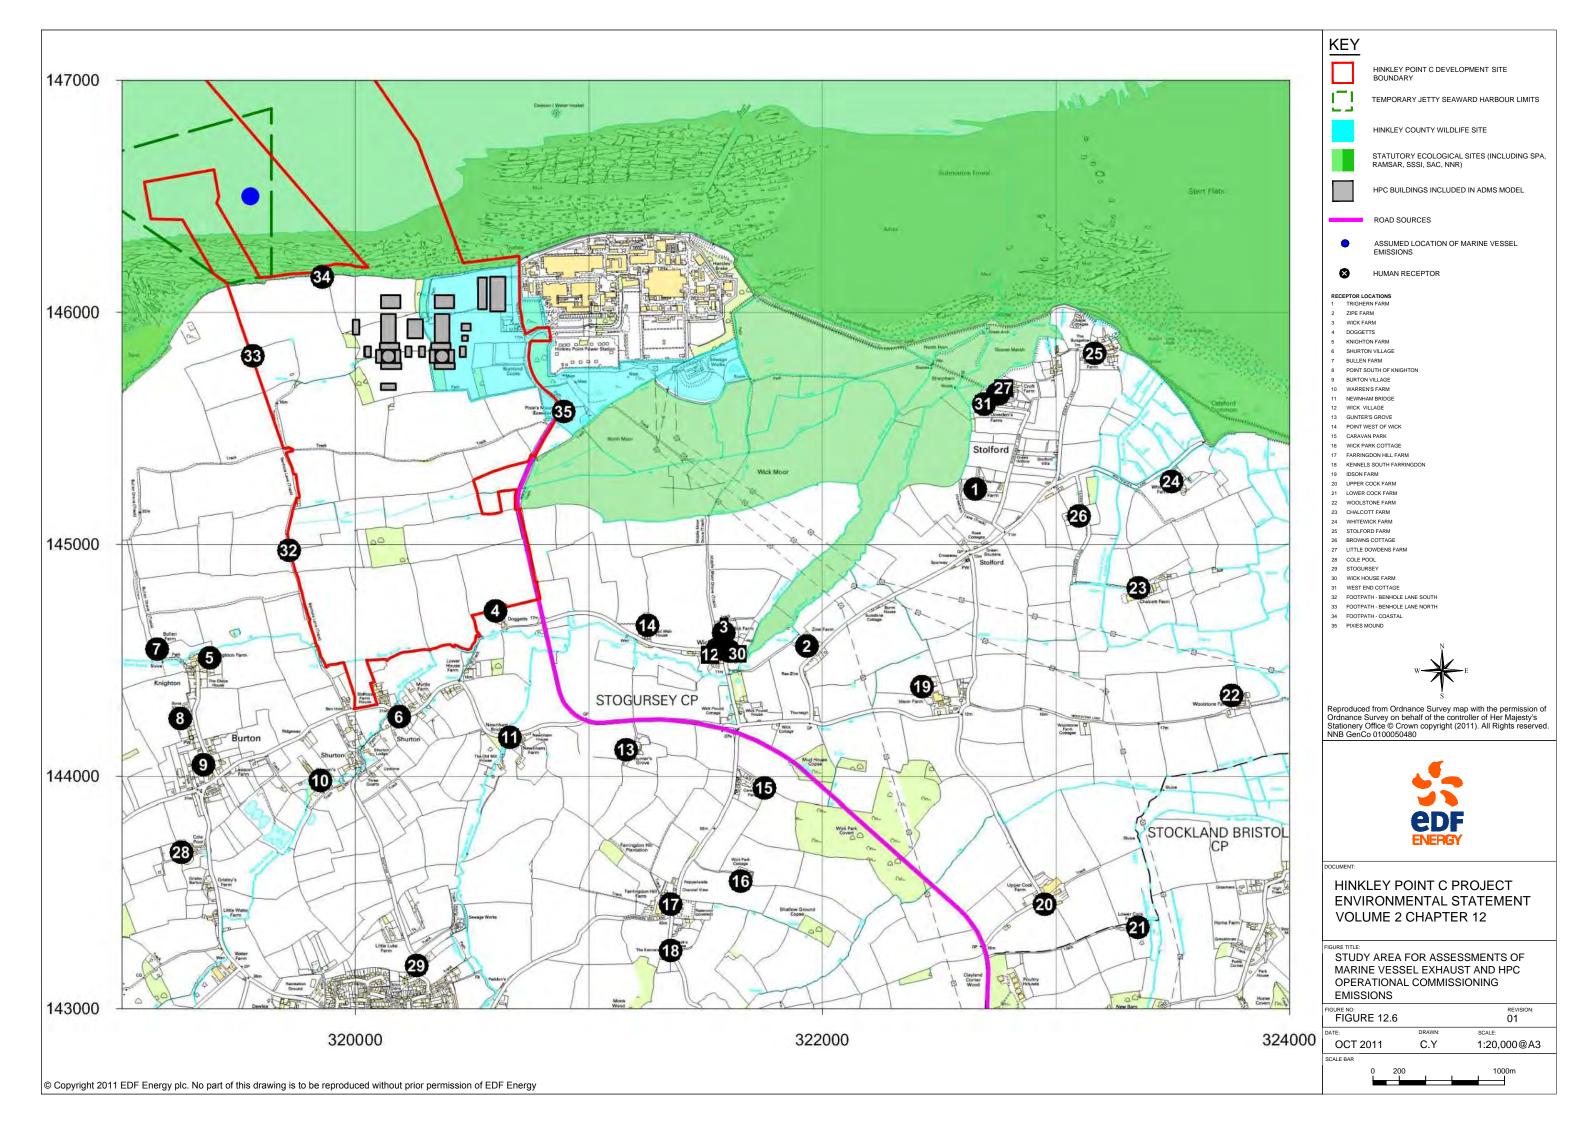
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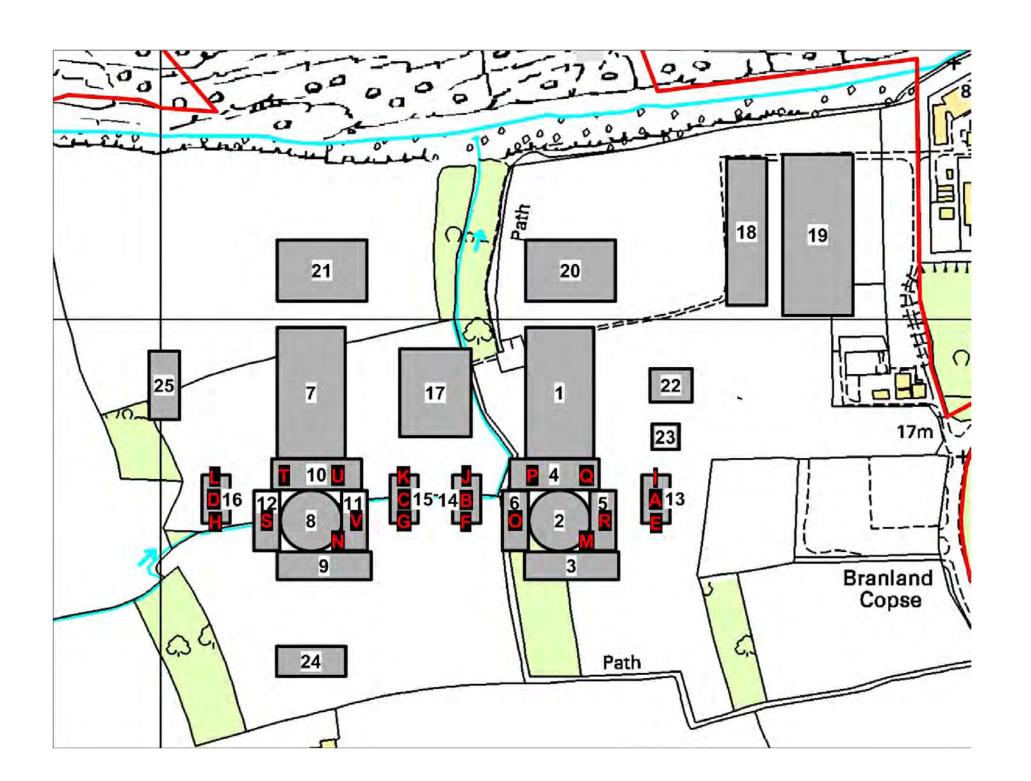


HINKLEY POINT C PROJECT **ENVIRONMENTAL STATEMENT VOLUME 2 CHAPTER 12**

STUDY AREA FOR VEHICULAR EXHAUST **EMISSIONS ASSESSMENT - WILLITON ADMS** ROADS MODEL

FIGURE 12.5			REVISION: 01	
DATE:		DRAWN:	SCALE:	
SEPT 2011		T.S	1:12,500@A3	
SCALE BAR				
O O	150	300	600m	









HINKLEY POINT C DEVELOPMENT SITE



HPC BUILDINGS INCLUDED IN ADMS MODEL



BUILDINGS



STACKS

- 1 C1 TURBINE HALL
 2 C1 REACTOR BUILDING
 3 C1 FUEL BUILDING/NUCLEAR AUX BUILDING 4 C1 SAFEGUARD ELECTRICITY BUILDINGS 2-3/ACCESS BUILDING
- 5 C1 SAFEGUARD ELECTRICITY BUILDING 4
- 6 C1 SAFEGUARD ELECTRICITY BUILDING 1 7 C2 TURBINE HALL

- 8 C2 REACTOR BUILDING
- C2 FUEL BUILDING/MICLEAR AUX BUILDING
 C2 SAFEGUARD ELECTRICITY BUILDINGS 2-3/ACCESS BUILDING
 C2 SAFEGUARD ELECTRICITY BUILDING 4
- 12 C2 SAFEGUARD ELECTRICITY BUILDING 1
- 13 EMERGENCY DIESEL BUILDING C1B 14 EMERGENCY DIESEL BUILDING C2A
- 15 EMERGENCY DIESEL BUILDING C1A
- 16 EMERGENCY DIESEL BUILDING C2B
 17 OPERATIONAL SERVICE CENTRE
 18 INTERMEDIATE LEVEL WASTE INTERIM STORAGE FACILITY (ILWISF)
- 19 INTERIM SPENT FUEL STORE (ISFS)
- 20 C1 COOLING WATER PUMPHOUSE 21 C2 COOLING WATER PUMPHOUSE
- 22 DEMINERALISATION/DESALINATION STATION 23 AUXILIARY BOILERS
- 24 CONTAMINATED TOOLS STORE 1 25 CONTAMINATED TOOLS STORE 2

STACKS

- A EDG_2_C1B B EDG_2_C2A
- C EDG_2_C1A
 D EDG_2_C2B
 E EDG_1_C1B
- F EDG_1_C2A
- G EDG_1_C1A H EDG_1_C2B
- SBO_C1B

 J SBO_C2A

 K SBO_C1A

 L SBO_C2B
- M C1 MAIN
- N C2 MAIN
 O NH3_C1A
 P NH3_C1B

- Q NH3_C1C
 R NH3_C1D
 S NH3_C2A
 T NH3_C2B
 U NH3_C2C
 V NH3_C2D




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HINKLEY POINT C PROJECT **ENVIRONMENTAL STATEMENT VOLUME 2 CHAPTER 12**

BUILDING CONFIGURATION AND EMISSIONS SOURCES INCLUDED WITHIN HPC OPERATIONAL/COMMISSIONING ADMS MODELLING

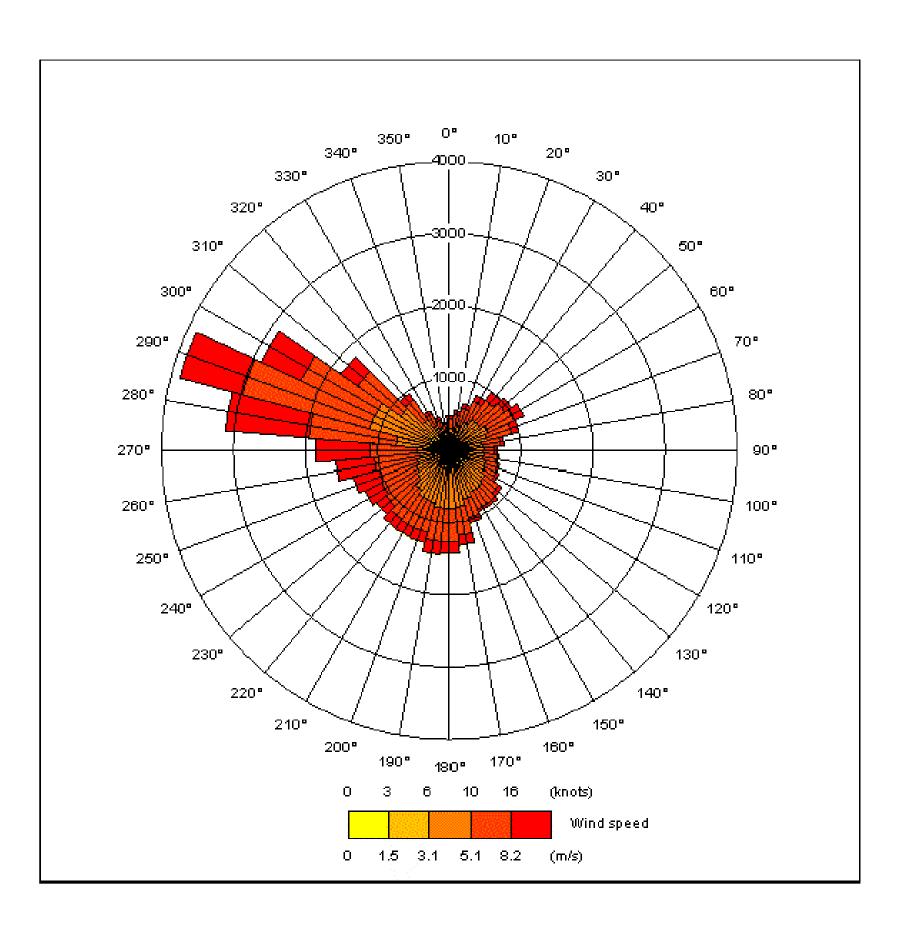GURE NO: FIGURE 12.7 OCT 2011 1:1,700@A3





SEE KEY WITHIN FIGURE




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HINKLEY POINT C PROJECT ENVIRONMENTAL STATEMENT VOLUME 2 CHAPTER 12

FIGURE TITLE

WIND ROSE FOR HINKLEY POINT (2005-2009)

FIGURE 12.8		REVISION:
DATE:	DRAWN:	SCALE:
SEPT 2011	C.Y	N/A
SCALE BAR		



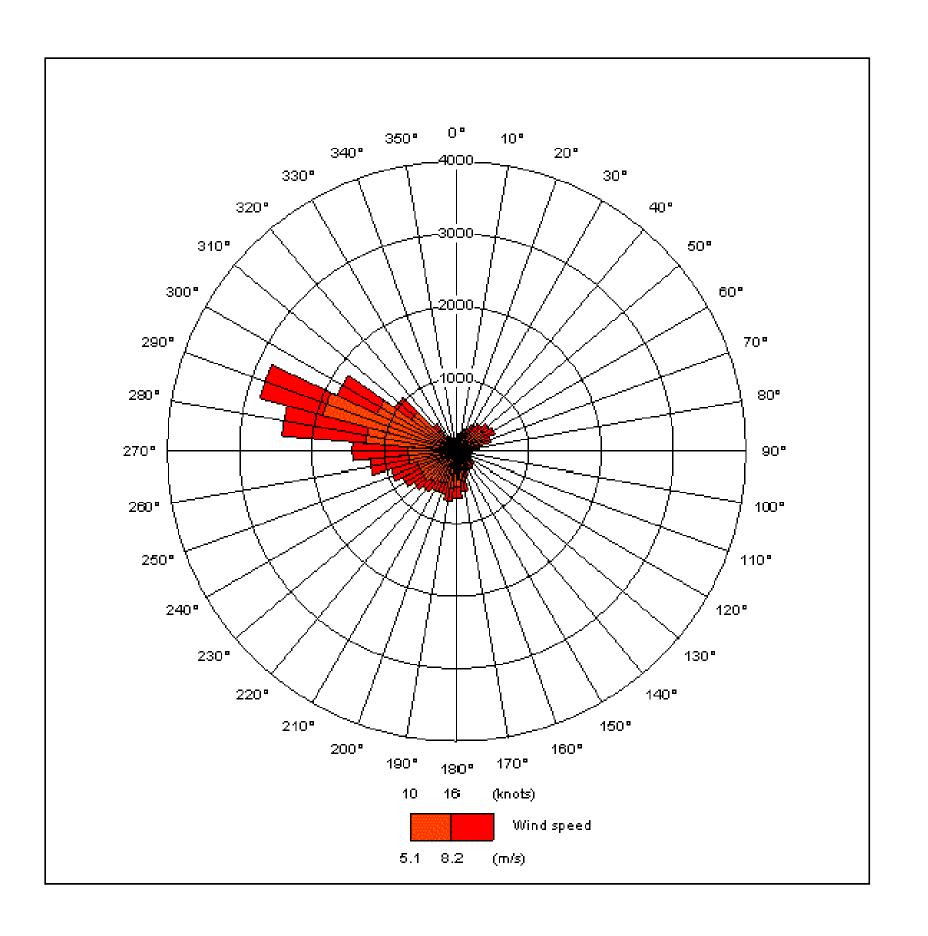

SEE KEY WITHIN FIGURE



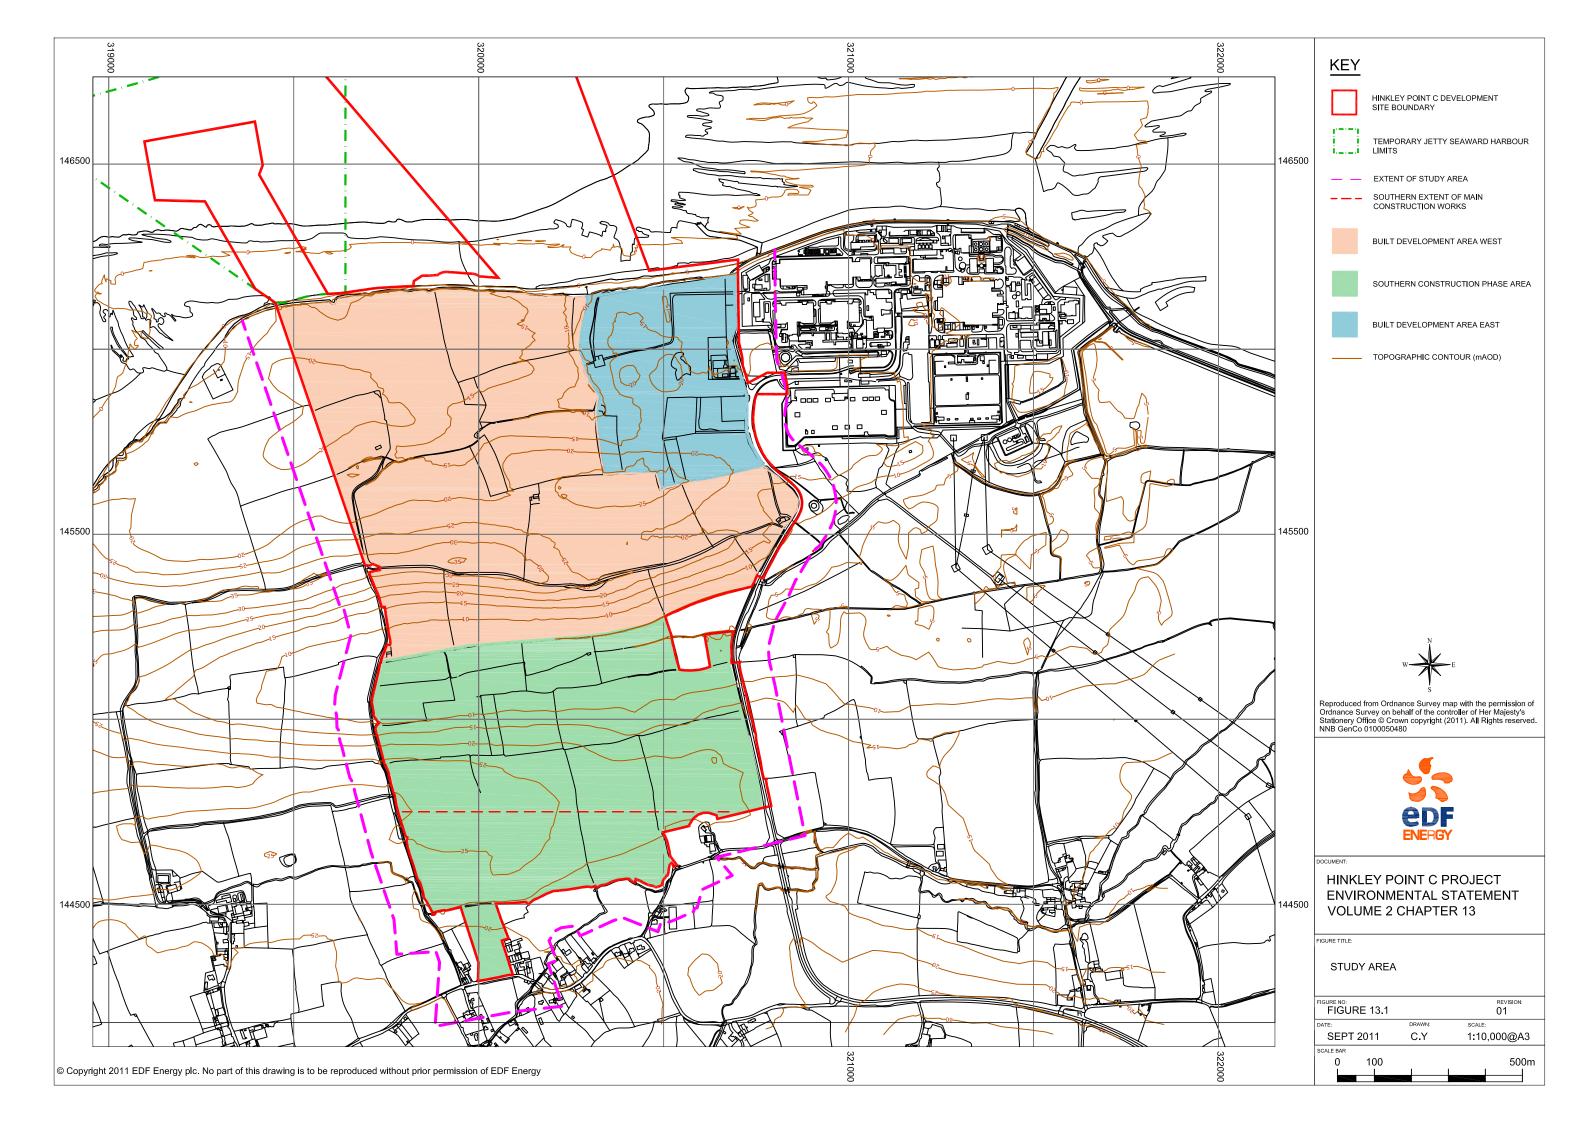
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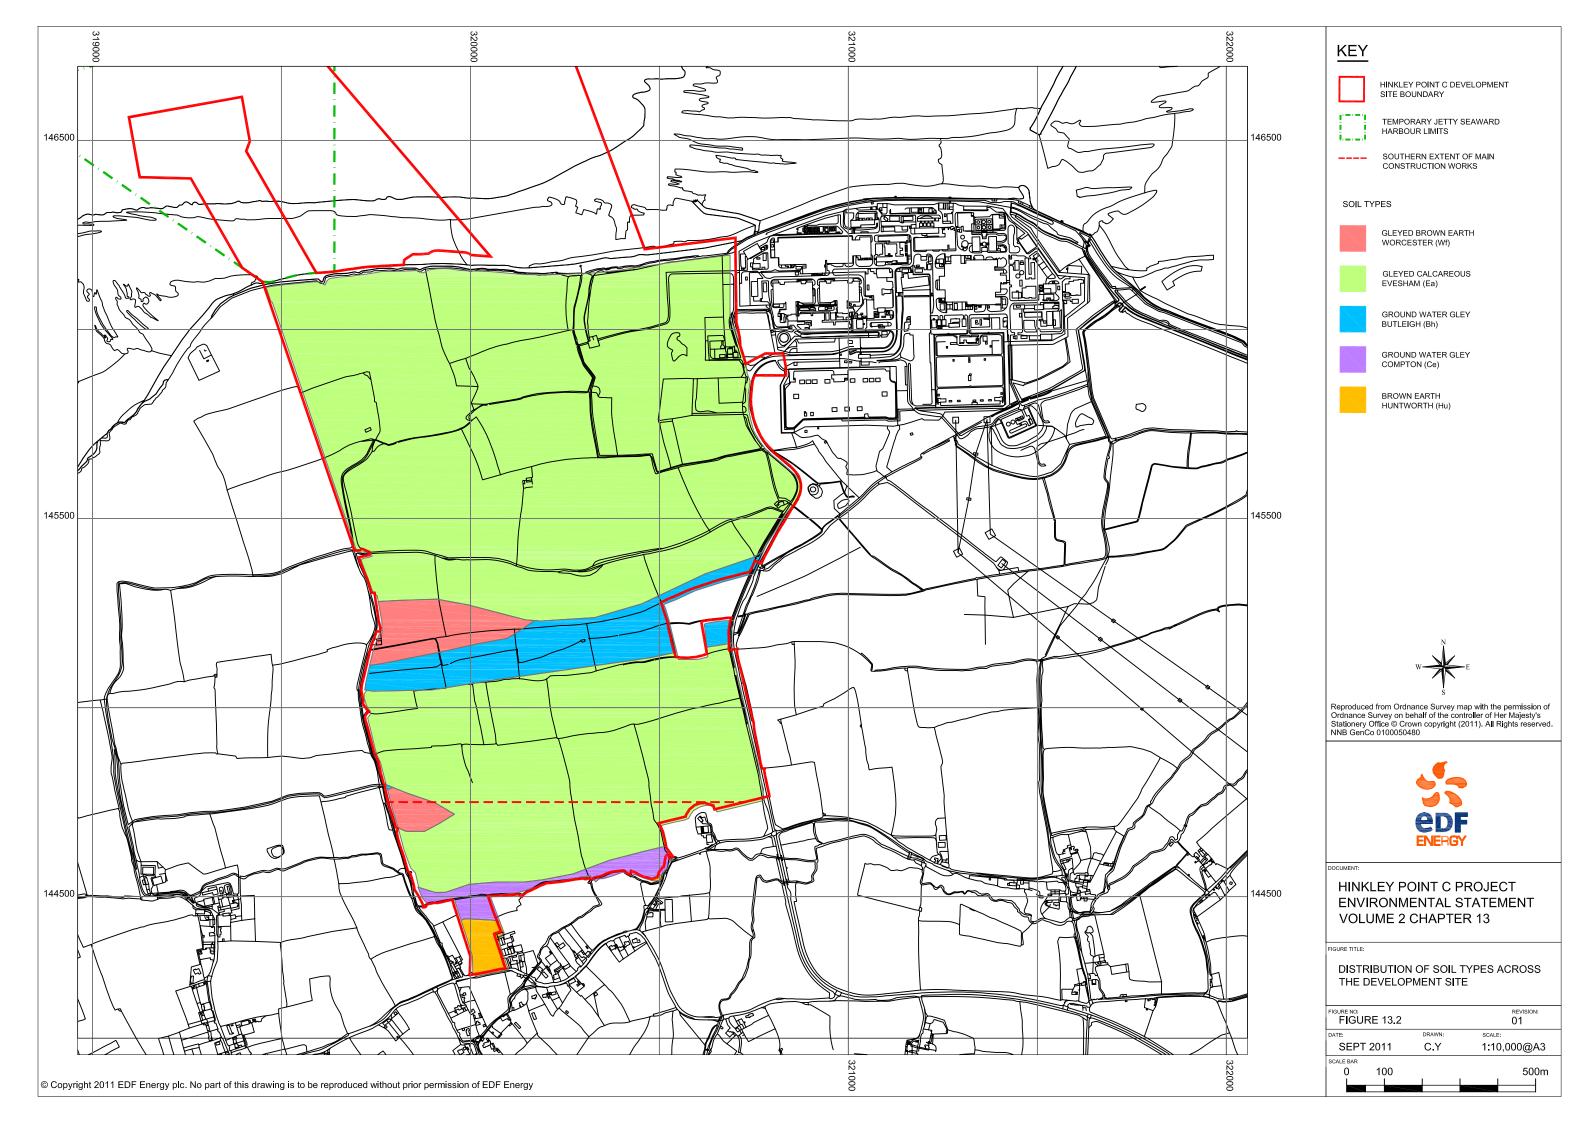
HINKLEY POINT C PROJECT ENVIRONMENTAL STATEMENT VOLUME 2 CHAPTER 12


FIGURE TIT


WIND ROSE OF MODERATE TO STRONG WINDS (>5m/s) AT HINKLEY POINT (2005-2009)


FIGURE 12.9		REVISION: 01		
DATE:	DRAWN:	SCALE:		
SEPT 2011	C.Y	N/A		
SCALE BAR				






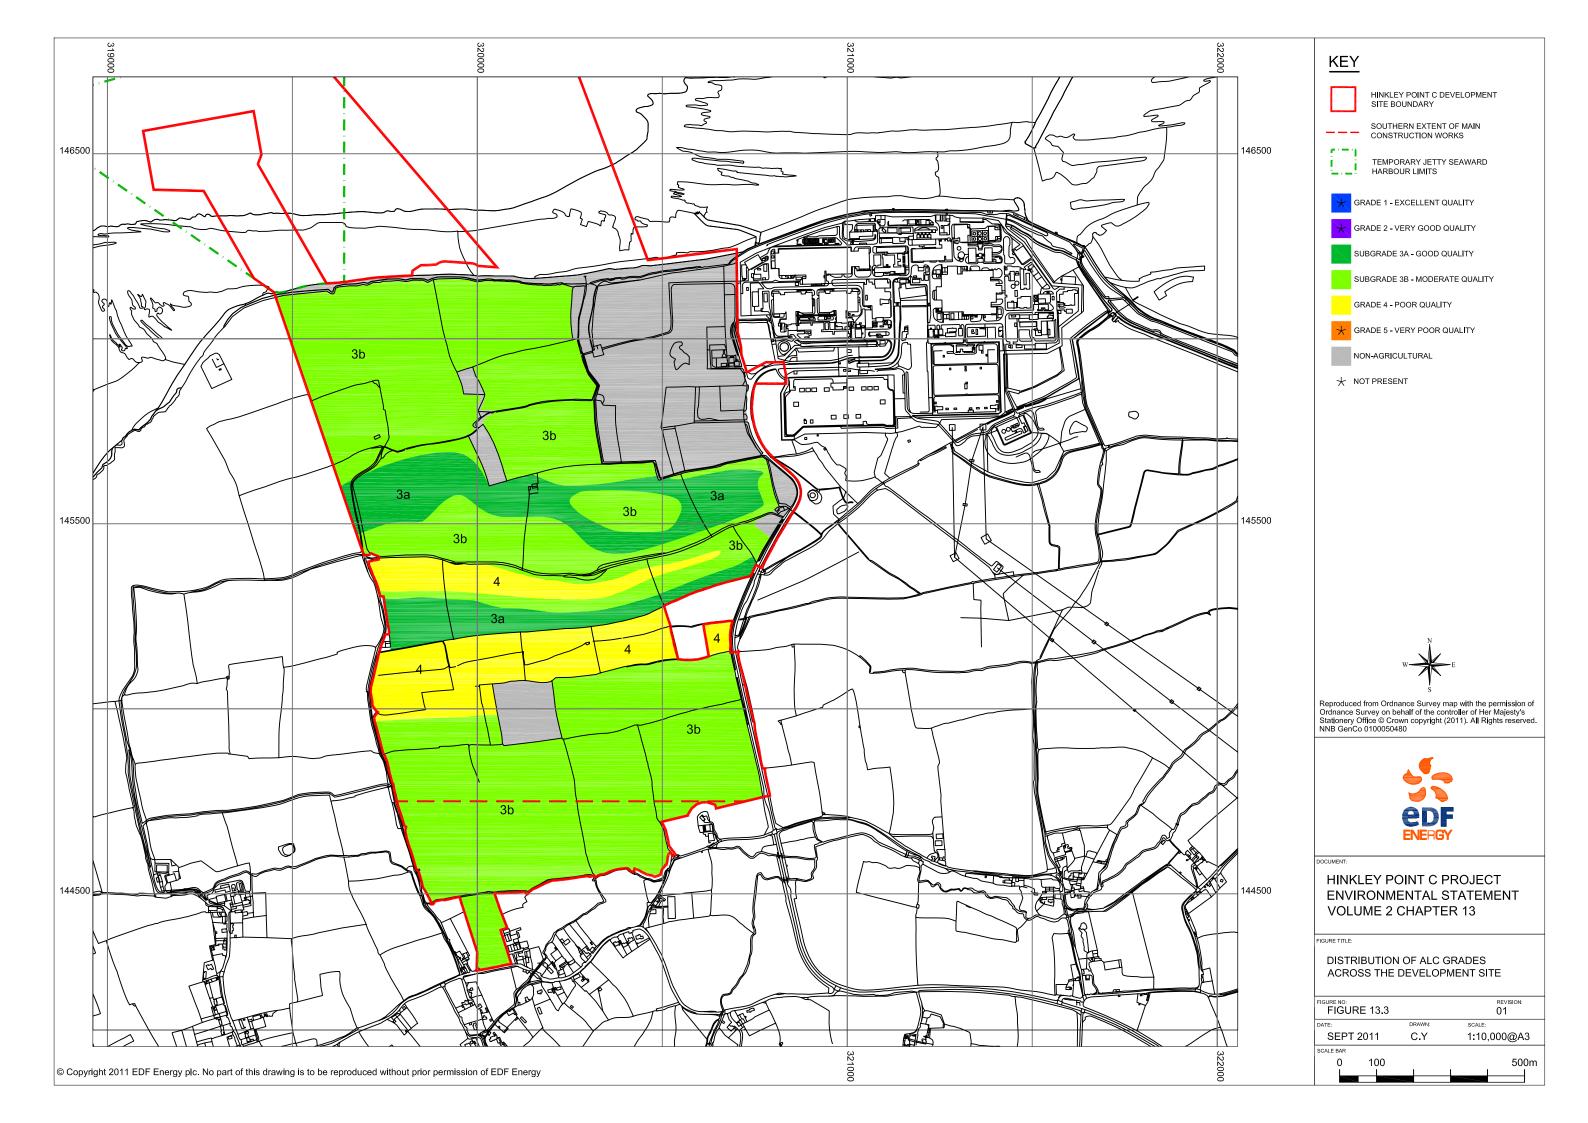


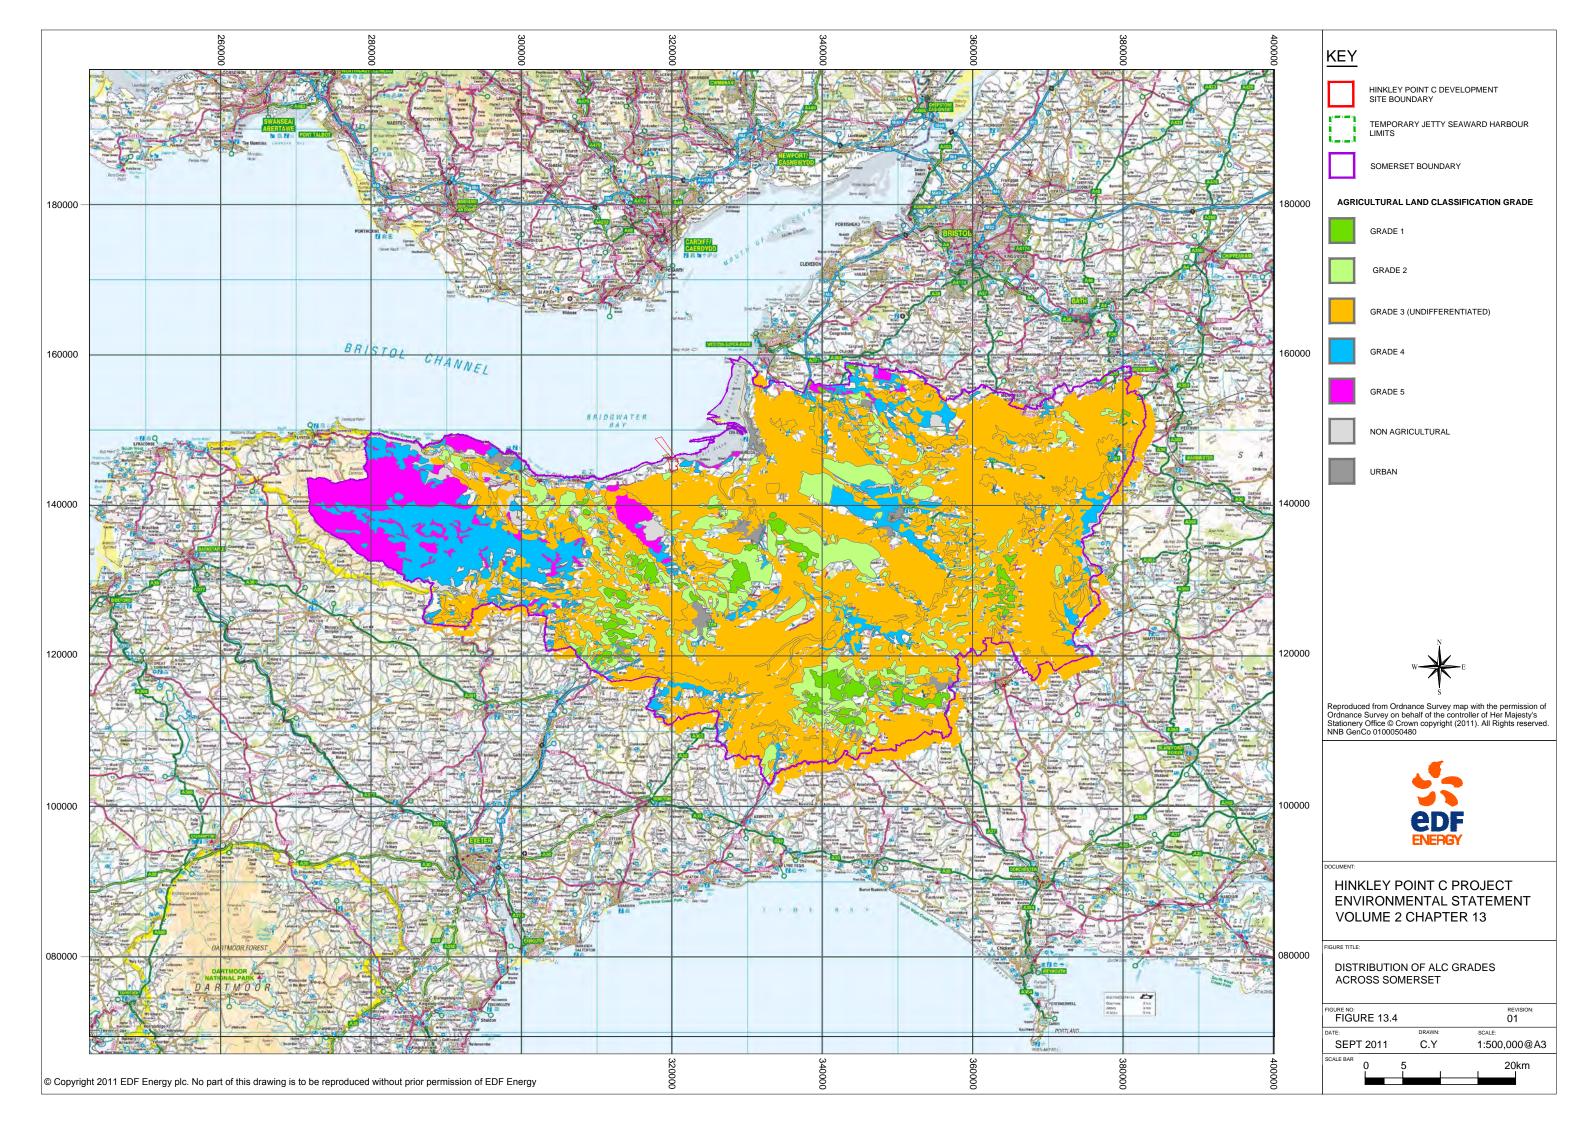


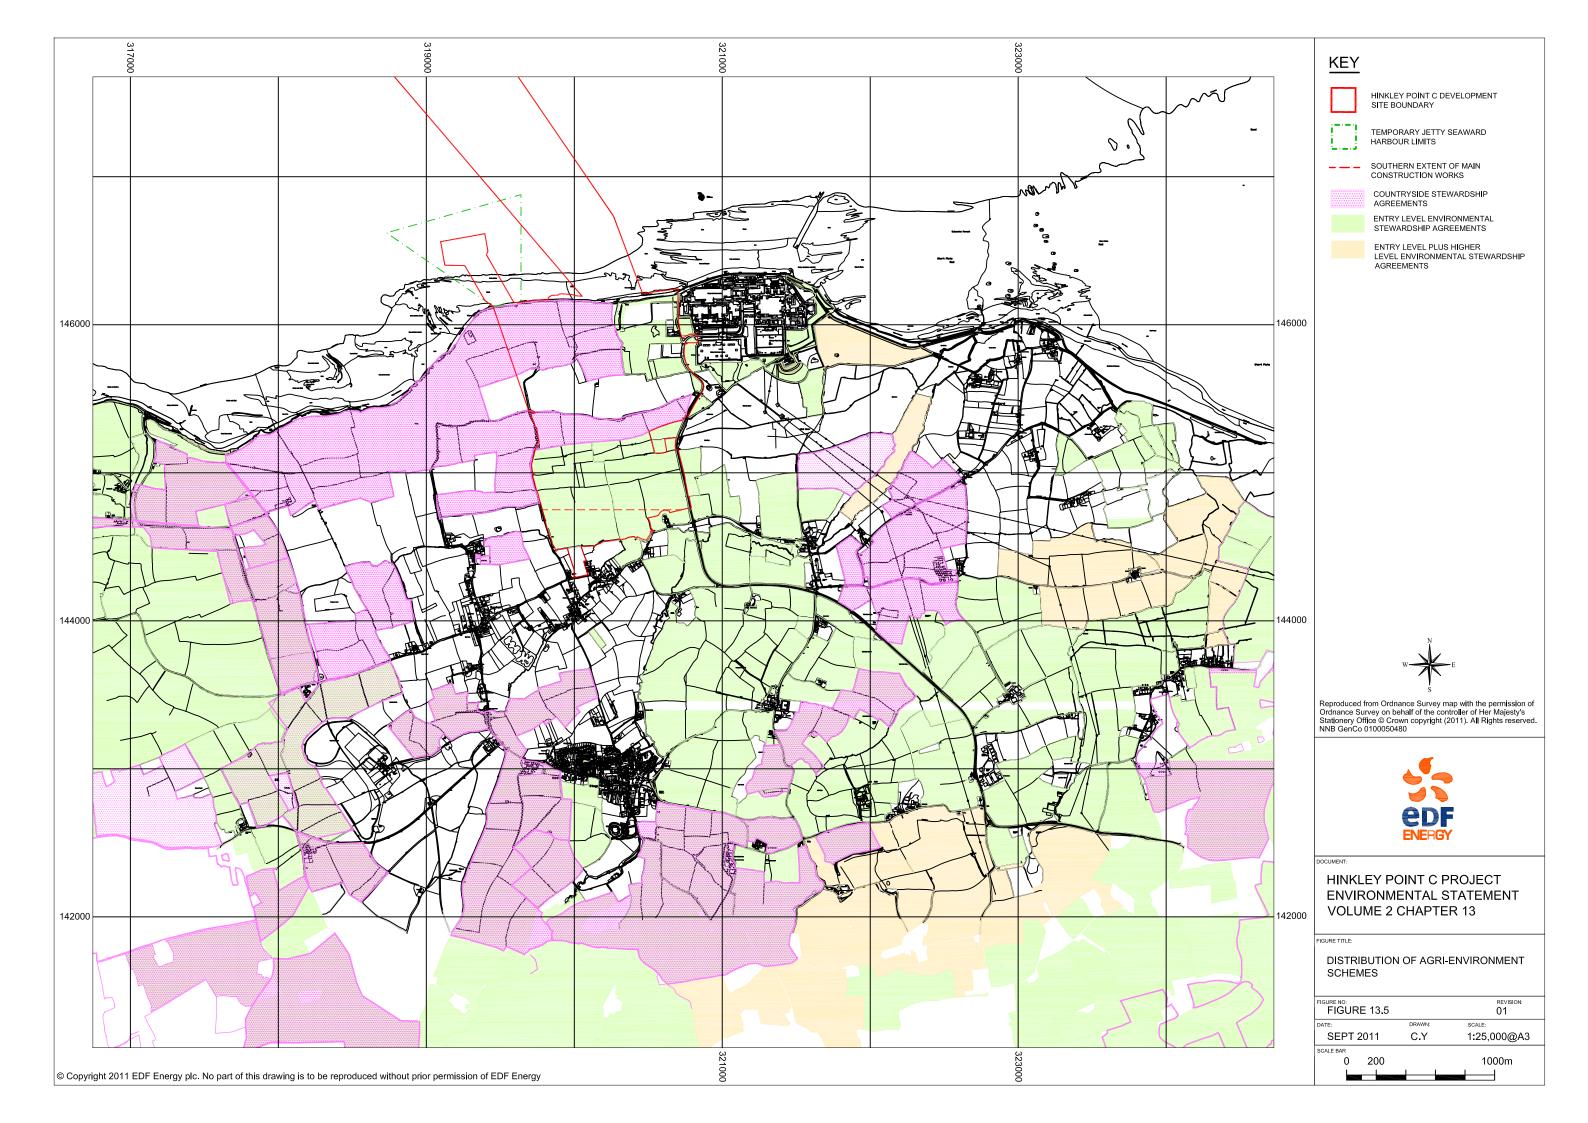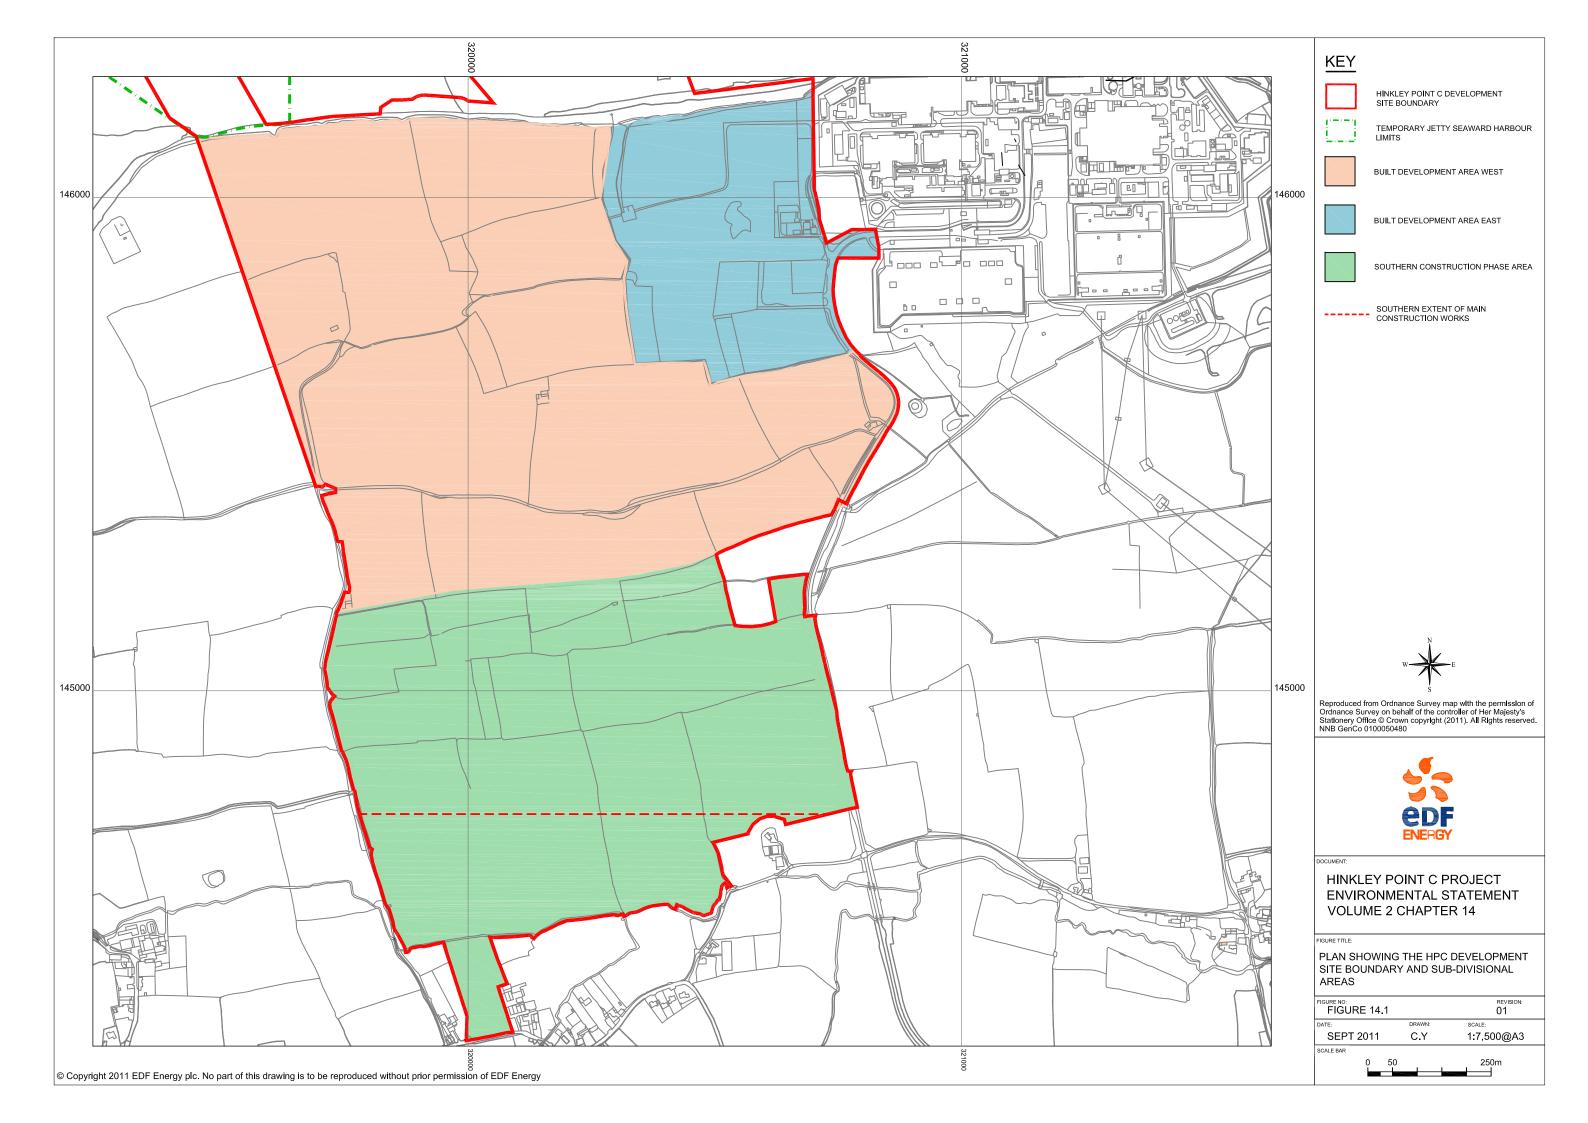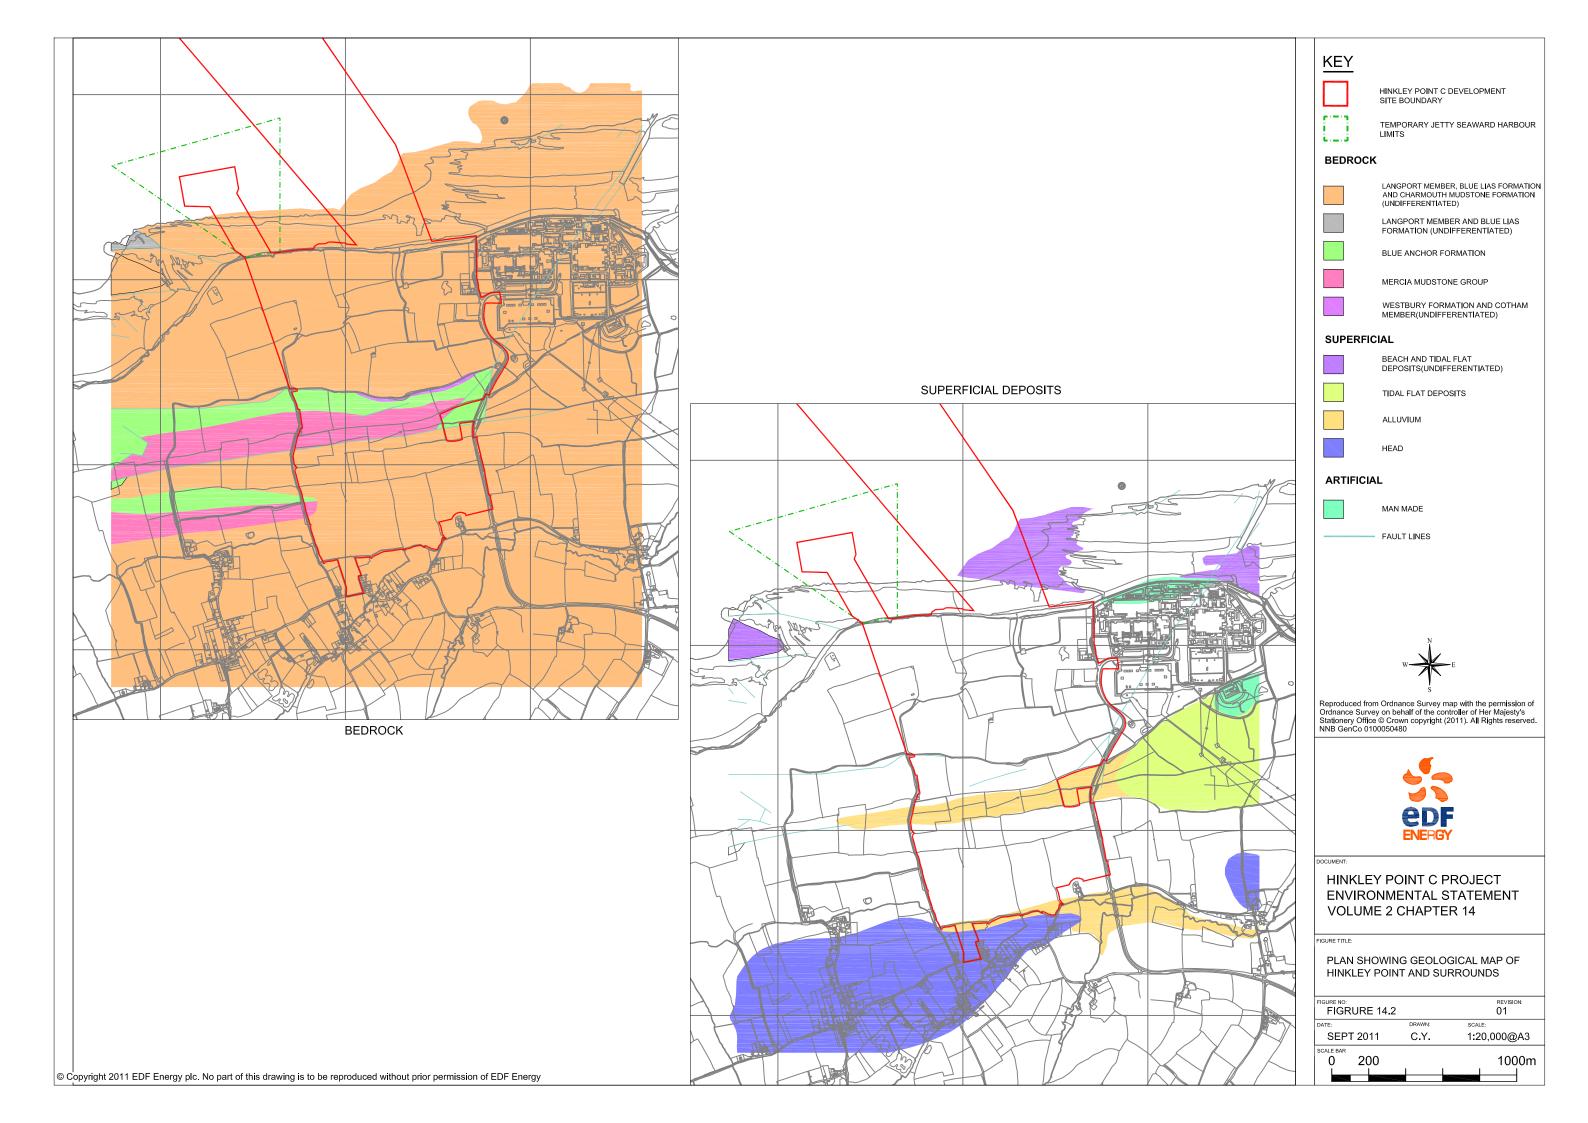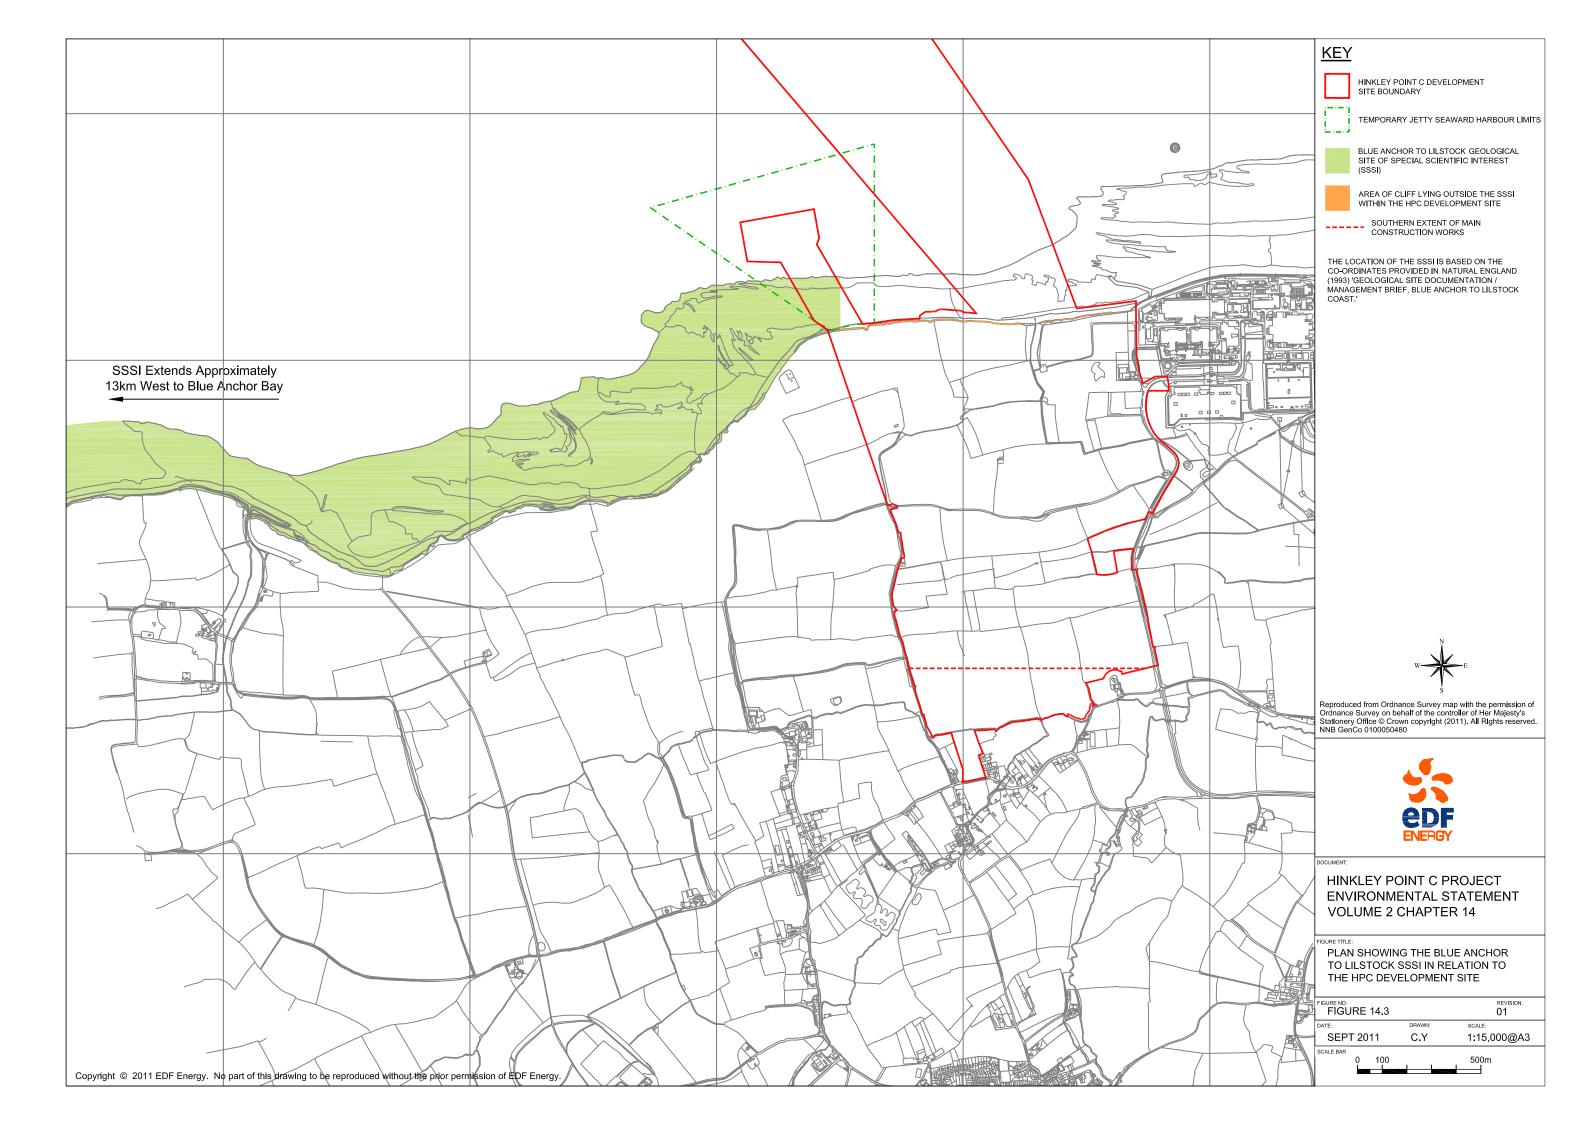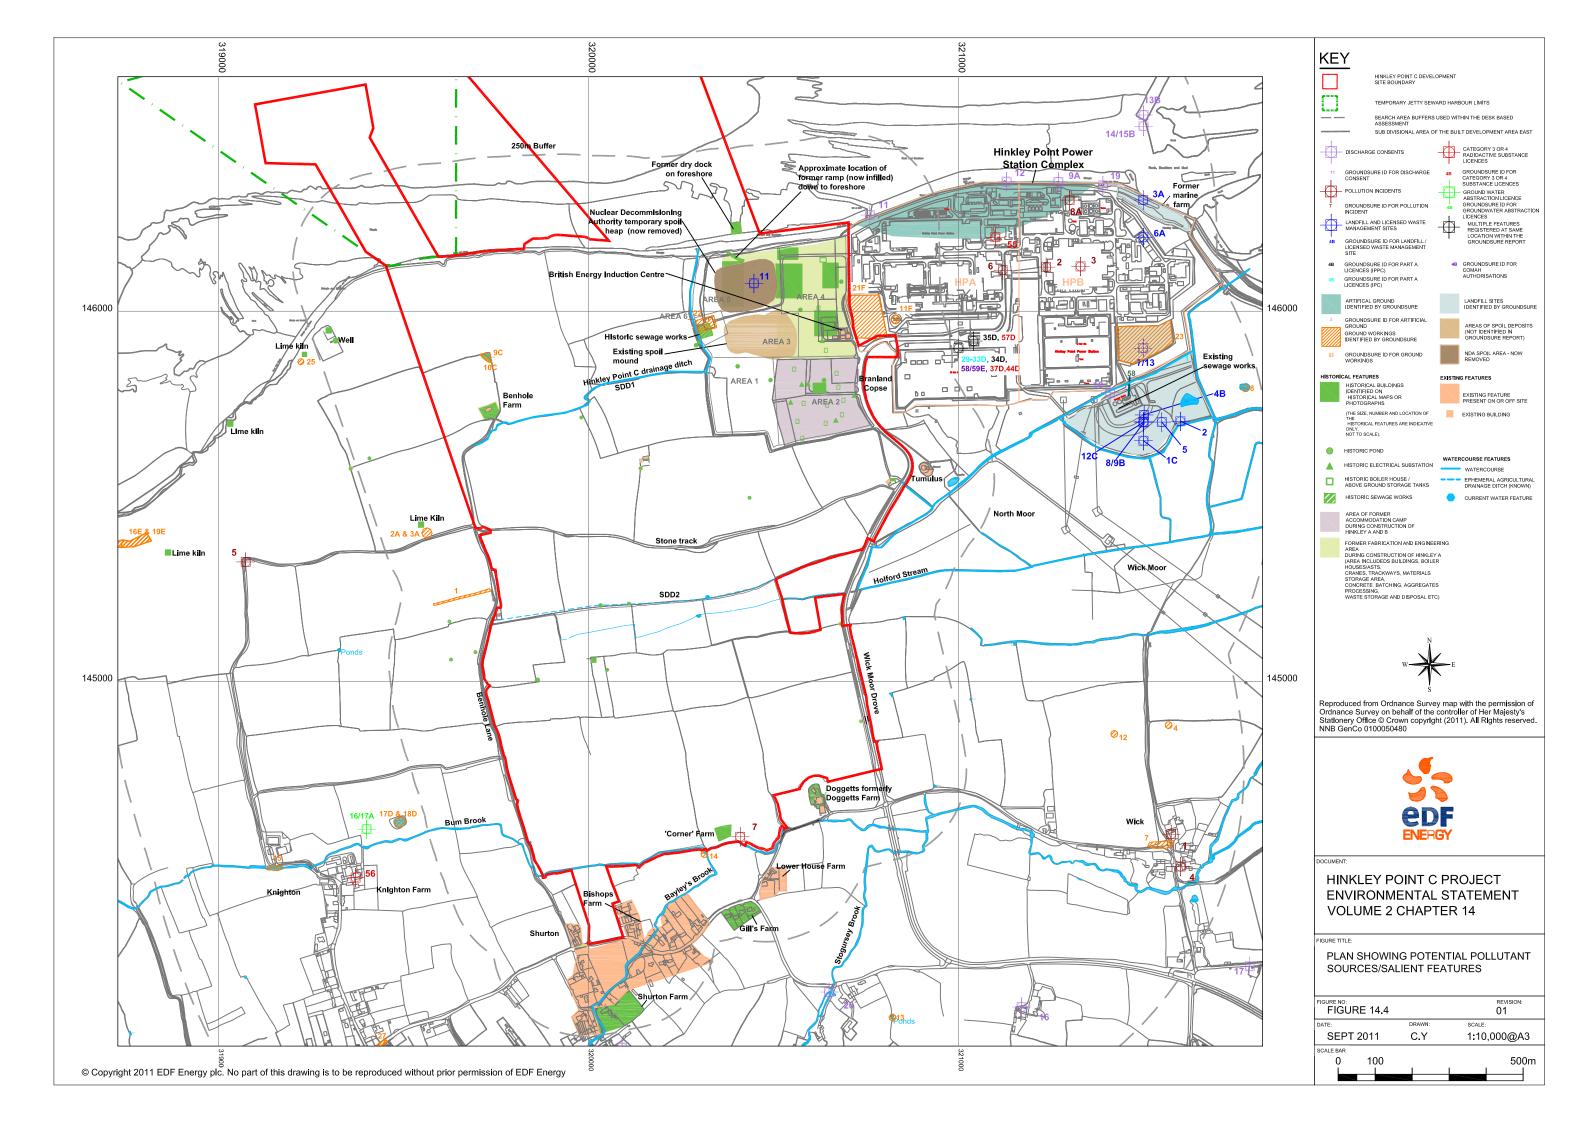


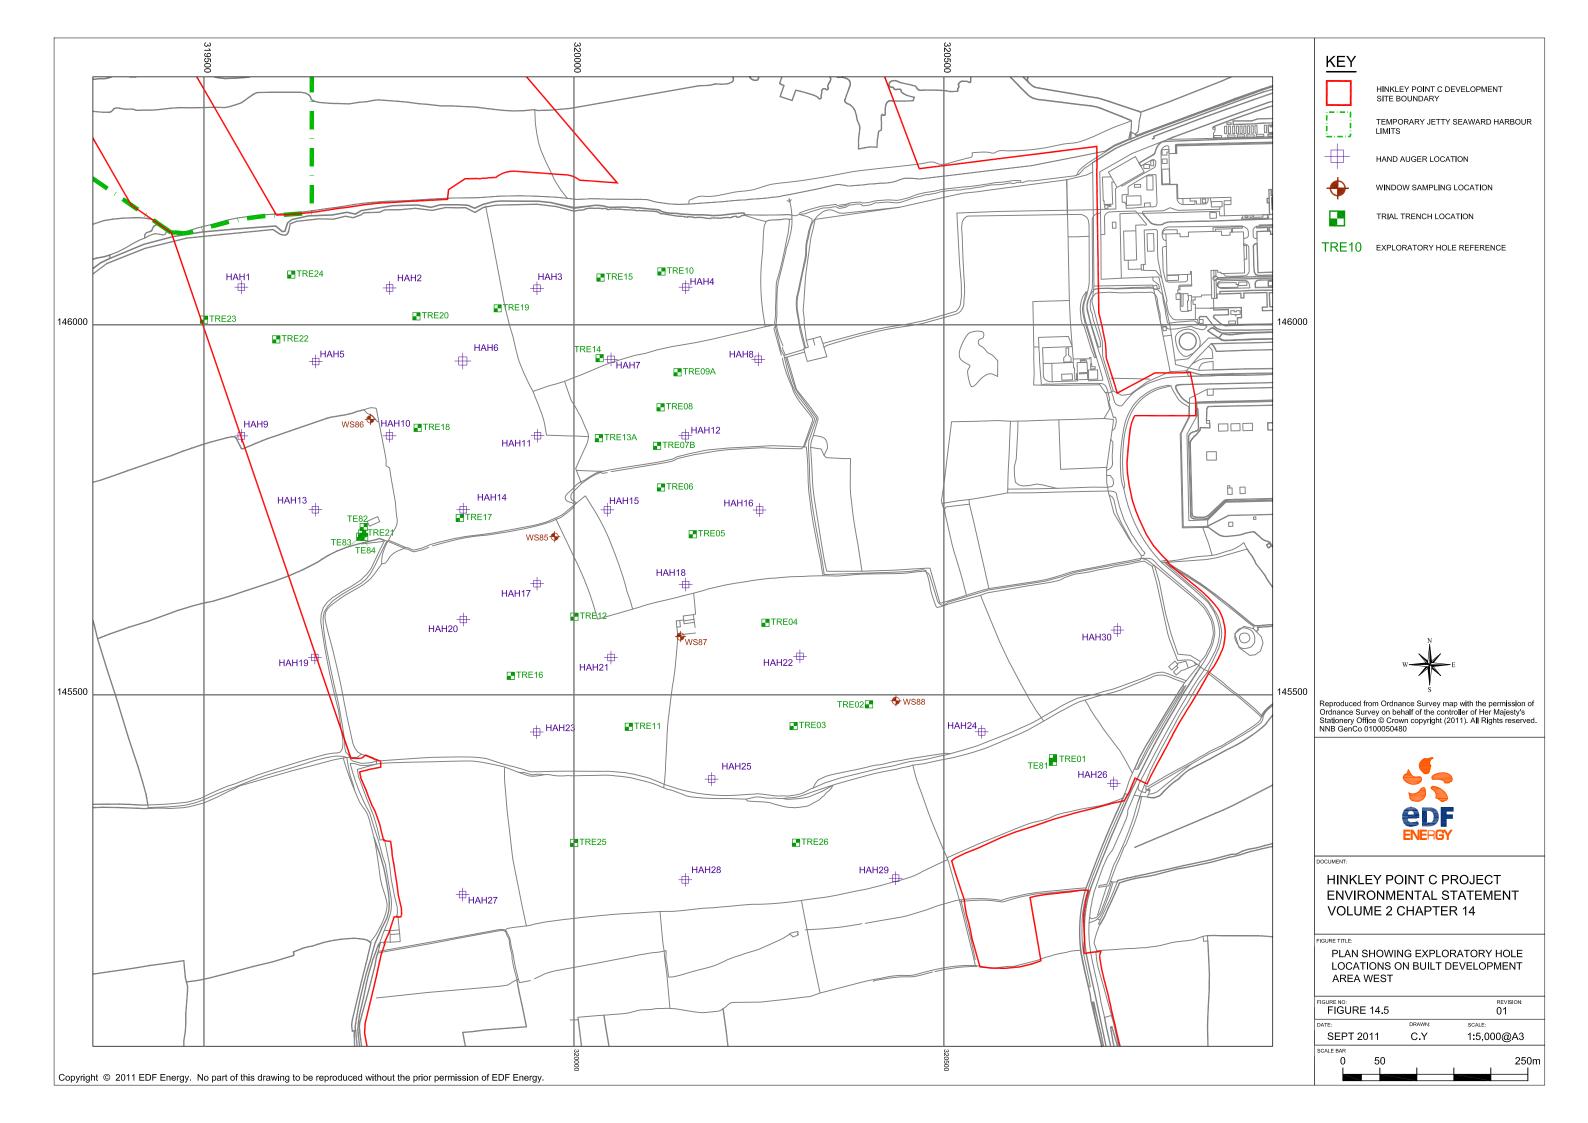






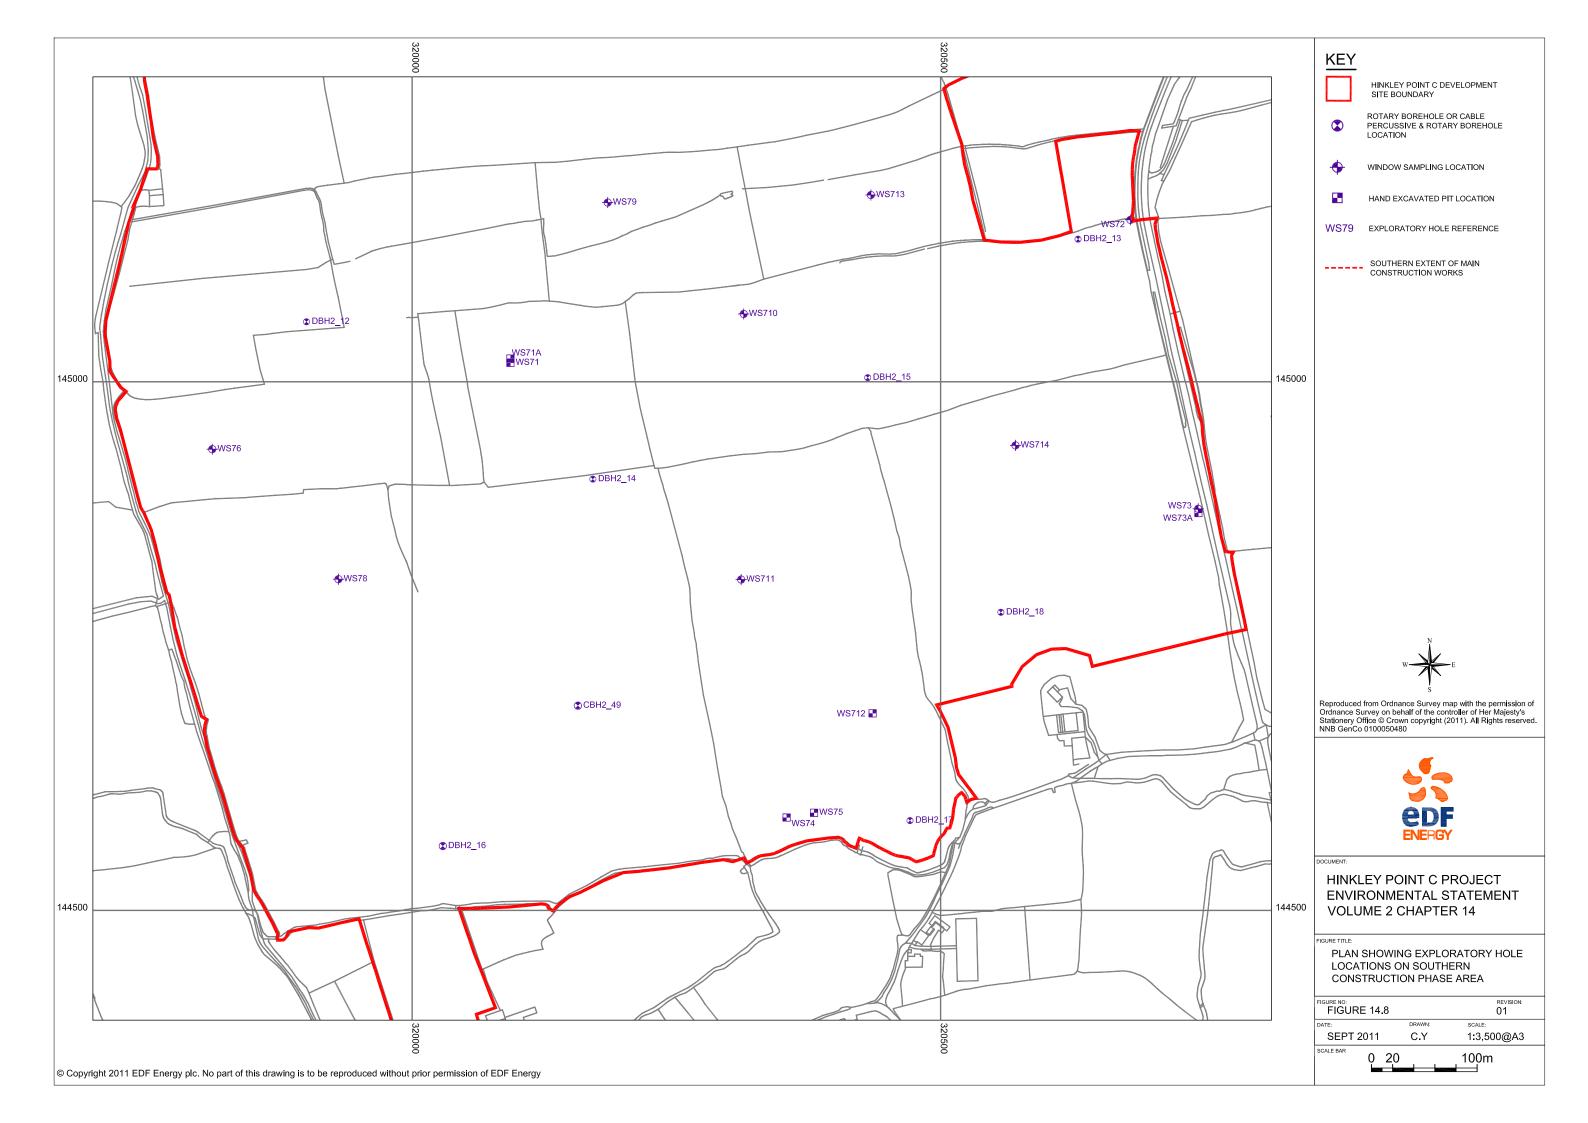


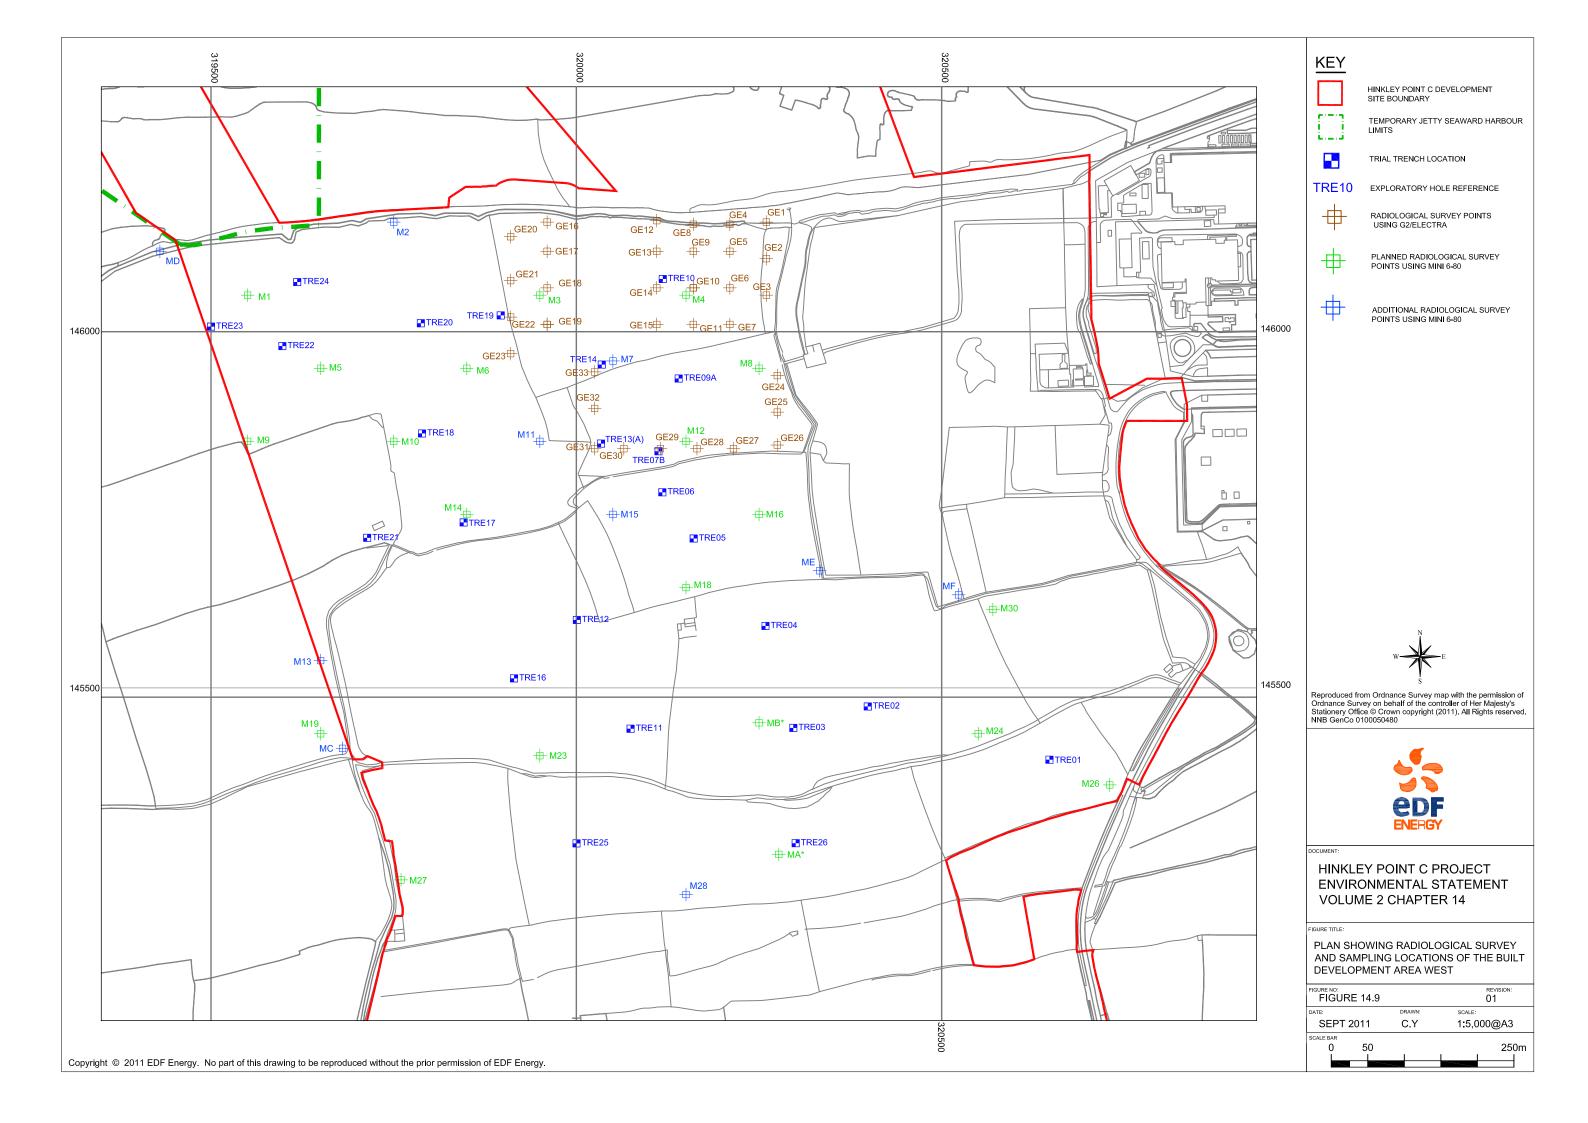








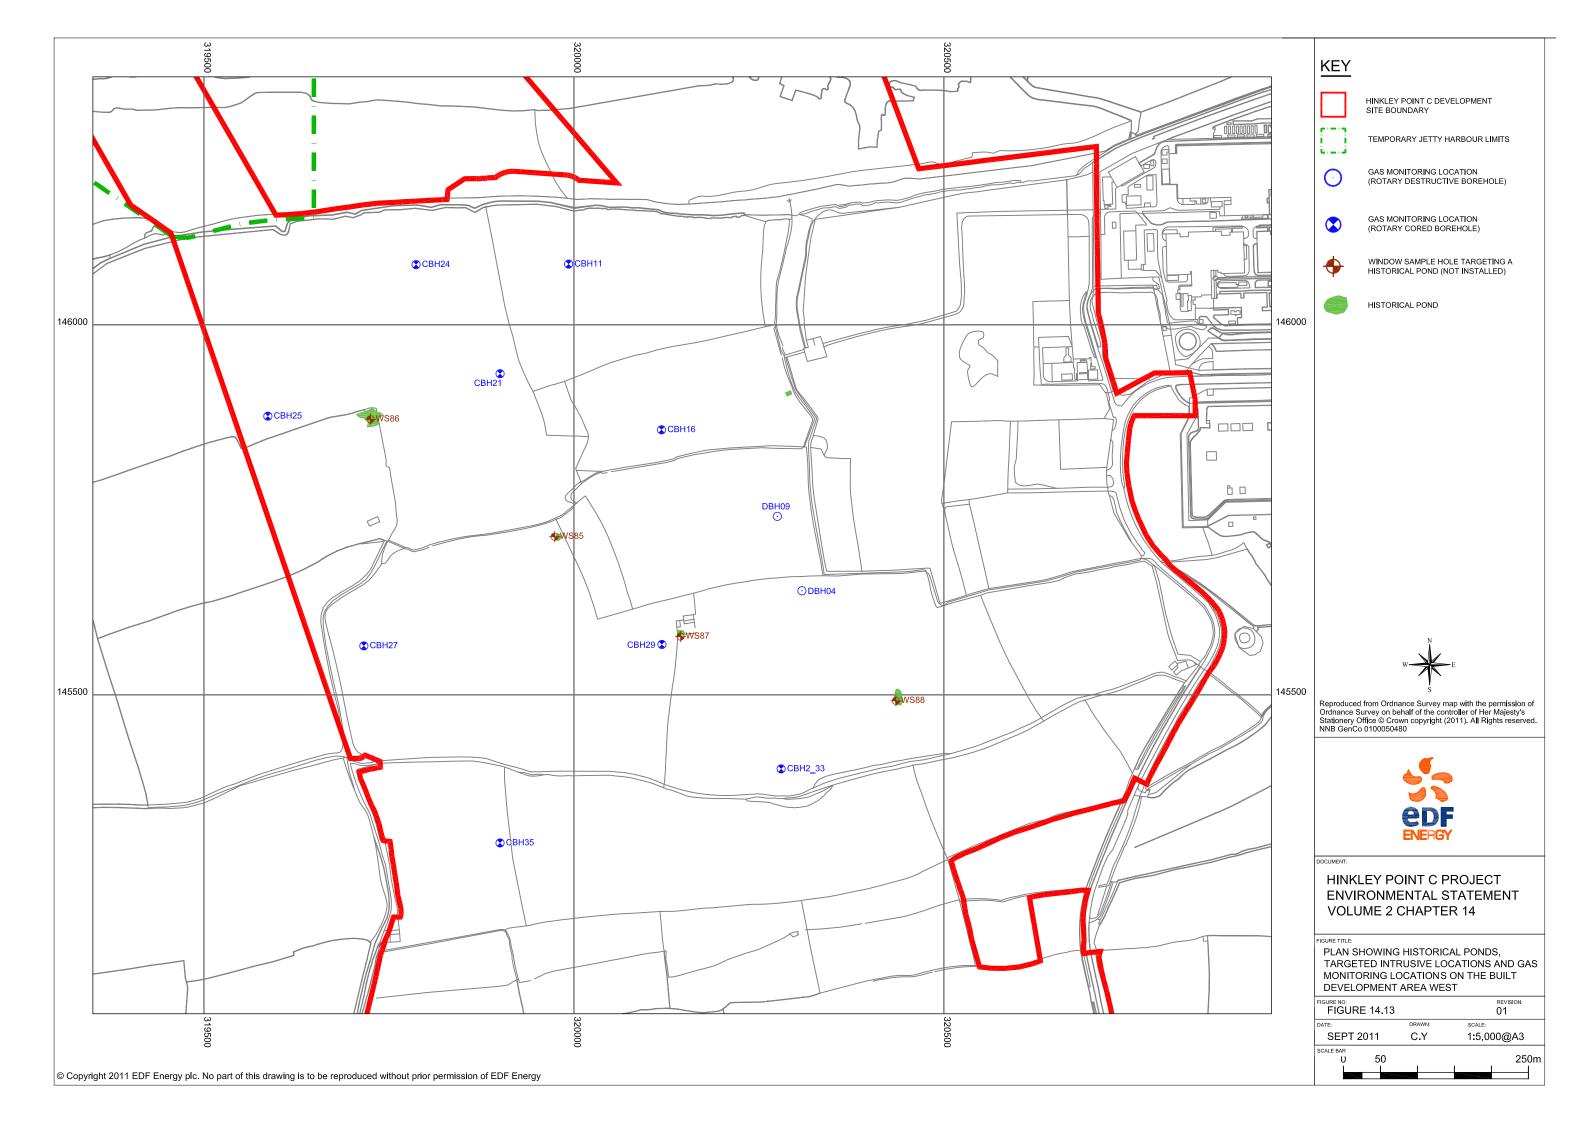


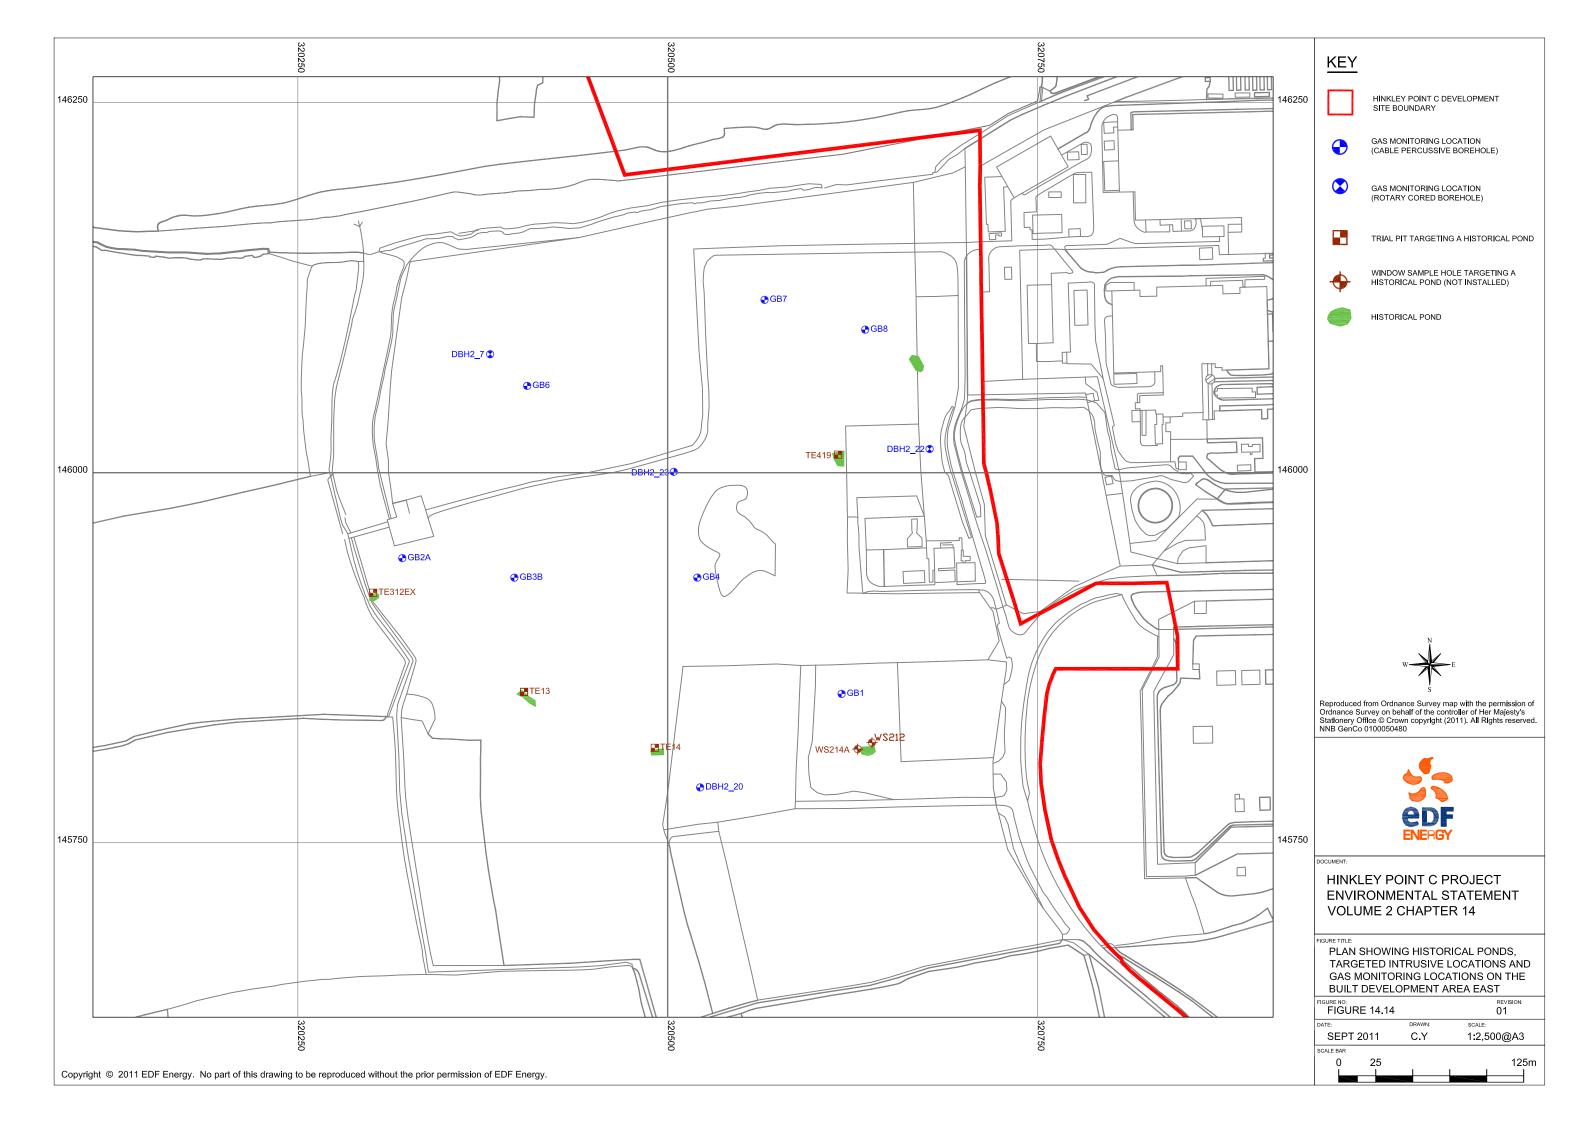


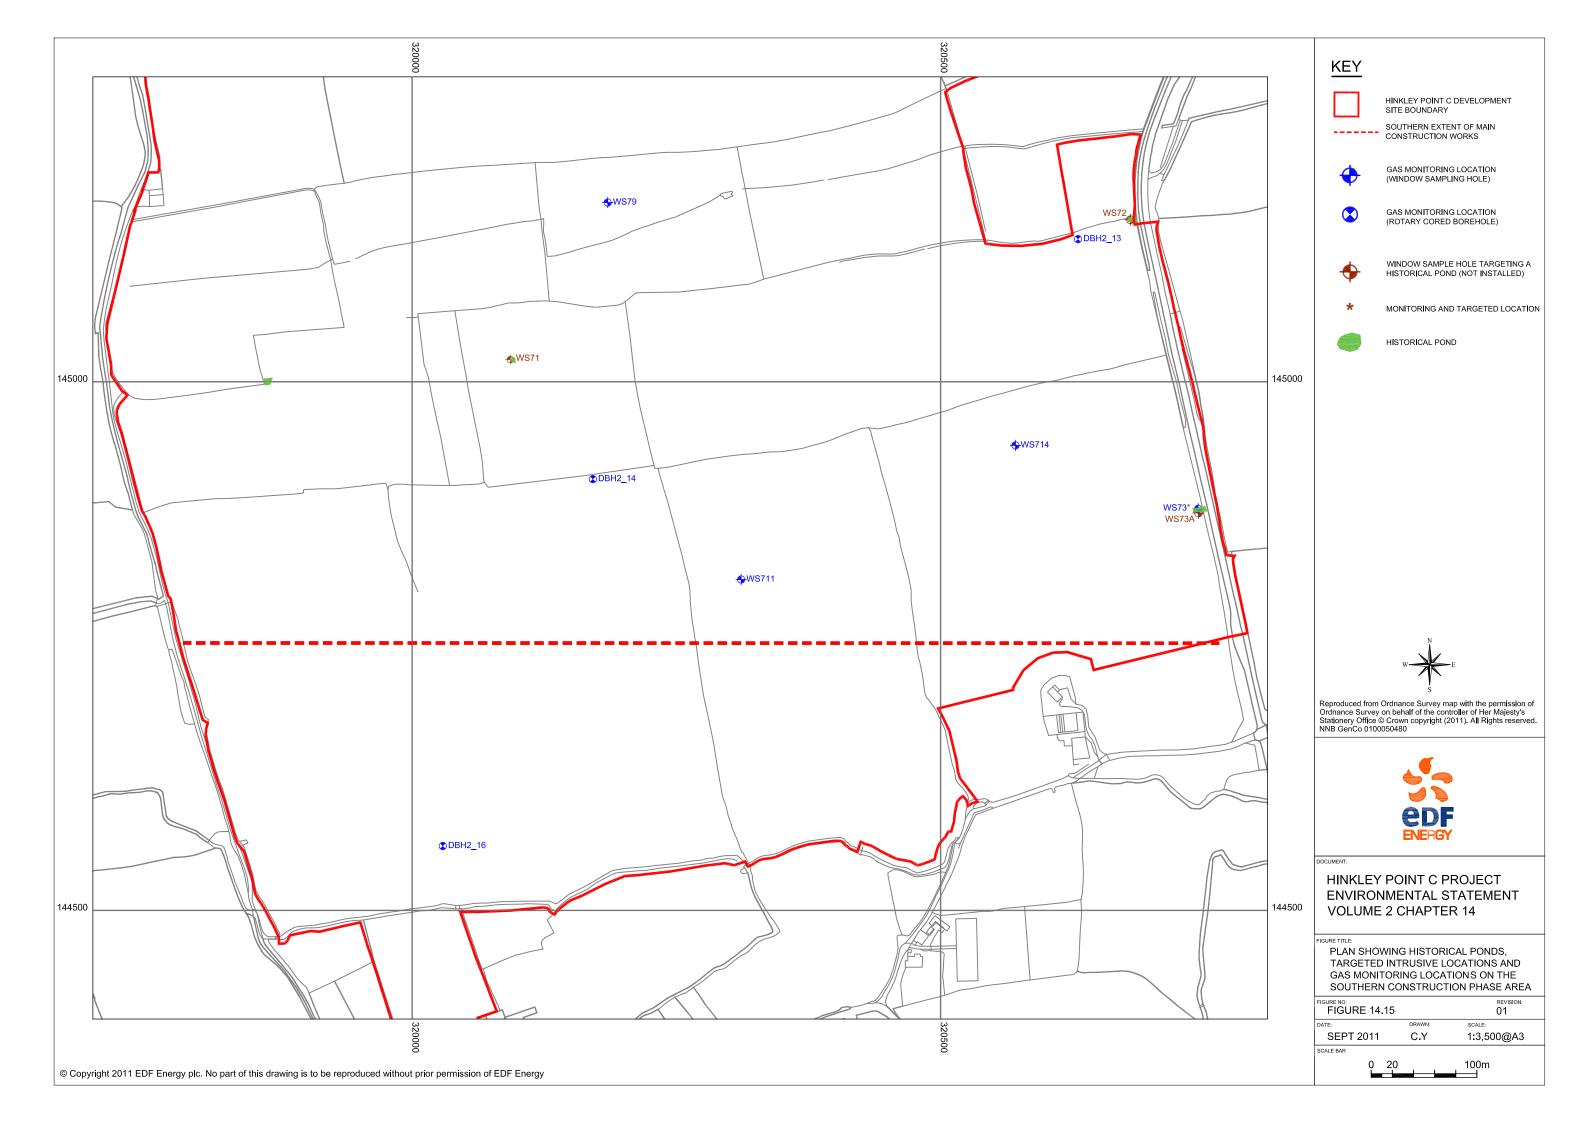


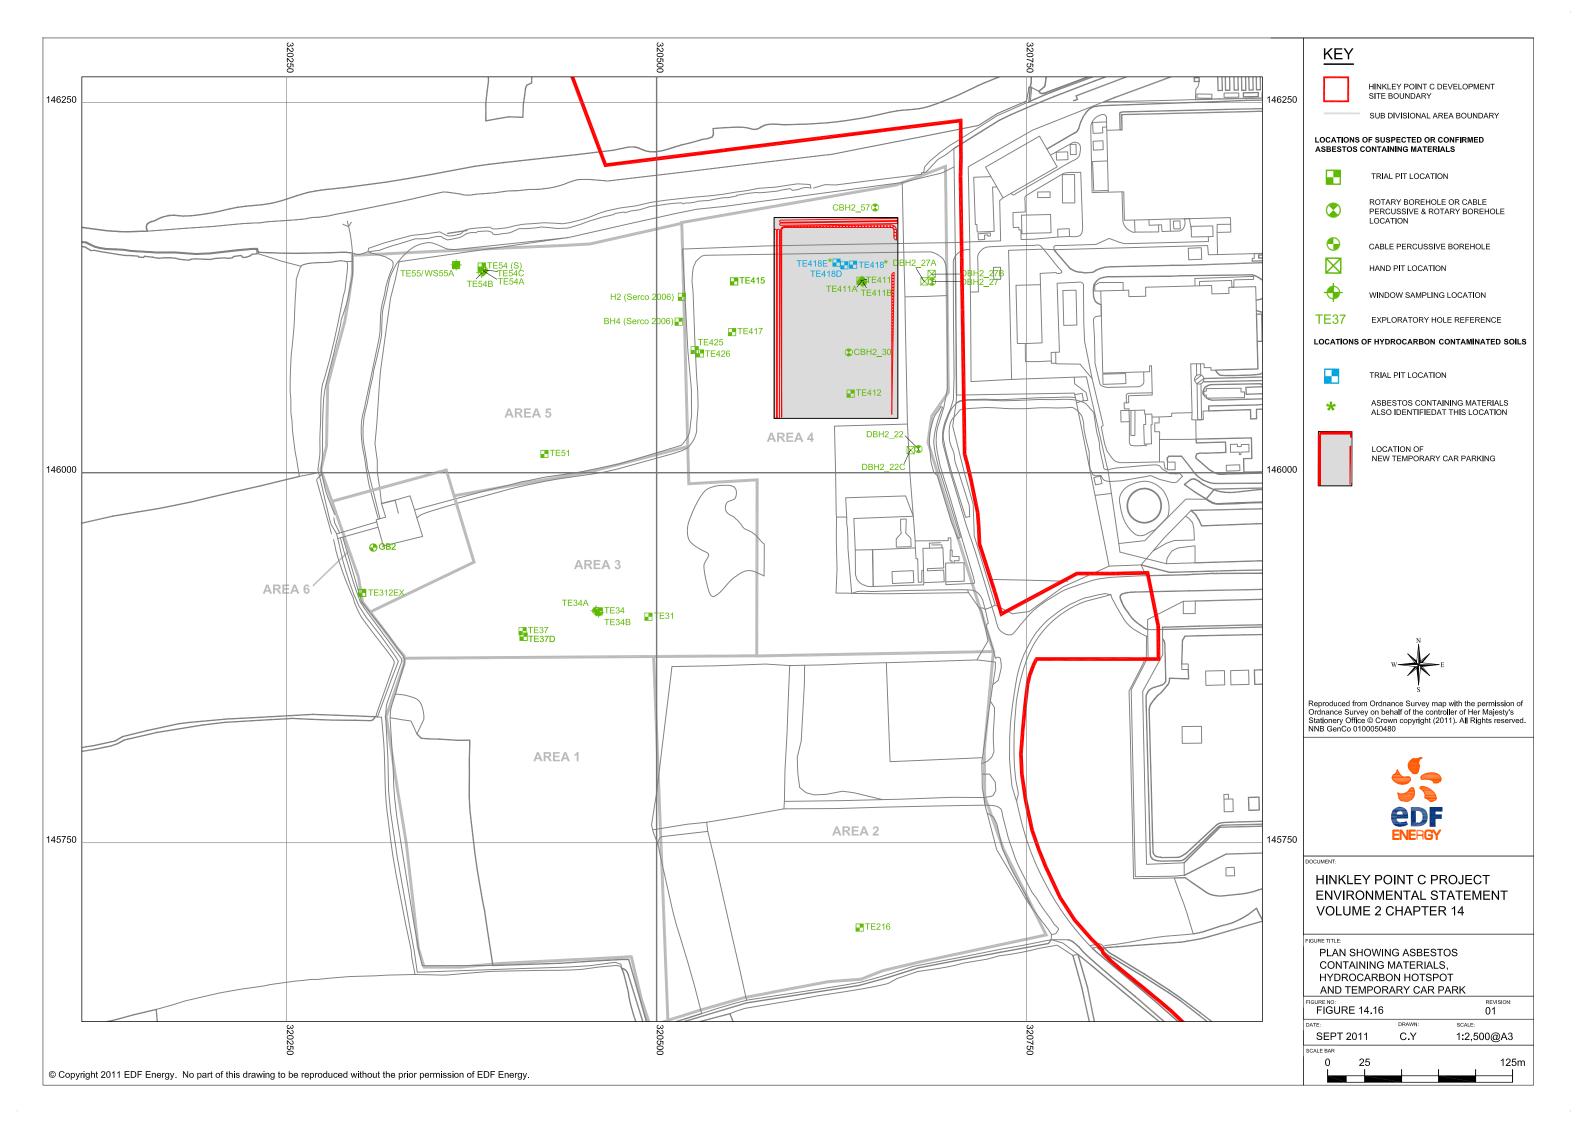


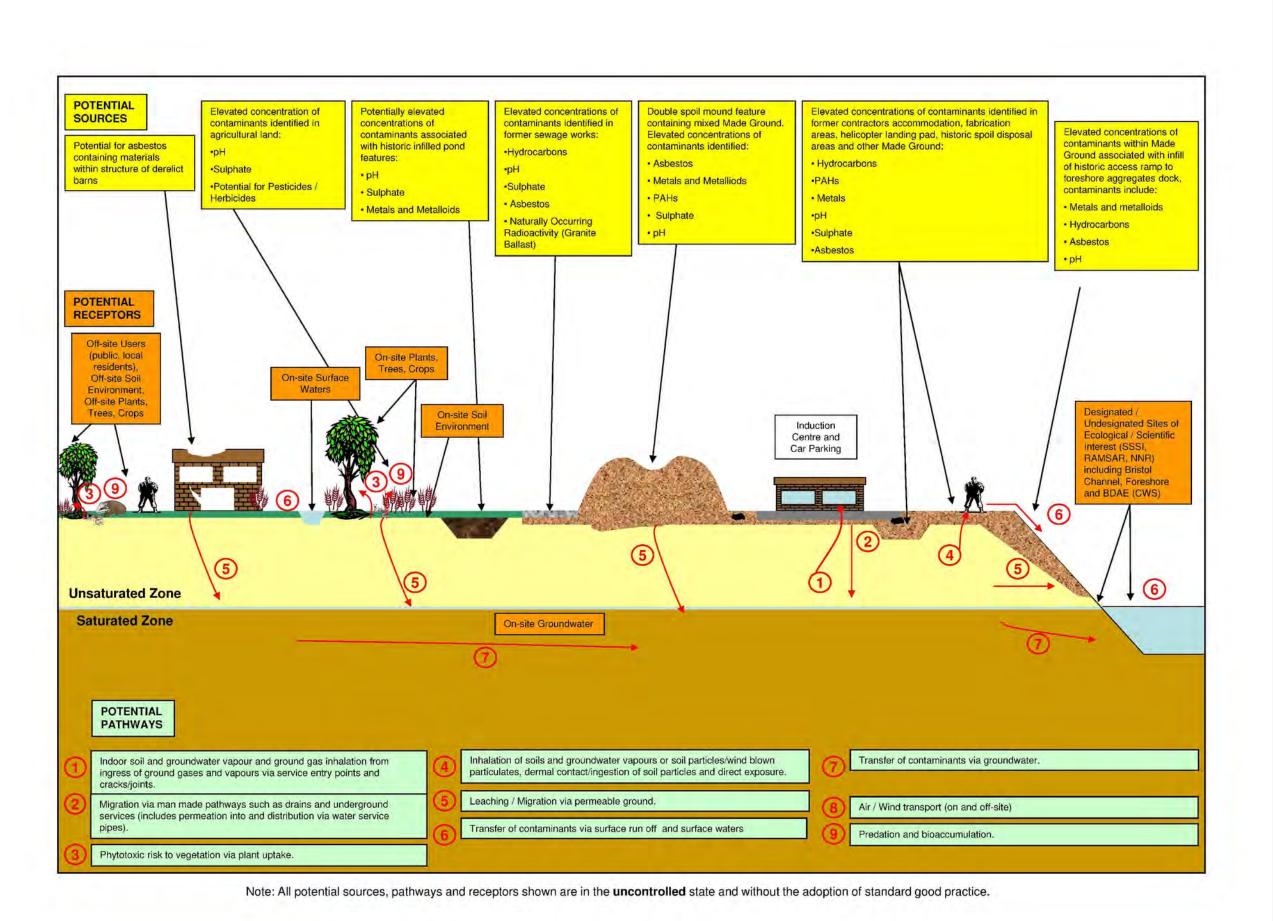












 $W \longrightarrow E$

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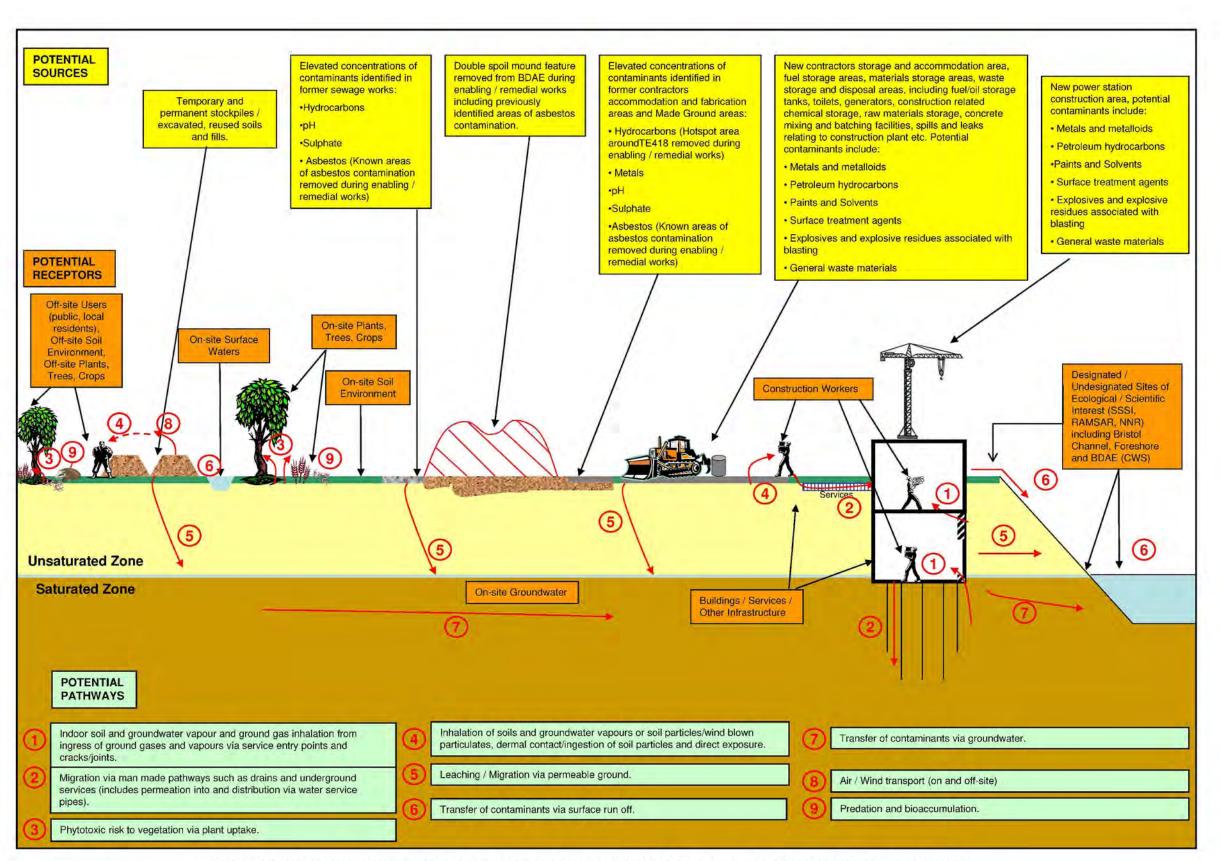
DOCUMENT:

HINKLEY POINT C PROJECT ENVIRONMENTAL STATEMENT VOLUME 2 CHAPTER 14

FIGURE TITLE

BASELINE (PRE ENABLING/REMEDIAL WORKS) SCHEMATIC CONCEPTUAL SITE MODEL

FIGURE 14.17		REVISION:		
DATE:	DRAWN:	SCALE:		
SEPT 2011	C.Y	NTS		
SCALE BAR				



Note: All potential sources, pathways and receptors shown are in the uncontrolled state and without the adoption of standard good practice.




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HINKLEY POINT C PROJECT ENVIRONMENTAL STATEMENT VOLUME 2 CHAPTER 14

FIGURE TI

CONSTRUCTION PHASE (POST ENABLING/REMEDIAL WORKS) SCHEMATIC CONCEPTUAL SITE MODEL

FIGURE NO: FIGURE 14.18			REVISION:
DATE:	DRAWN:	SCALE:	
SEPT 2011	C.Y	NTS	
SCALE BAR			



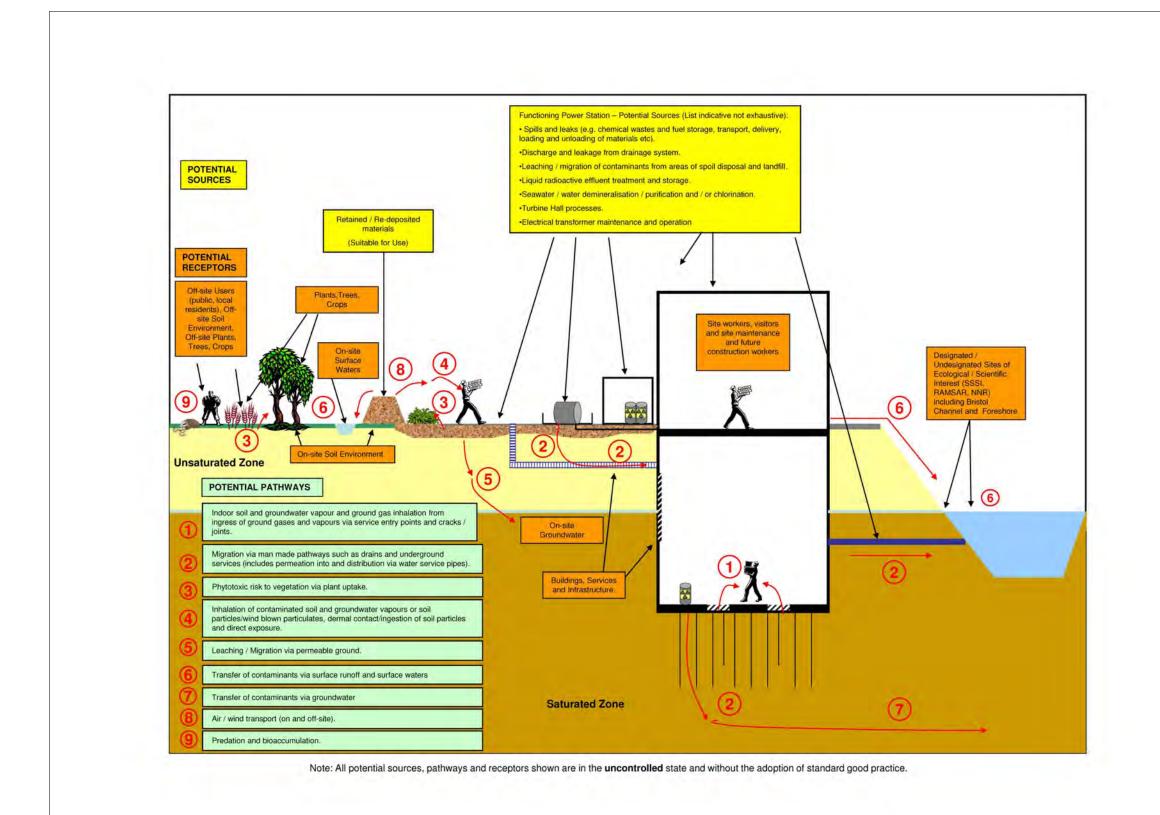


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HINKLEY POINT C PROJECT ENVIRONMENTAL STATEMENT VOLUME 2 CHAPTER 14

FIGURE TITLE:

OPERATIONAL PHASE SCHEMATIC SITE CONCEPTUAL MODEL

IGURE NO: FIGURE 14.19		REVISION:	
ATE:	DRAWN:	SCALE:	
SEPT 2011	C.Y	NTS	
CALE BAR			



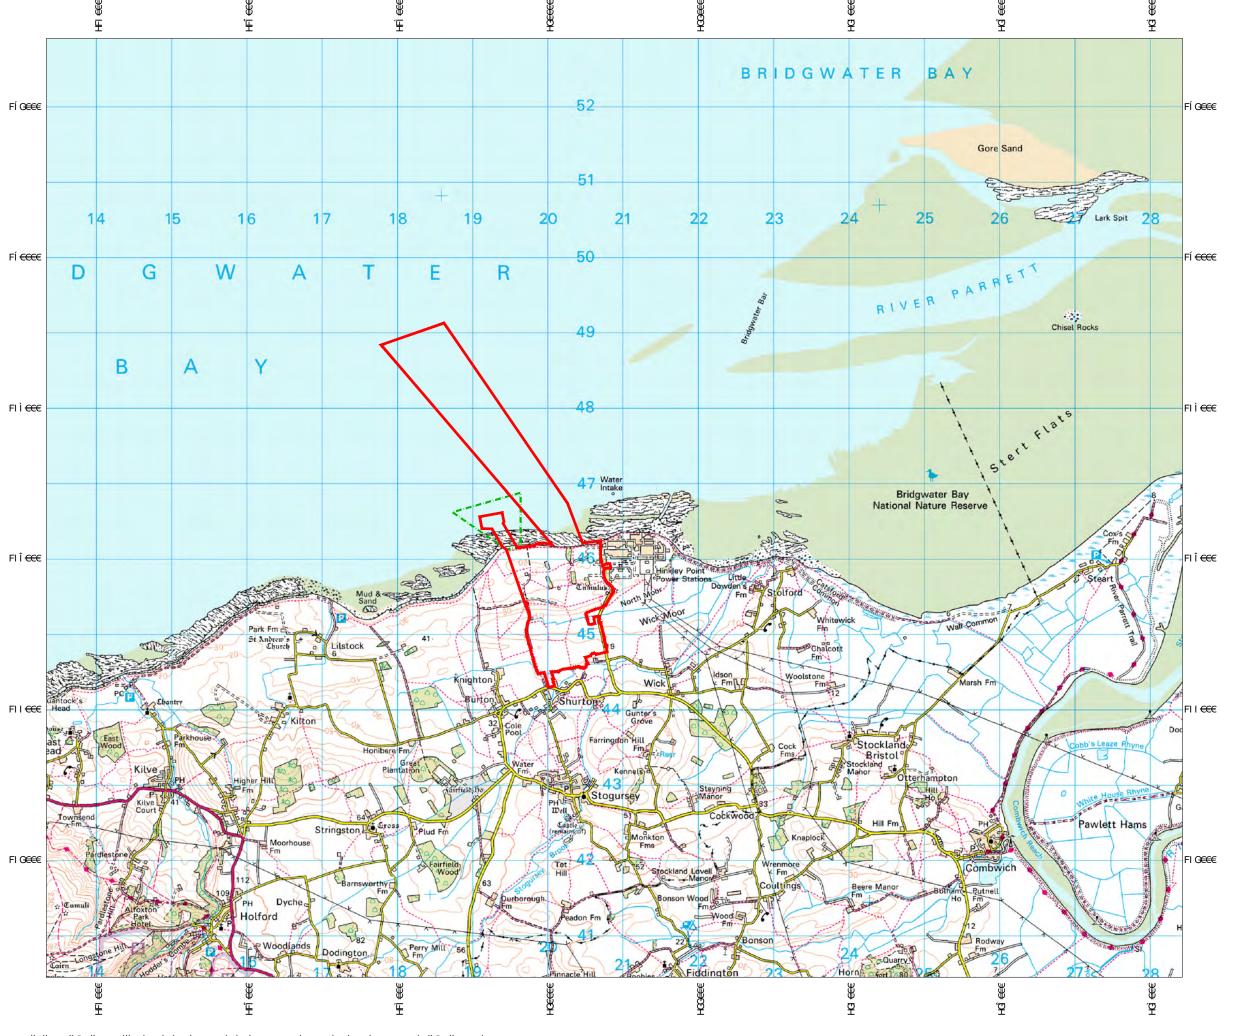



POPSŠÒŸÁÚUOPVÁÔÁÖÒXÒŠUÚTÒÞV ÙOYÒÁÓUNÞ֌ܟ

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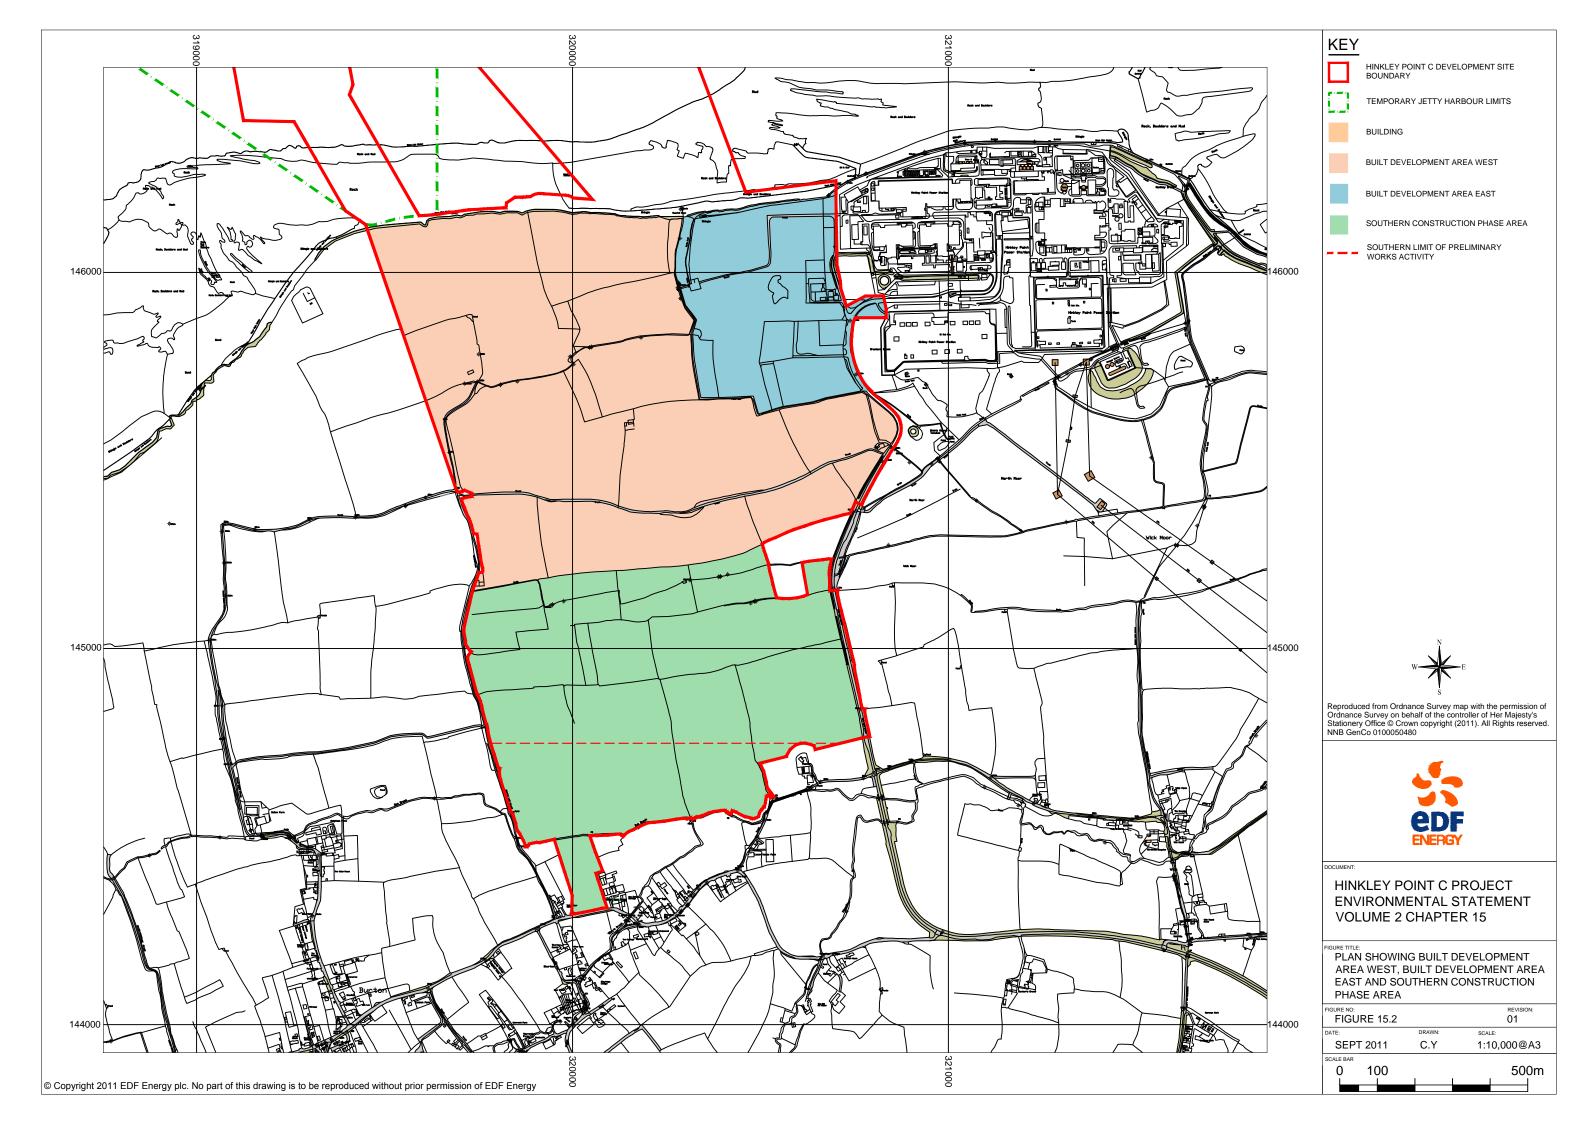
ÖUÔWT ÒÞVI


POPSŠÒŸÁÚUOPVÁÔÁÚÜURÒÔV ÒÞXOÜUÞT ÒÞVOŒÁÛVOE/ÒT ÒÞV XUŠWT ÒÁGÁÔPOŒÚVÒÜÆFÍ

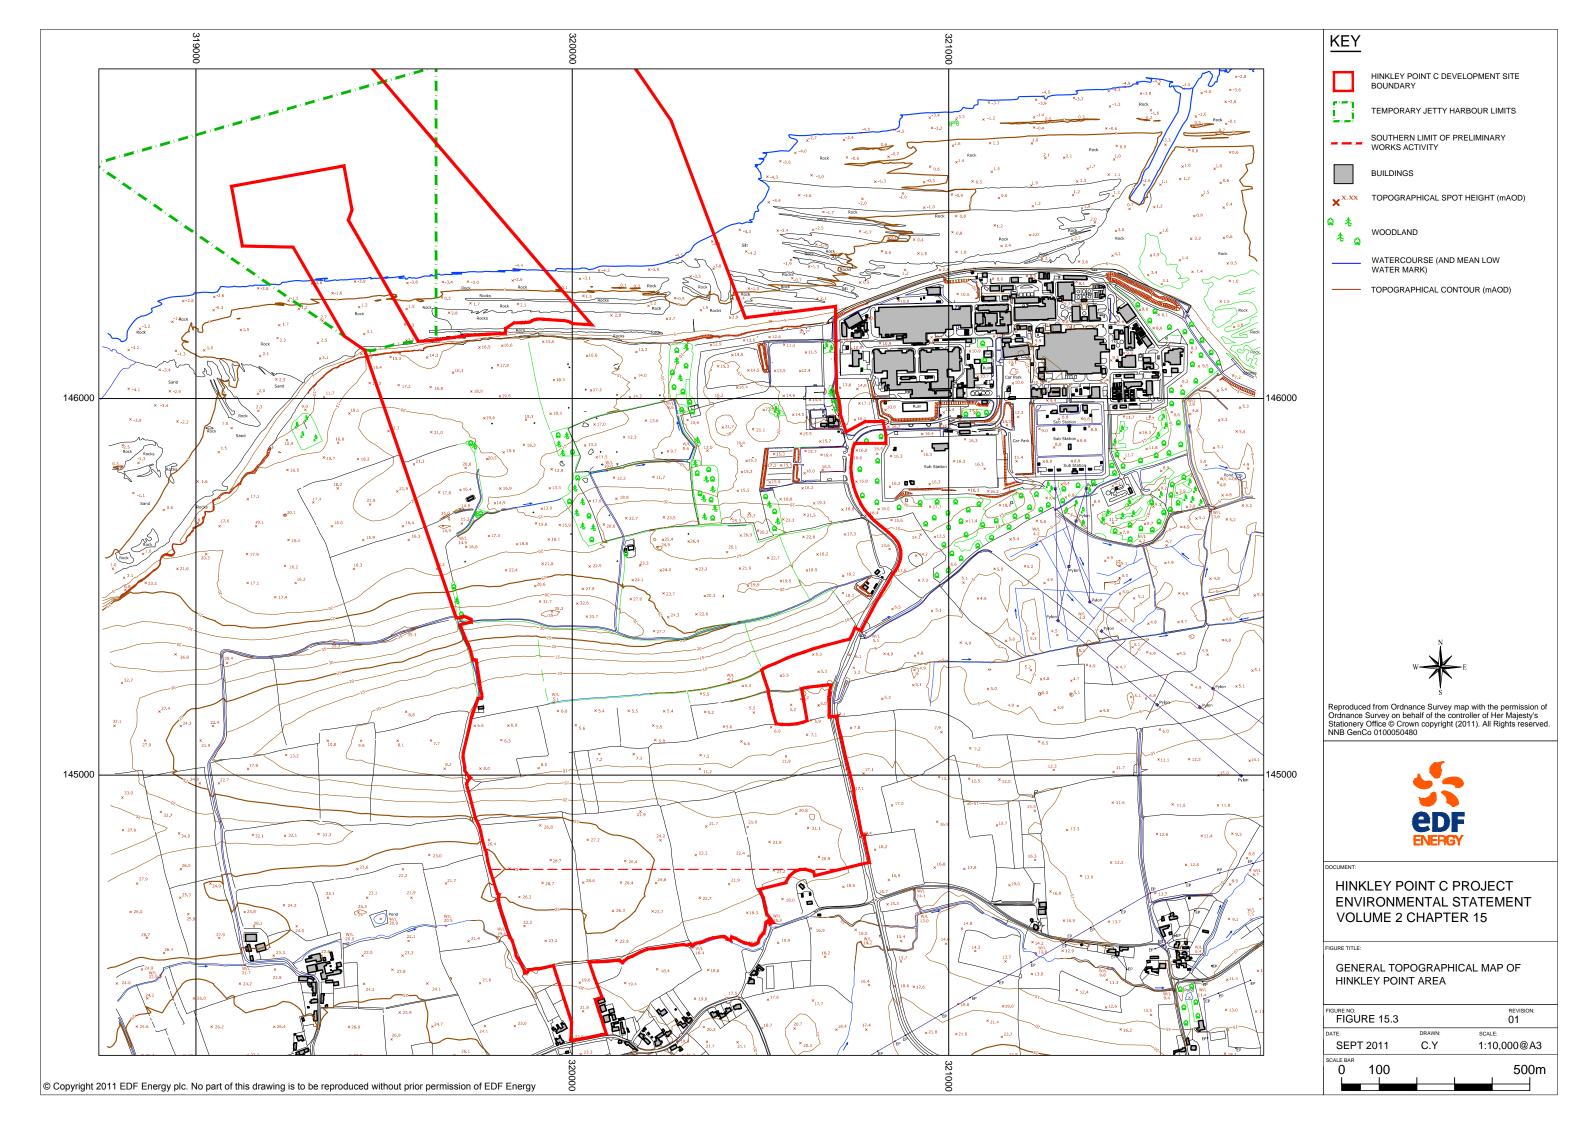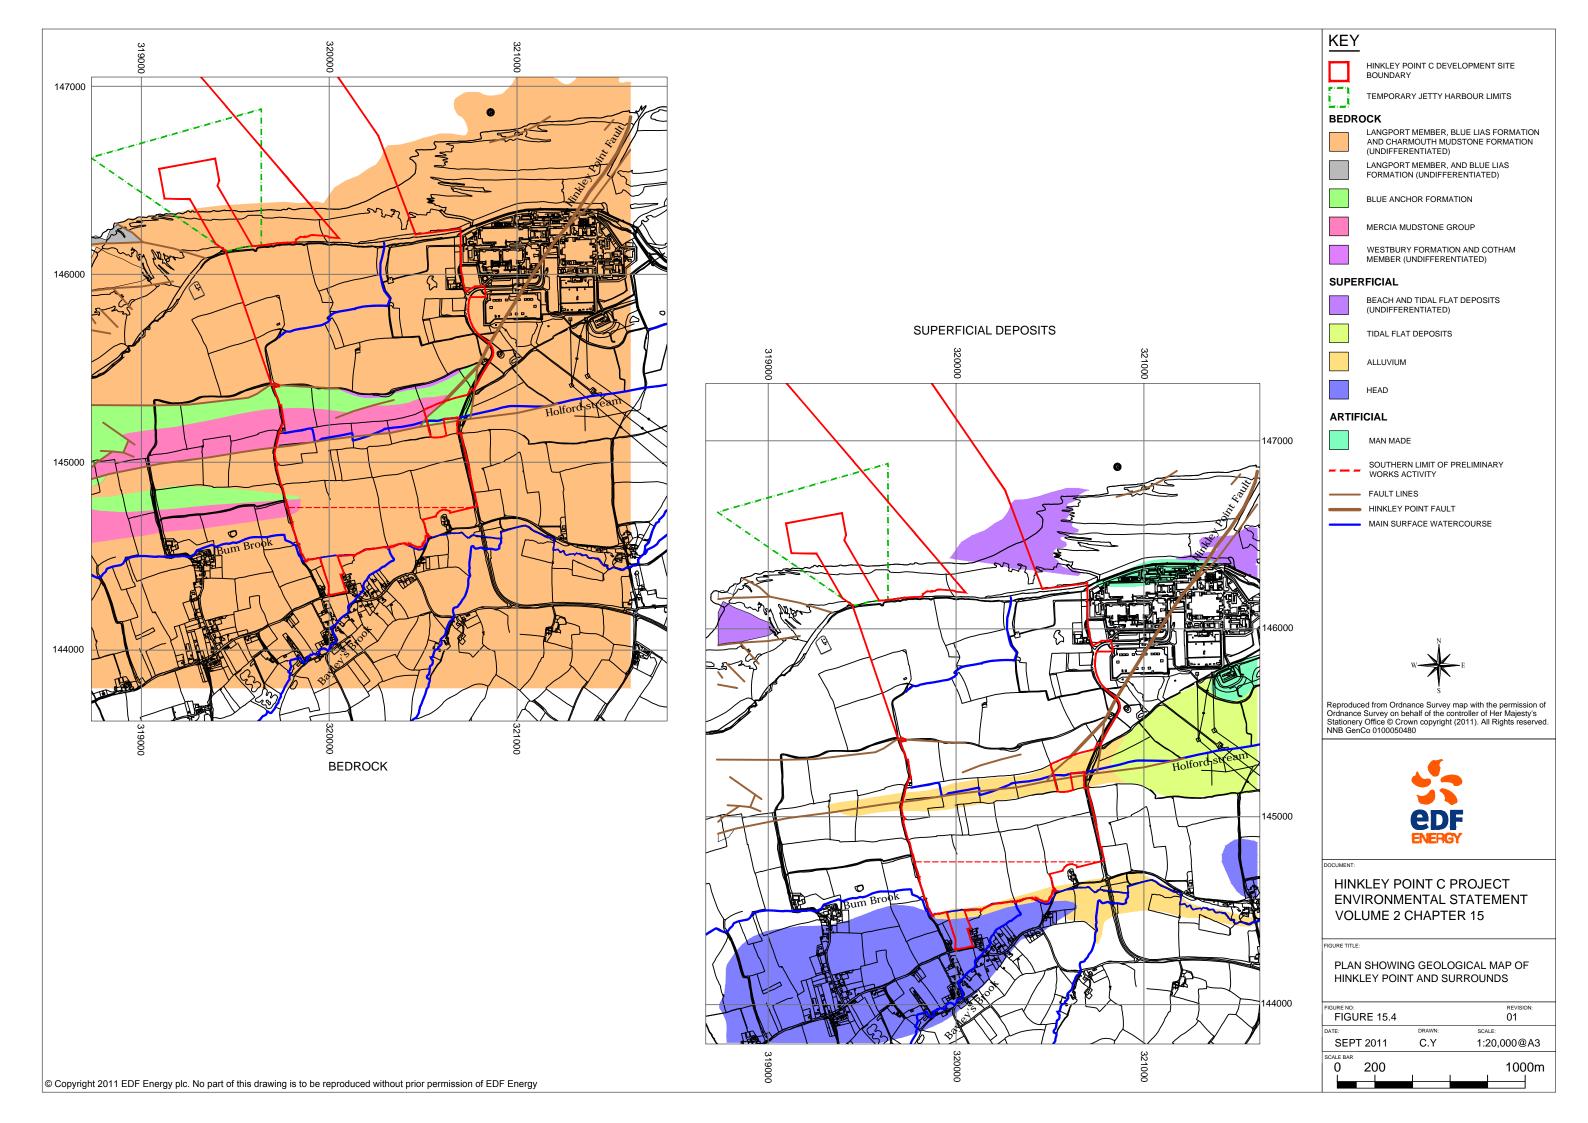
ZODÍWÚ ČÁVOVŠČK

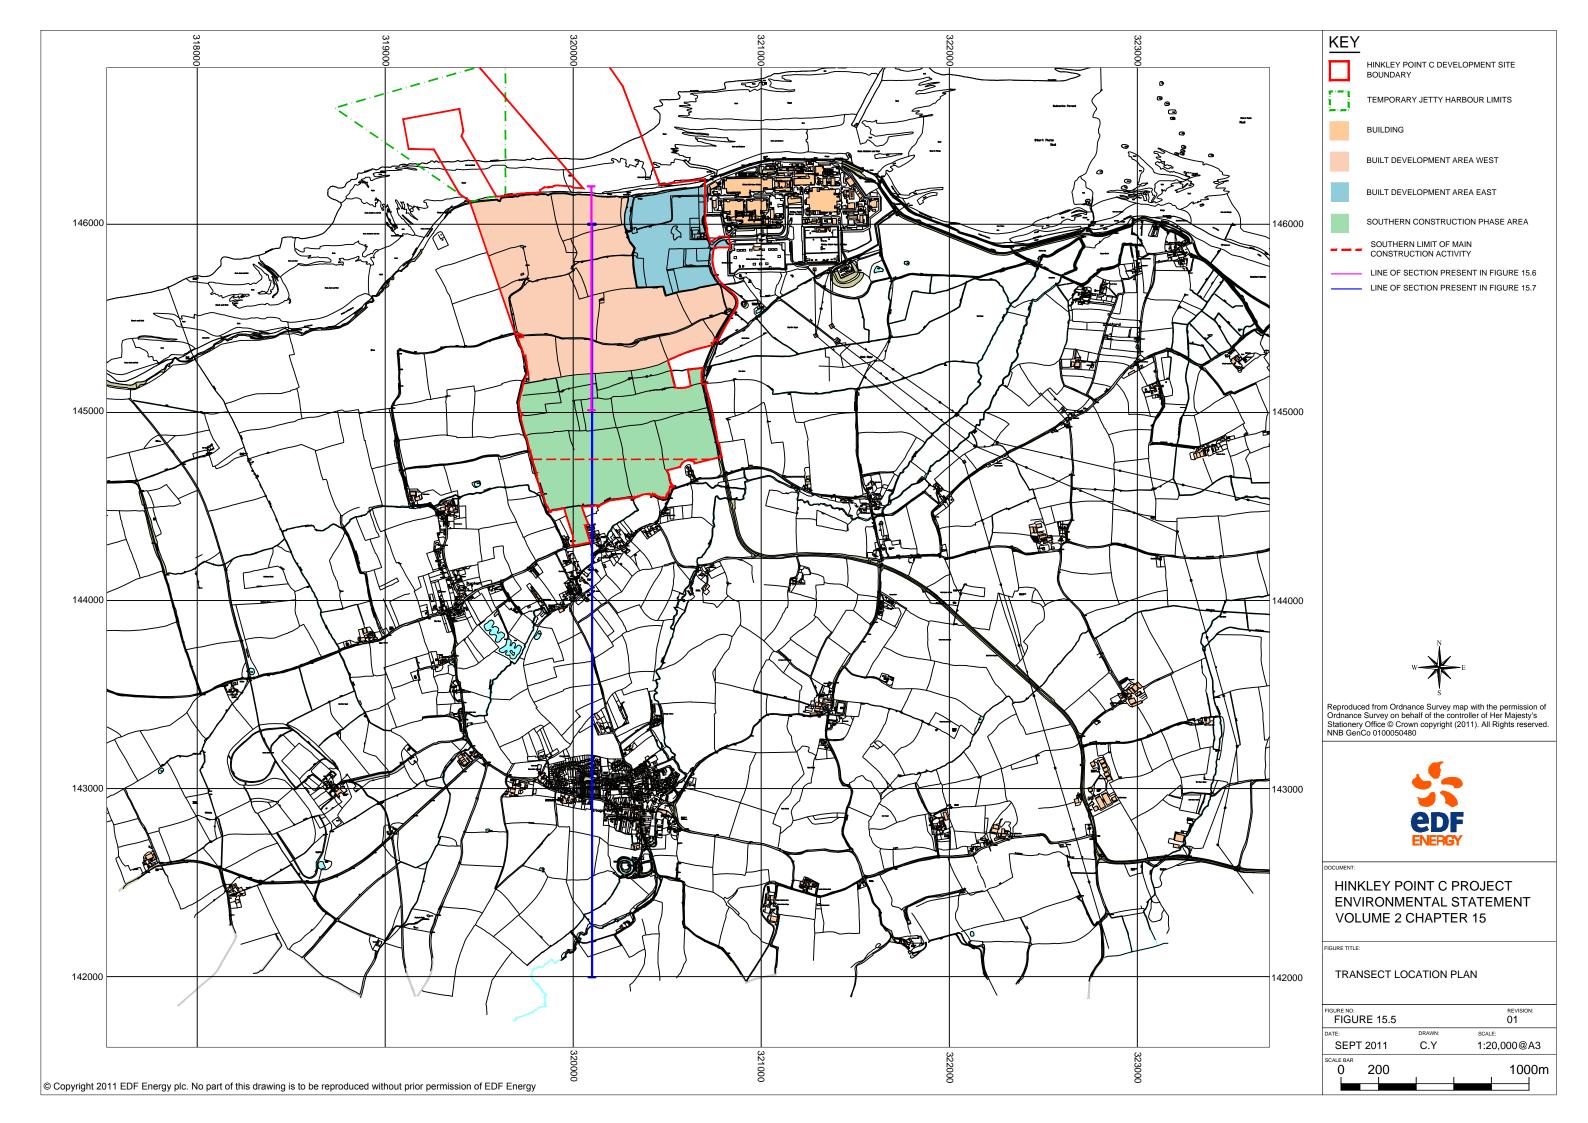
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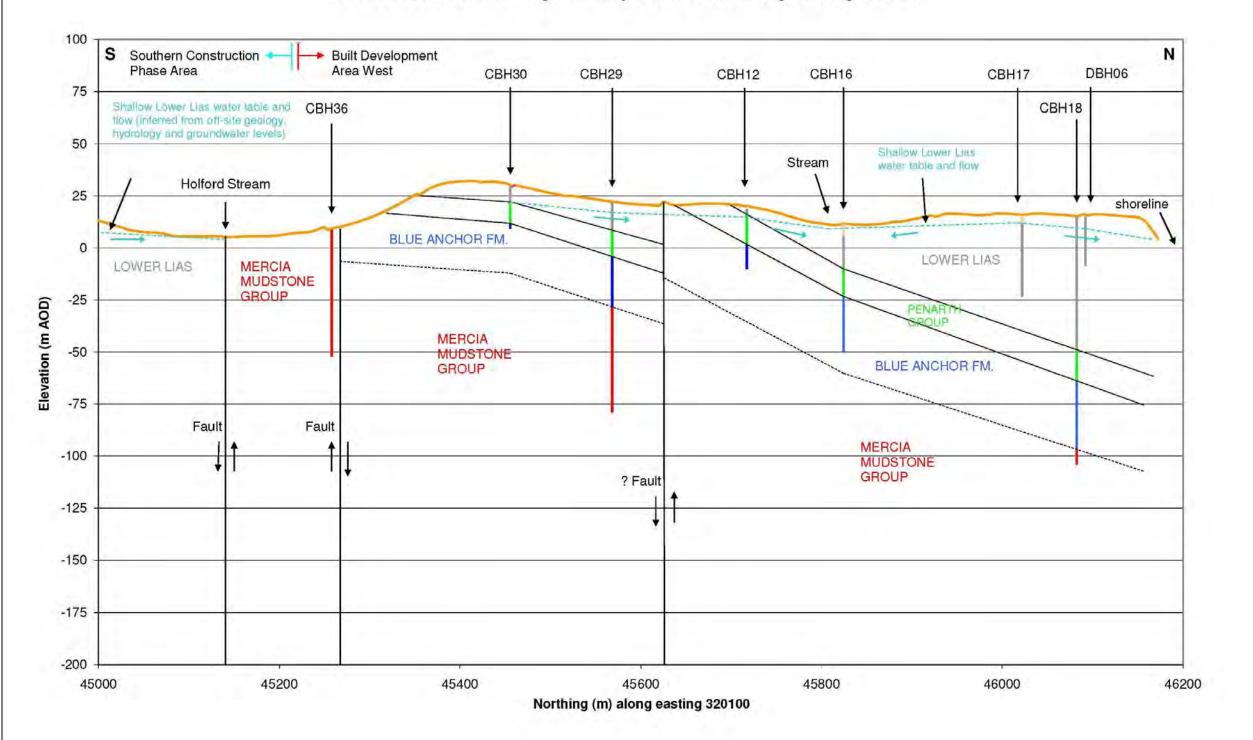








Cross section S-N through Hinkley Point C site along easting 320100





SEE DETAIL WITHIN FIGURE

BOREHOLE DRILL DATES
CBH12 12 - 28 AUGUST 2008
CBH16 2 - 10 SEPTEMBER 2008 CBH17 CBH18 10 - 11 SEPTEMBER 2008 18 SEPTEMBER - 24 OCTOBER 2008 5 AUGUST - 10 SEPTEMBER 2008 13 - 15 AUGUST 2008


CBH30 4 - 7 AUGUST 2008 9 SEPTEMBER 2008



HINKLEY POINT C PROJECT **ENVIRONMENTAL STATEMENT VOLUME 2 CHAPTER 15**

CROSS SECTION S-N THROUGH HINKLEY POINT C ALONG EASTING 320100

FIGURE 15.6	REVISION: 01	
DATE:	DRAWN:	SCALE:
SEPT 2011 C.Y		AS SHOWN
SCALE BAR		

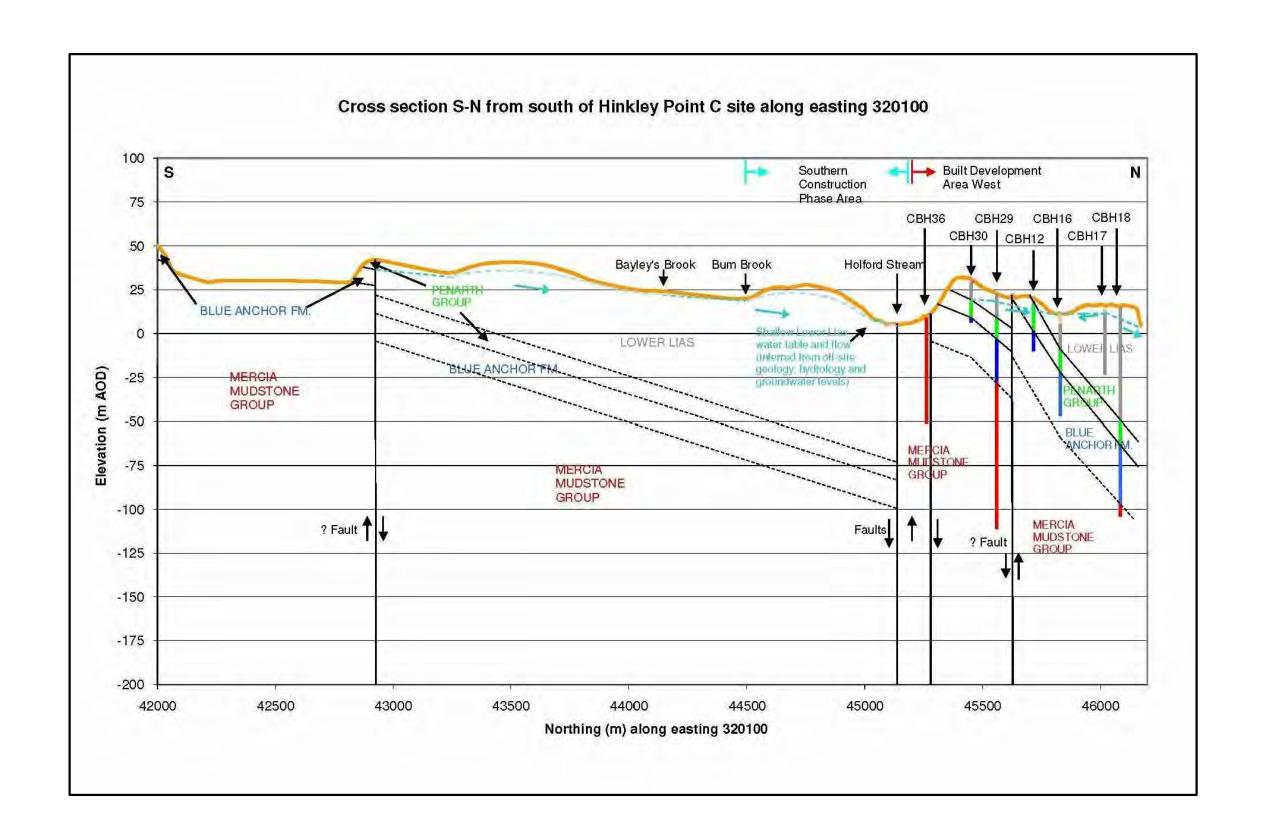

KEY

SEE DETAIL WITHIN FIGURE

 BOREHOLE DRILL DATES

 CBH12
 12 - 28 AUGUST 2008

 CBH16
 2 - 10 SEPTEMBER 2008

 CBH17
 10 - 11 SEPTEMBER 2008
 18 SEPTEMBER - 24 OCTOBER 2008 5 AUGUST - 10 SEPTEMBER 2008 CBH18

13 - 15 AUGUST 2008 4 - 7 AUGUST 2008



HINKLEY POINT C PROJECT **ENVIRONMENTAL STATEMENT VOLUME 2 CHAPTER 15**

CROSS SECTION S-N FROM SOUTH OF HINKLEY POINT C ALONG EASTING 320100

FIGURE NO: FIGURE 15.7		REVISION: 01
DATE:	DRAWN:	SCALE:
SEPT 2011	C.Y	AS SHOWN
SCALE BAR		

KEY

SEE NOTES WITHIN FIGURE



-THIN NODULAR LIMESTONE UNIT

-FINELY LAMINATED SHALE UNIT

-PERSISTENT LIMESTONE UNIT

NODULAR CALCAREOUS MUDSTONE UNIT




DOCUM


HINKLEY POINT C PROJECT ENVIRONMENTAL STATEMENT VOLUME 2 CHAPTER 15


FIGURE


PHOTOGRAPH OF BLUE LIAS FORMATION ON FORESHORE AT HINKLEY POINT


GURE NO: FIGURE 15.8		REVISION: 01	
ATE:	DRAWN:	SCALE:	
SEPT 2011	C.Y	NTS	
CALE BAR			

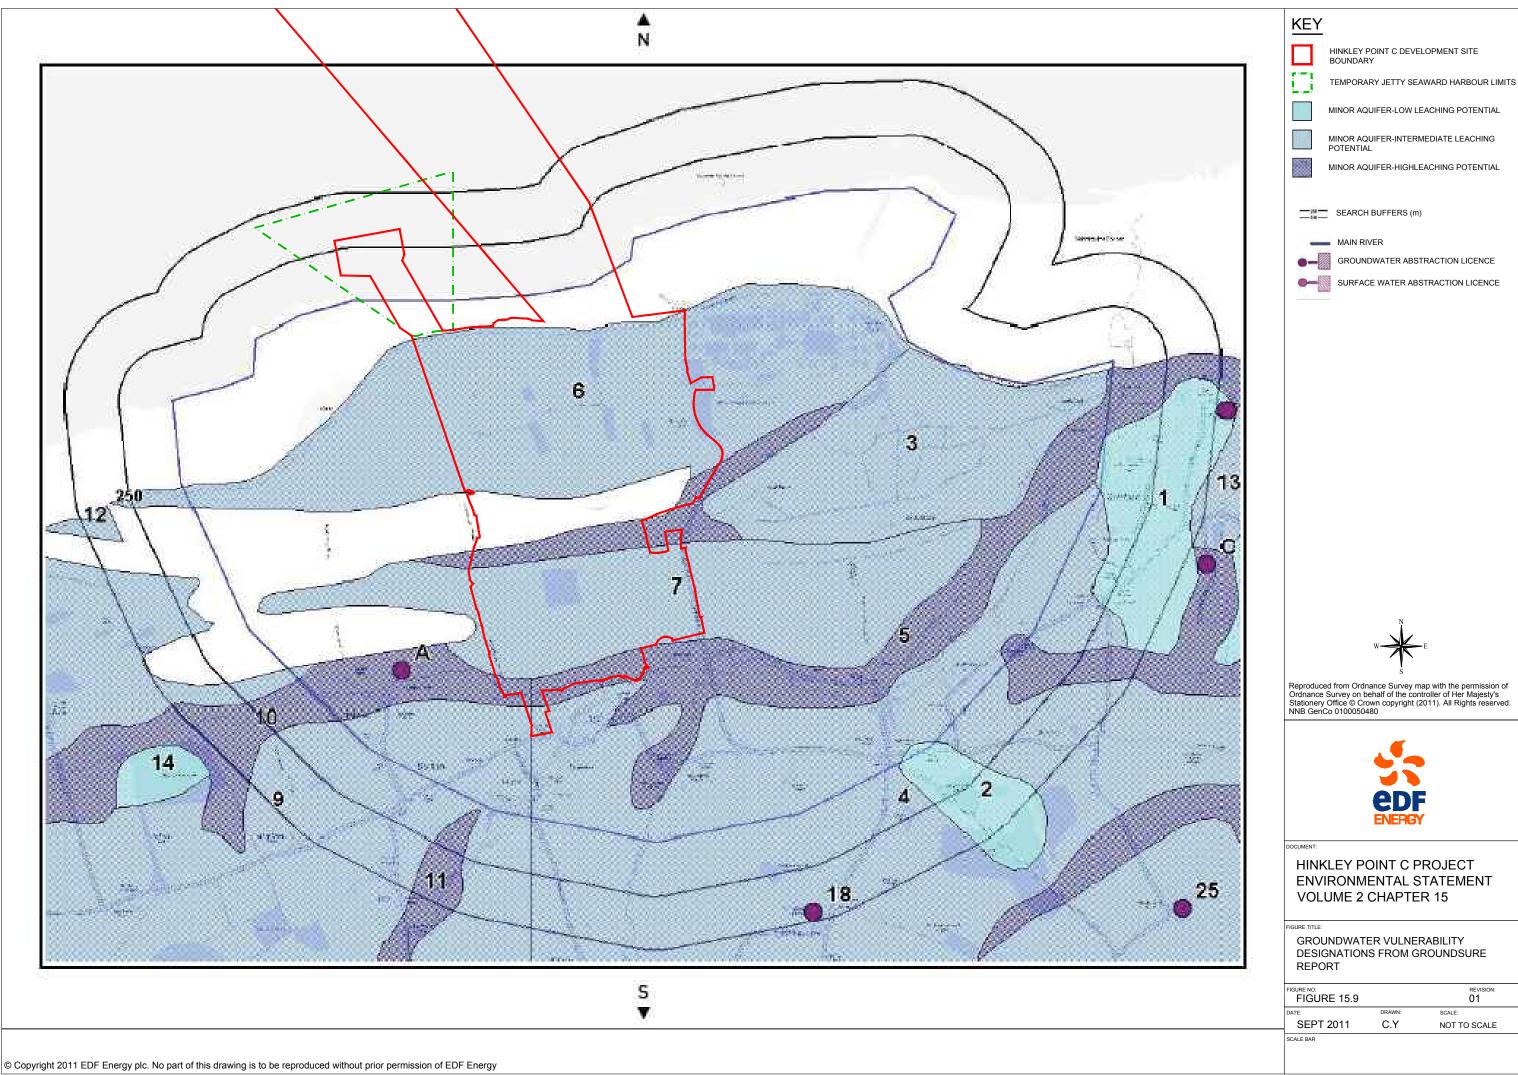


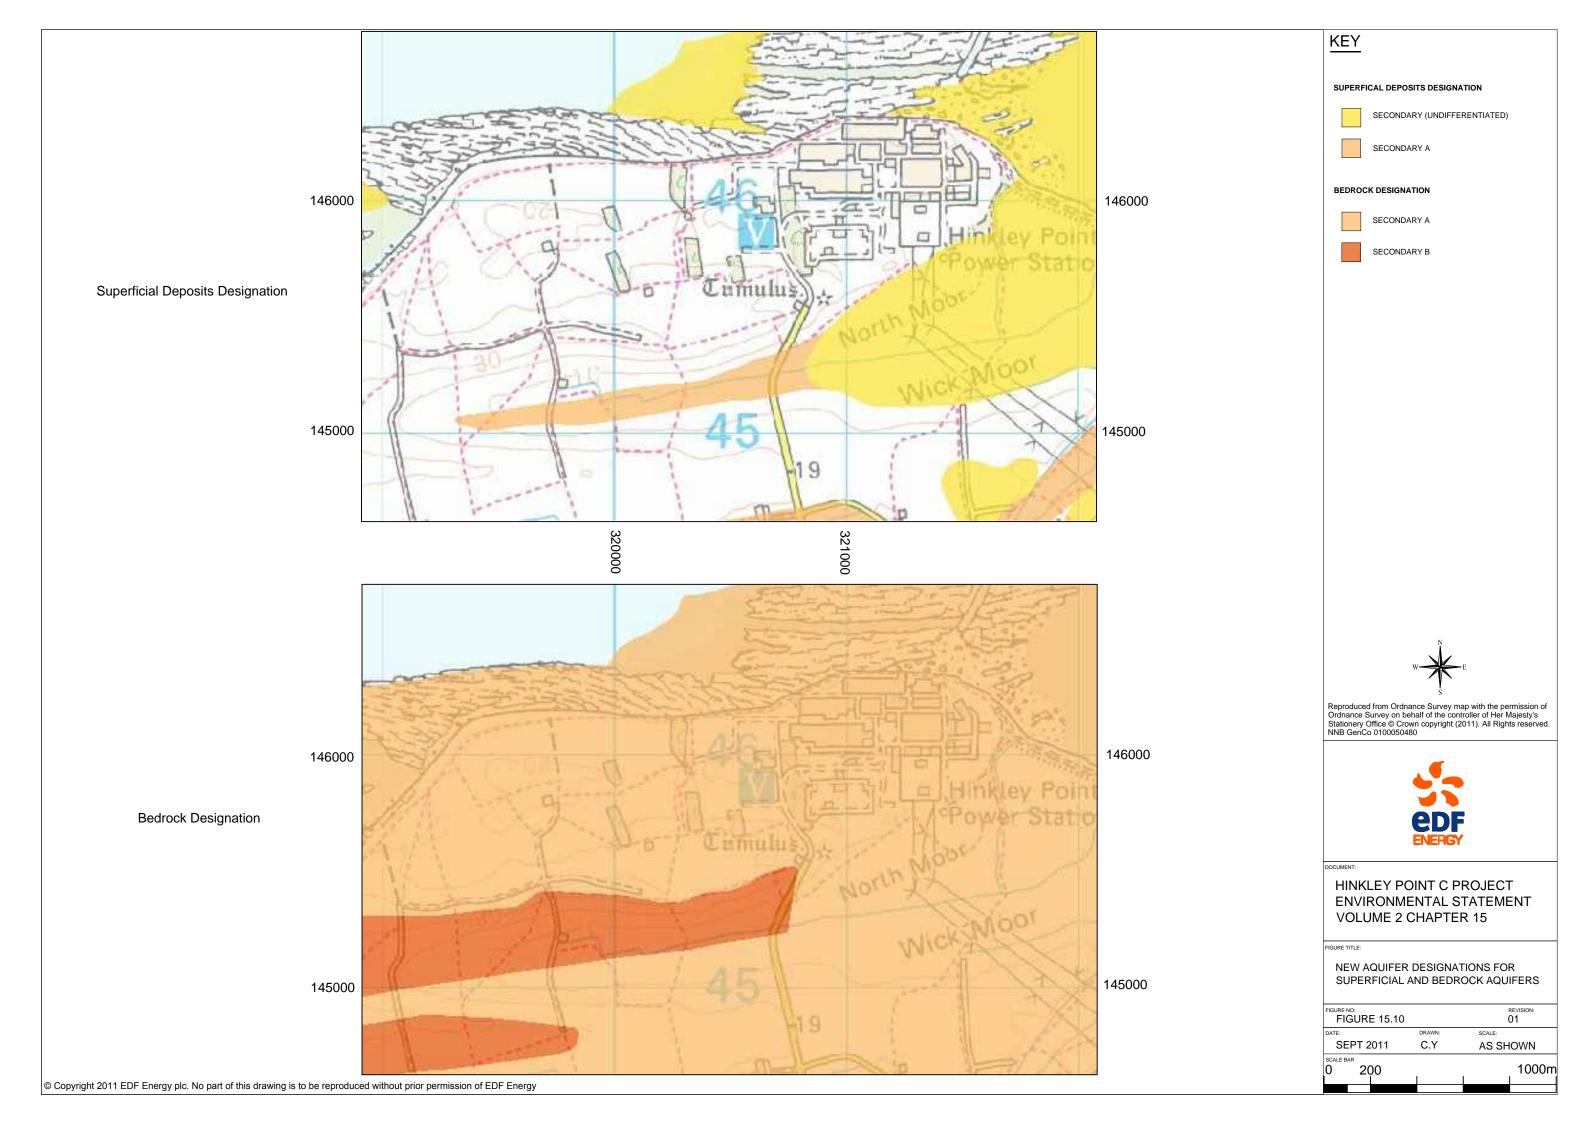


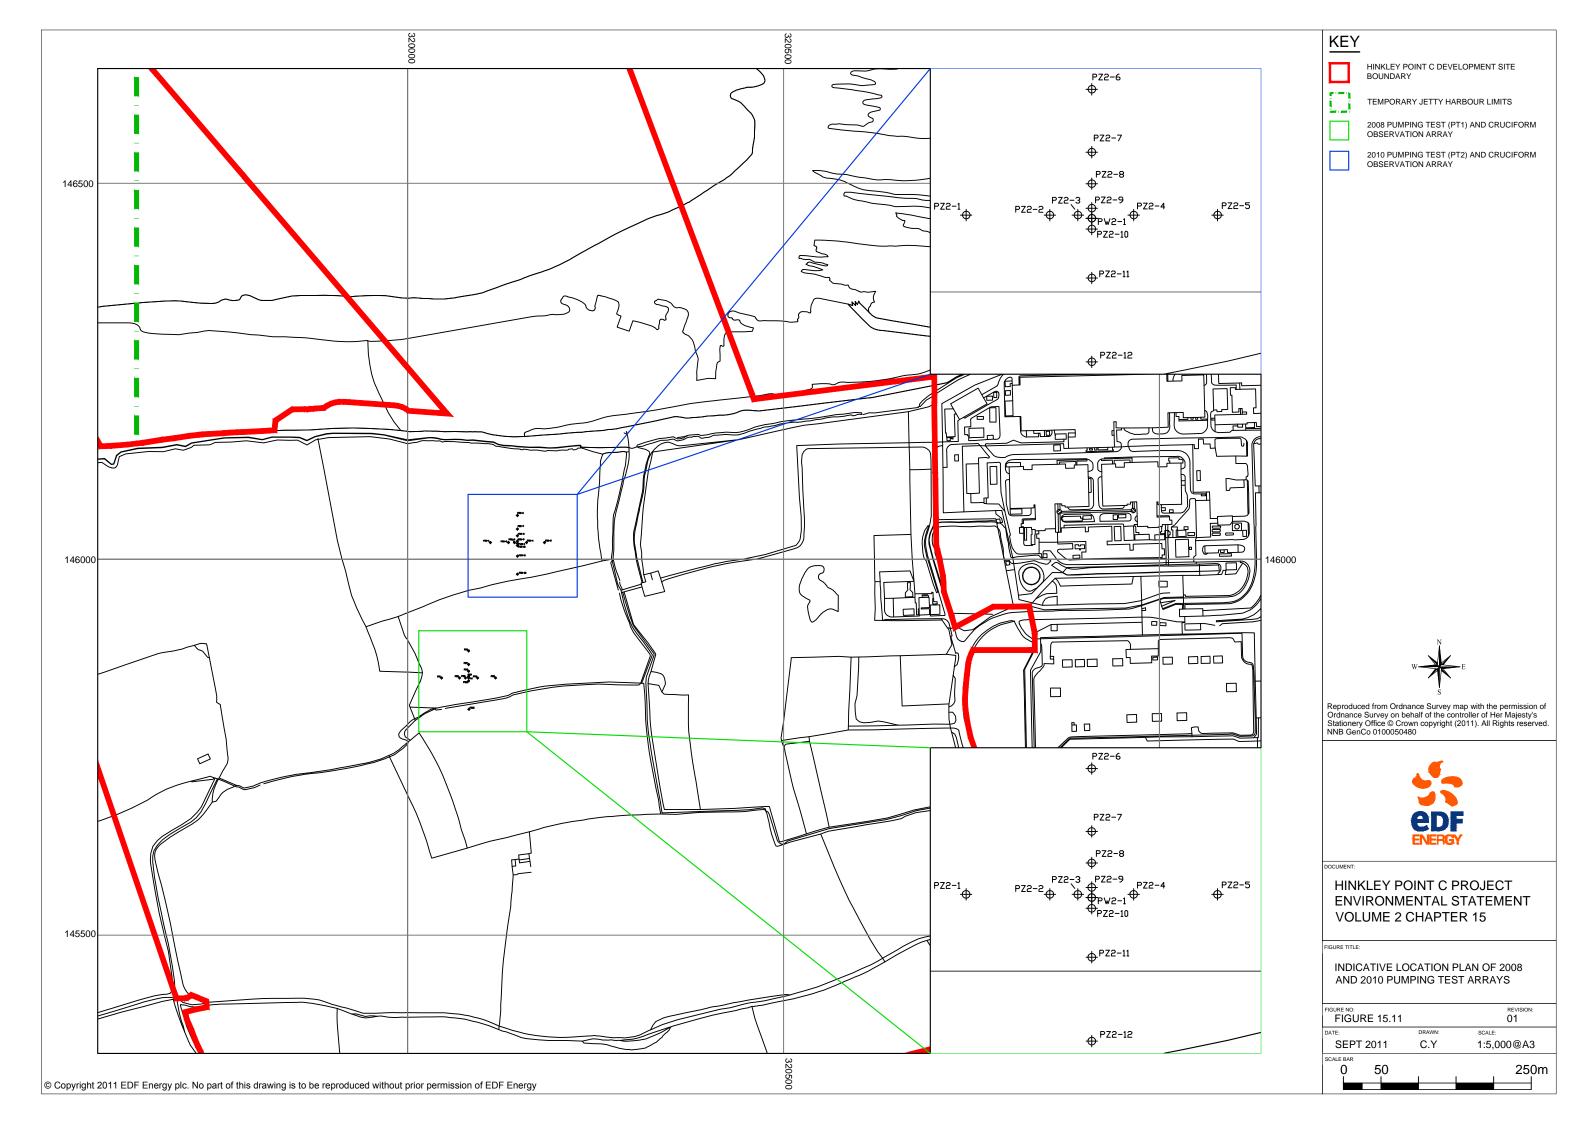


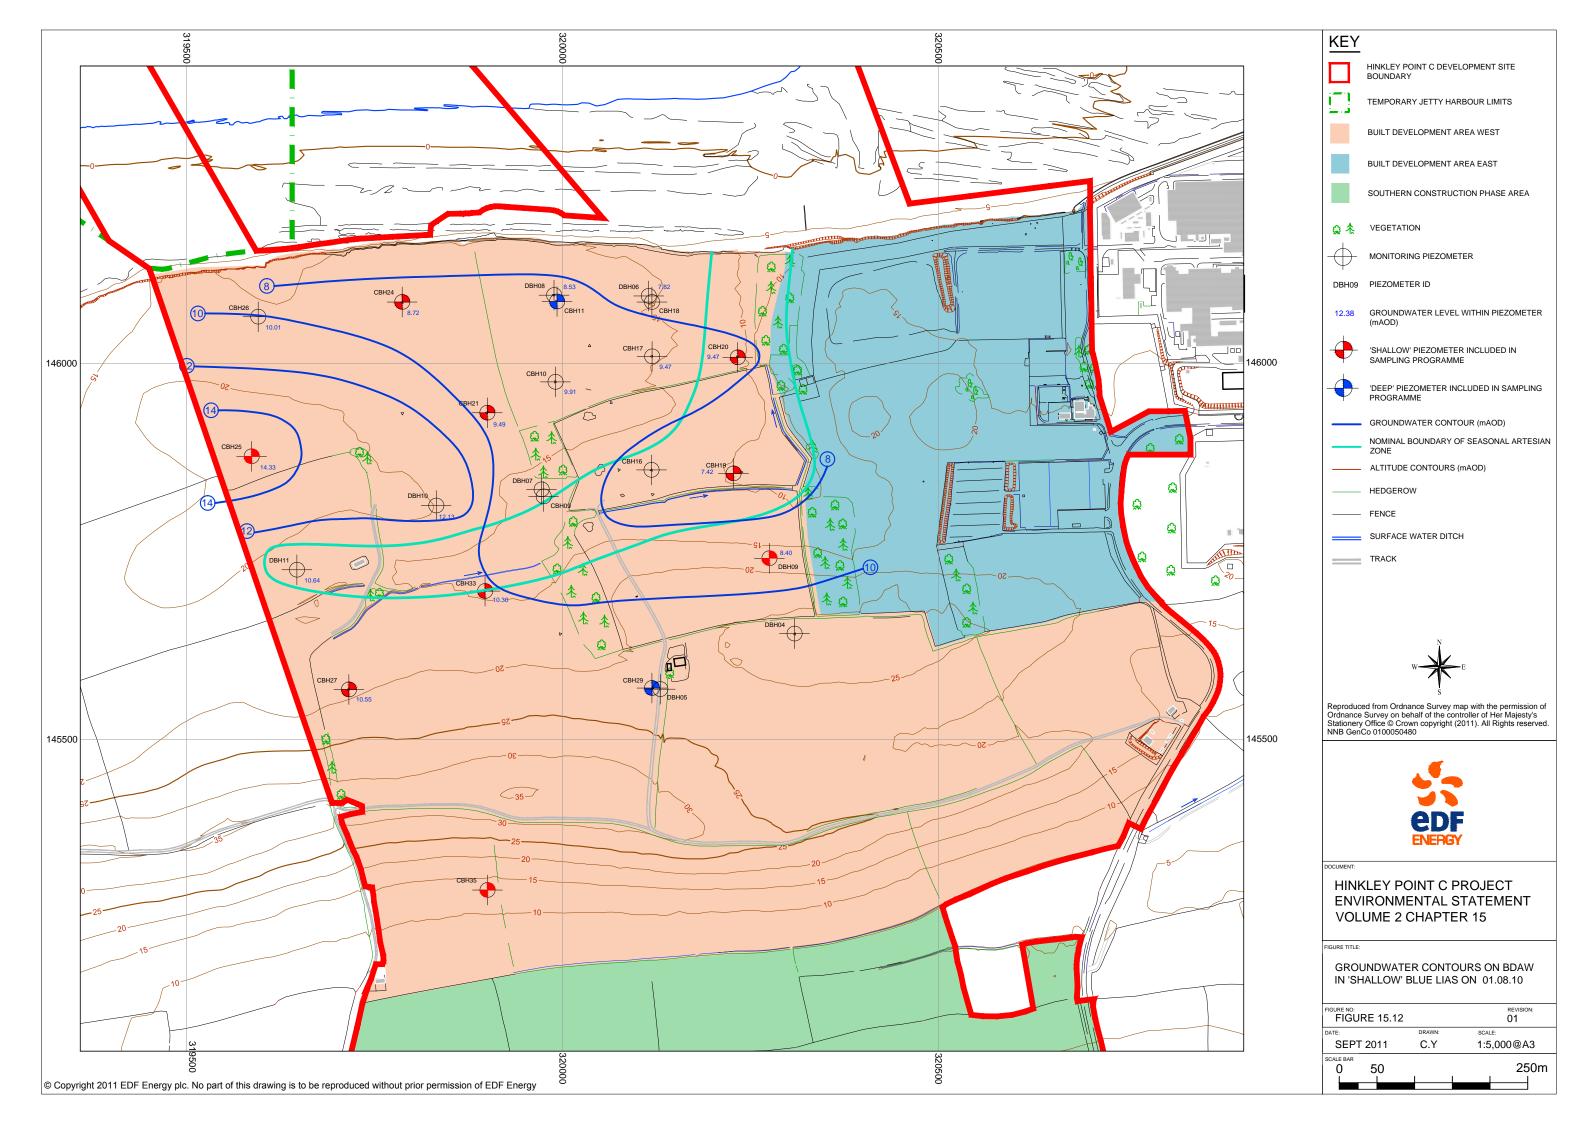


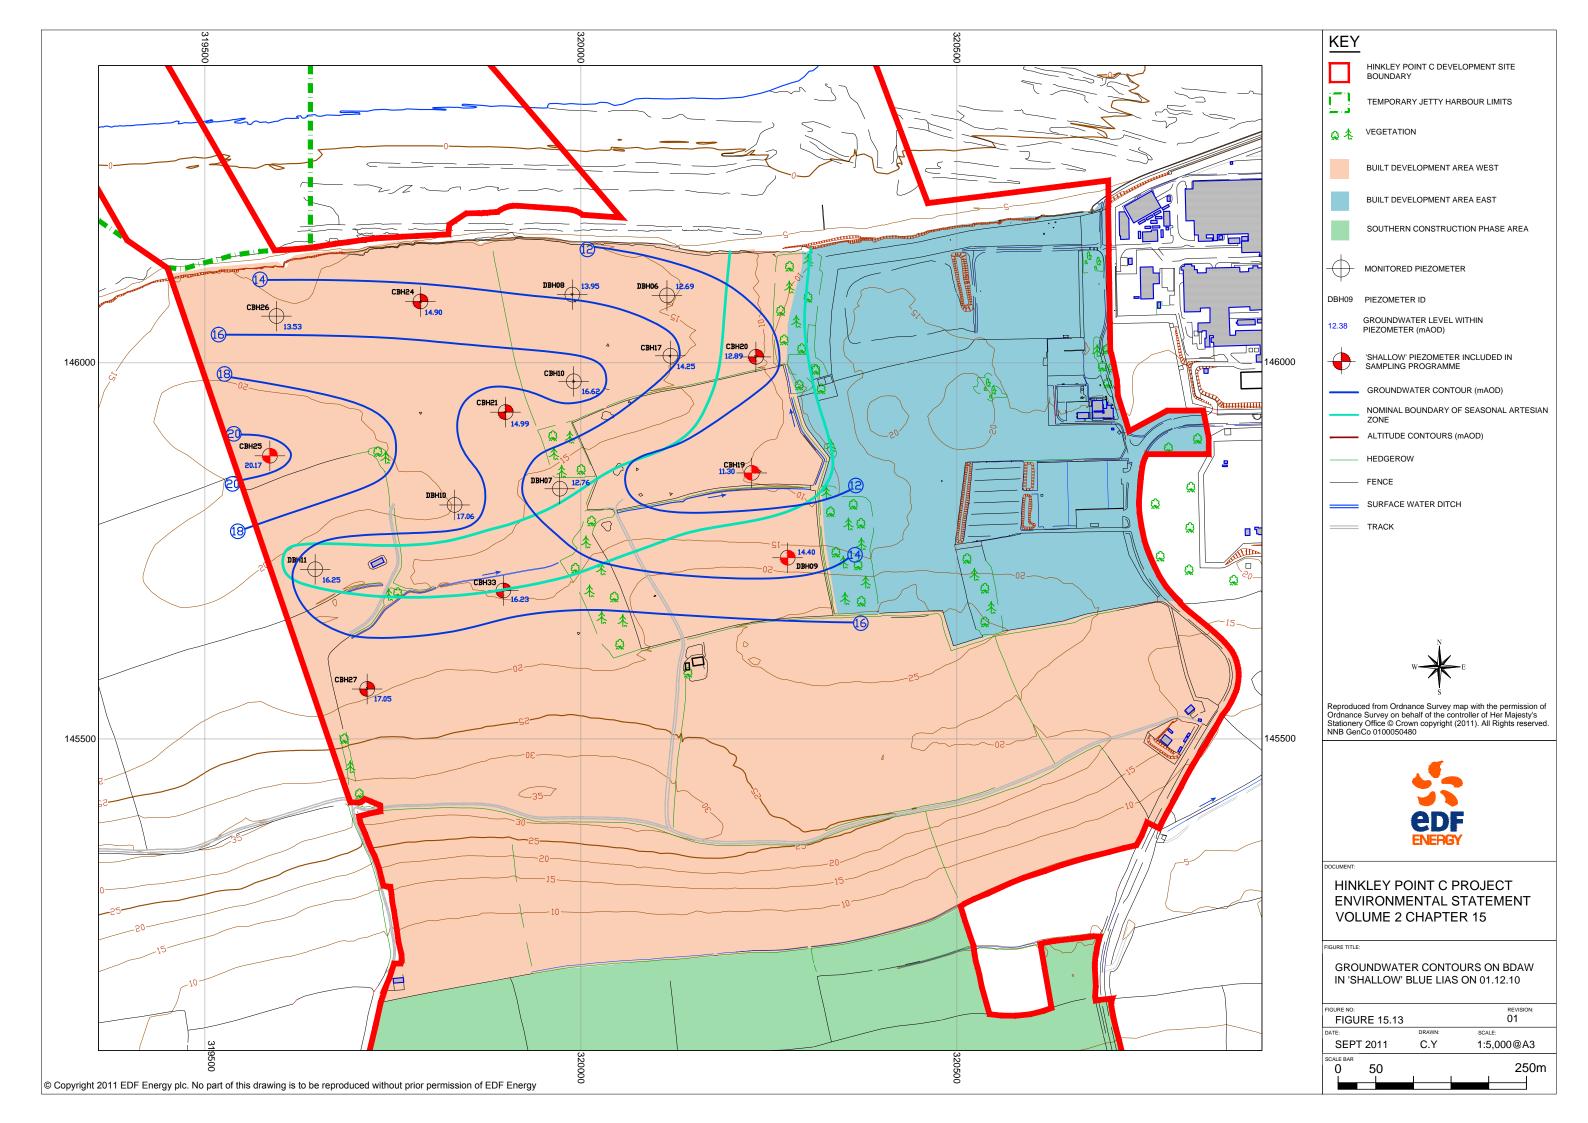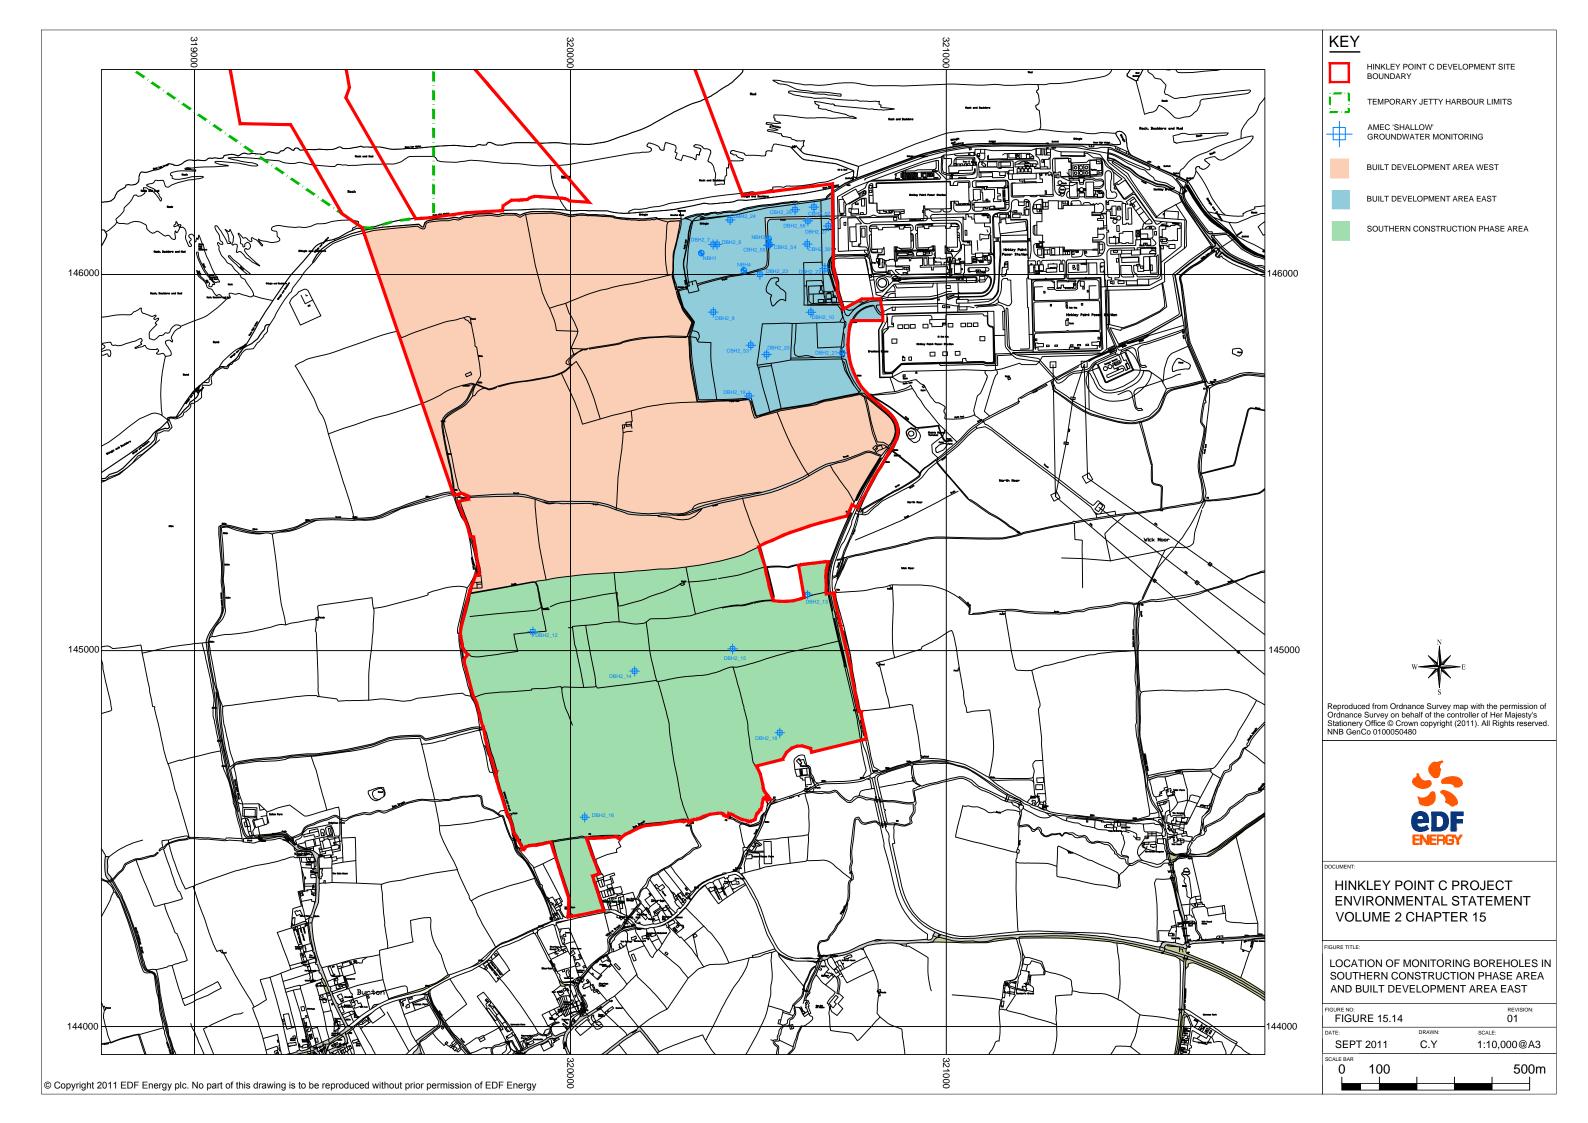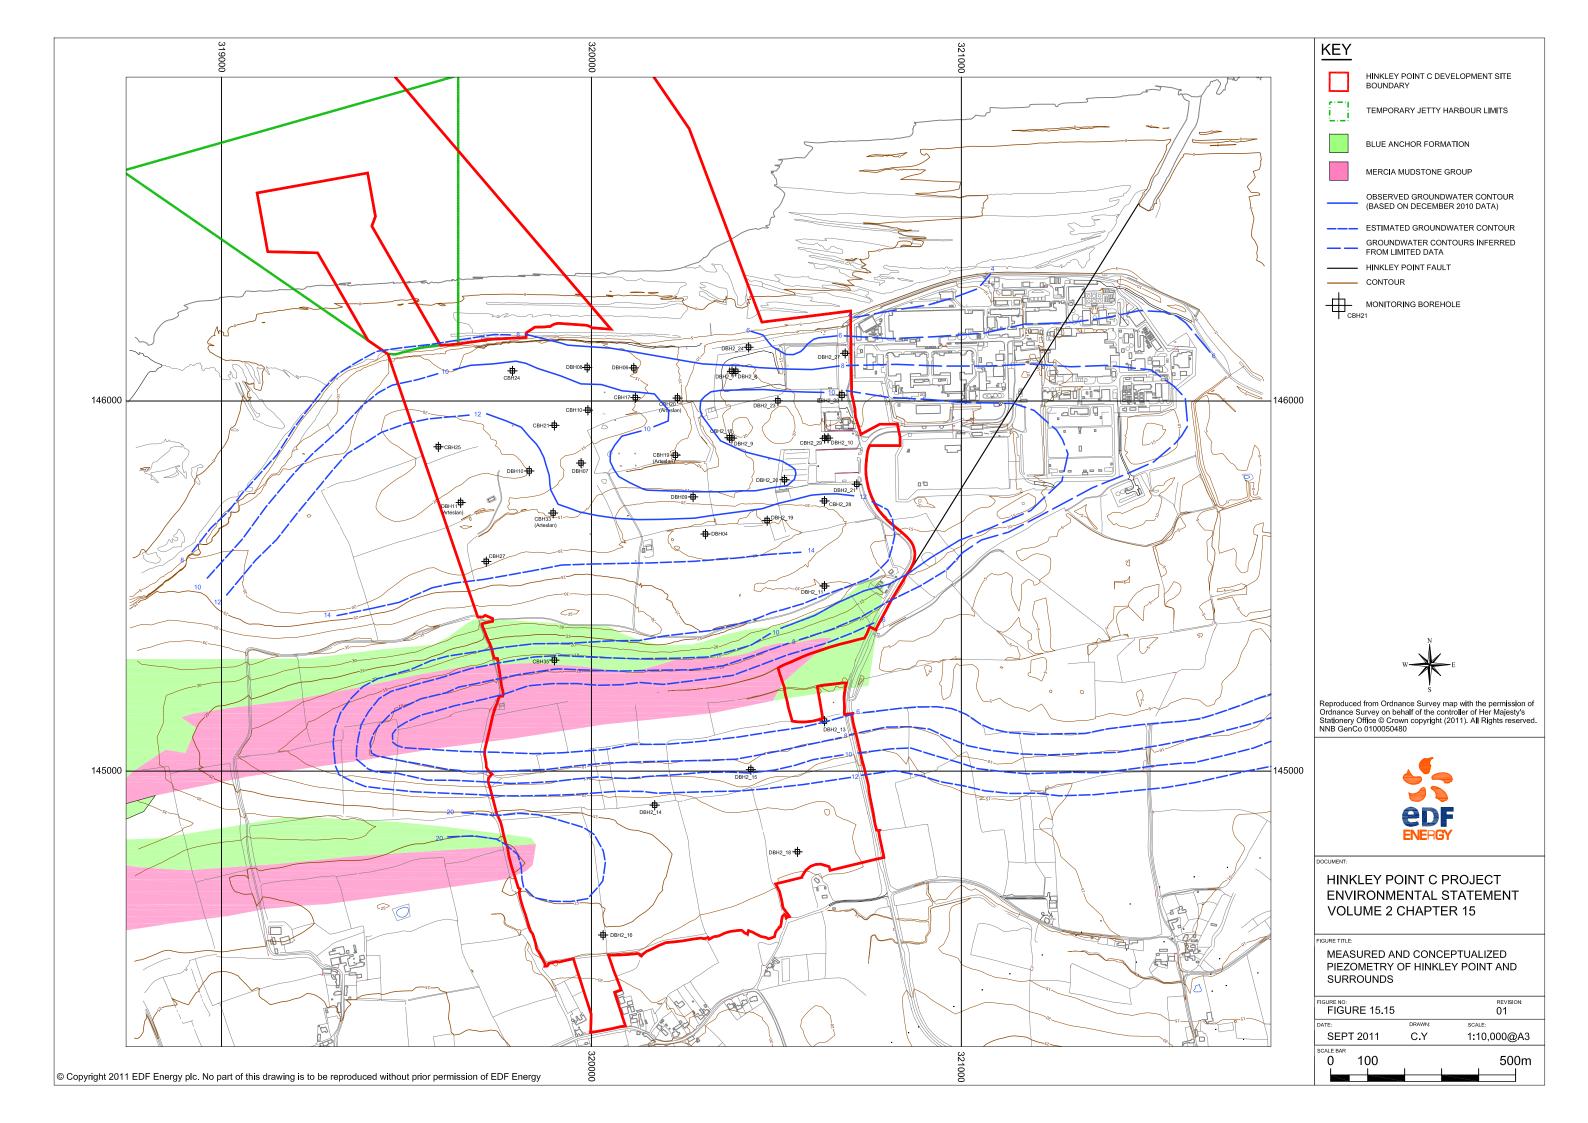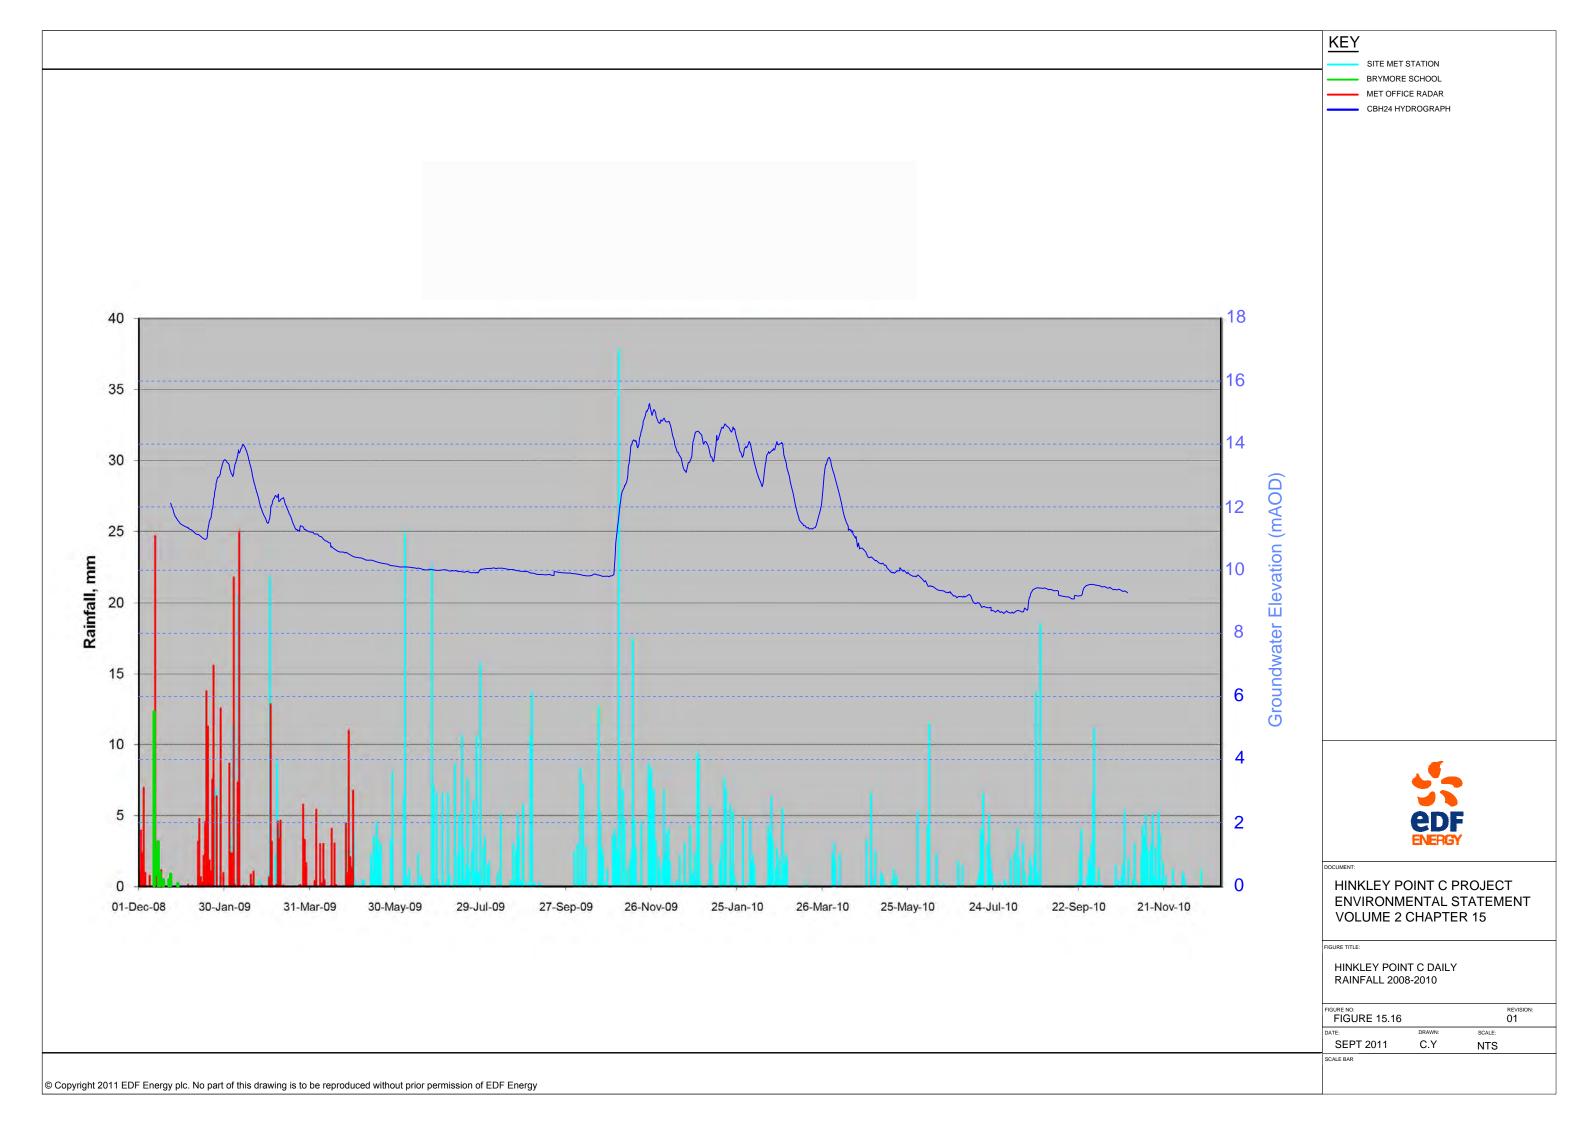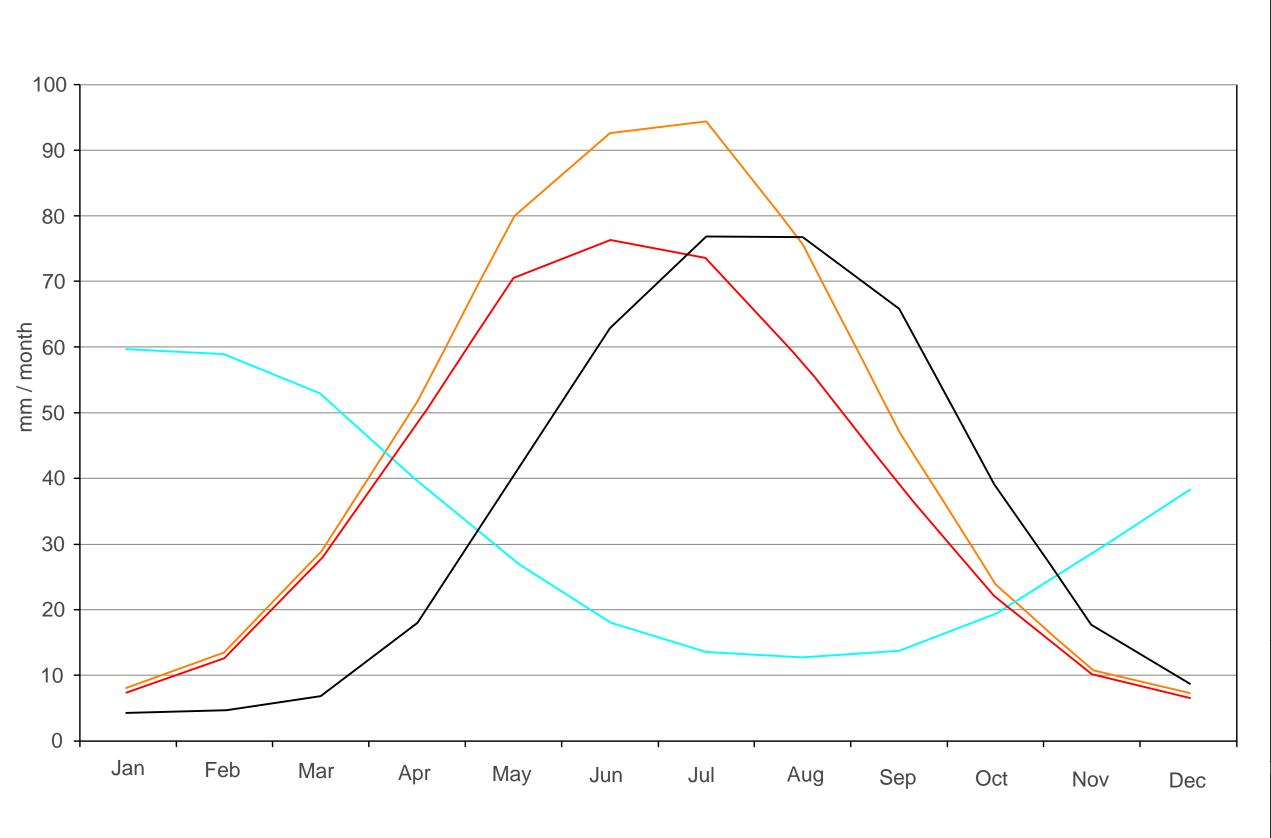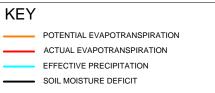














HINKLEY POINT C PROJECT ENVIRONMENTAL STATEMENT VOLUME 2 CHAPTER 15


FIGURE TITLE

HINKLEY POINT C RAINFALL AND EVAPORATION 1962-2011 AVERAGES

FIGURE NO: FIGURE 15.17		REVISION: 01	
DATE:	DRAWN:	SCALE:	
SEPT 2011	C.Y	NTS	
SCALE BAR			



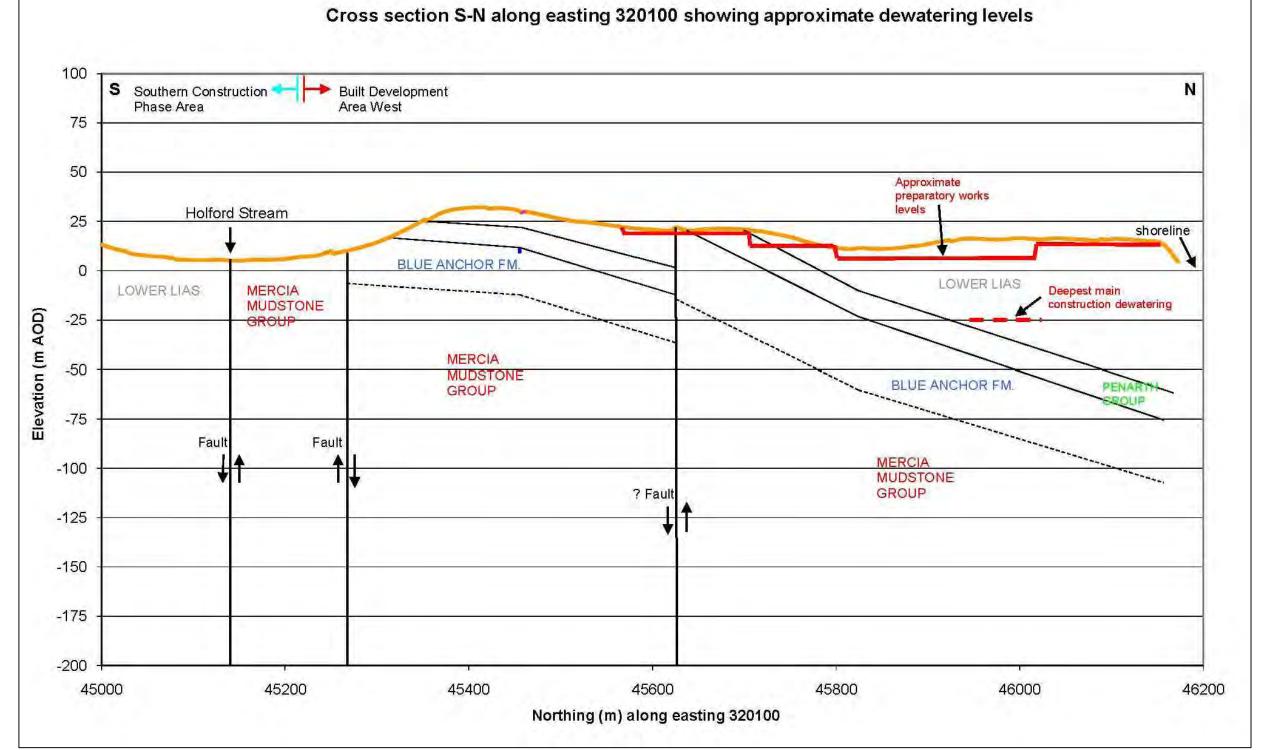SEE KEY DETAIL WITHIN FIGURE





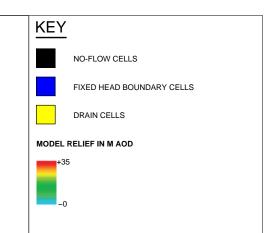
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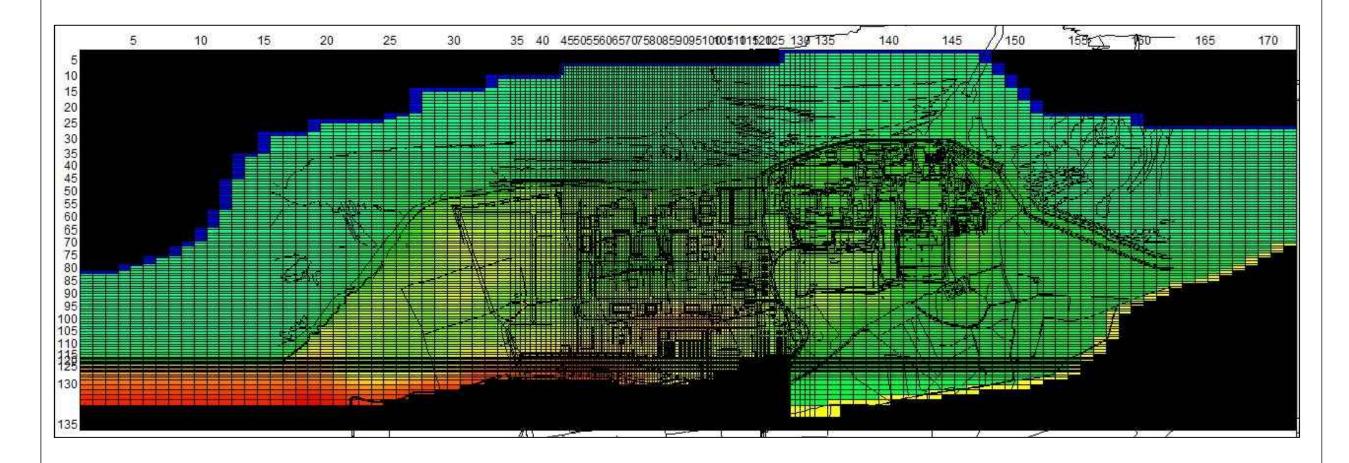
HINKLEY POINT C PROJECT ENVIRONMENTAL STATEMENT VOLUME 2 CHAPTER 15

FIGURE TI

CROSS SECTION S-N ALONG EASTING 320100 SHOWING APPROXIMATE DEWATERING LEVELS

FIGURE 15.18		REVISION: 01	
DATE:	DRAWN:	SCALE:	
SEPT 2011	C.Y	SEE FIGURE	
SCALE BAR			







HINKLEY POINT C PROJECT ENVIRONMENTAL STATEMENT VOLUME 2 CHAPTER 15

IGURE TITLE:

FINITE DIFFERENCE GROUNDWATER MODEL GRID AND SITE OVERLAY

FIGURE NO: FIGURE 15.19		REVISION:
DATE:	DRAWN:	SCALE:
SEPT 2011	C.Y	NTS
SCALE BAR		









HINKLEY POINT C PROJECT ENVIRONMENTAL STATEMENT VOLUME 2 CHAPTER 15

FIGURE TITLE:

BASE OF MODEL LAYER 1

FIGURE NO: FIGURE 15.20		REVISION: 01
DATE:	DRAWN:	SCALE:
SEPT 2011	C.Y	NTS
SCALE BAR		

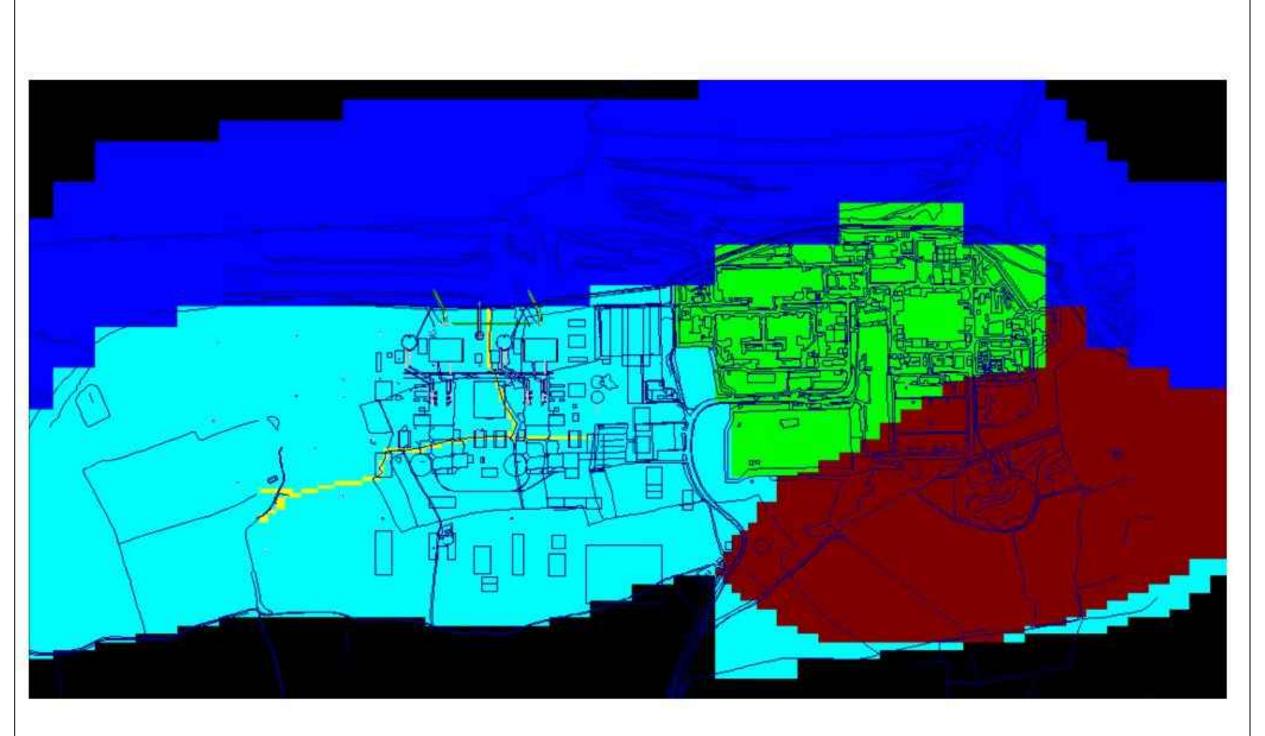

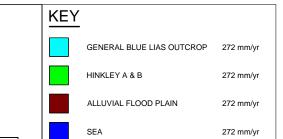

272 mm/yr

DRAIN CELLS



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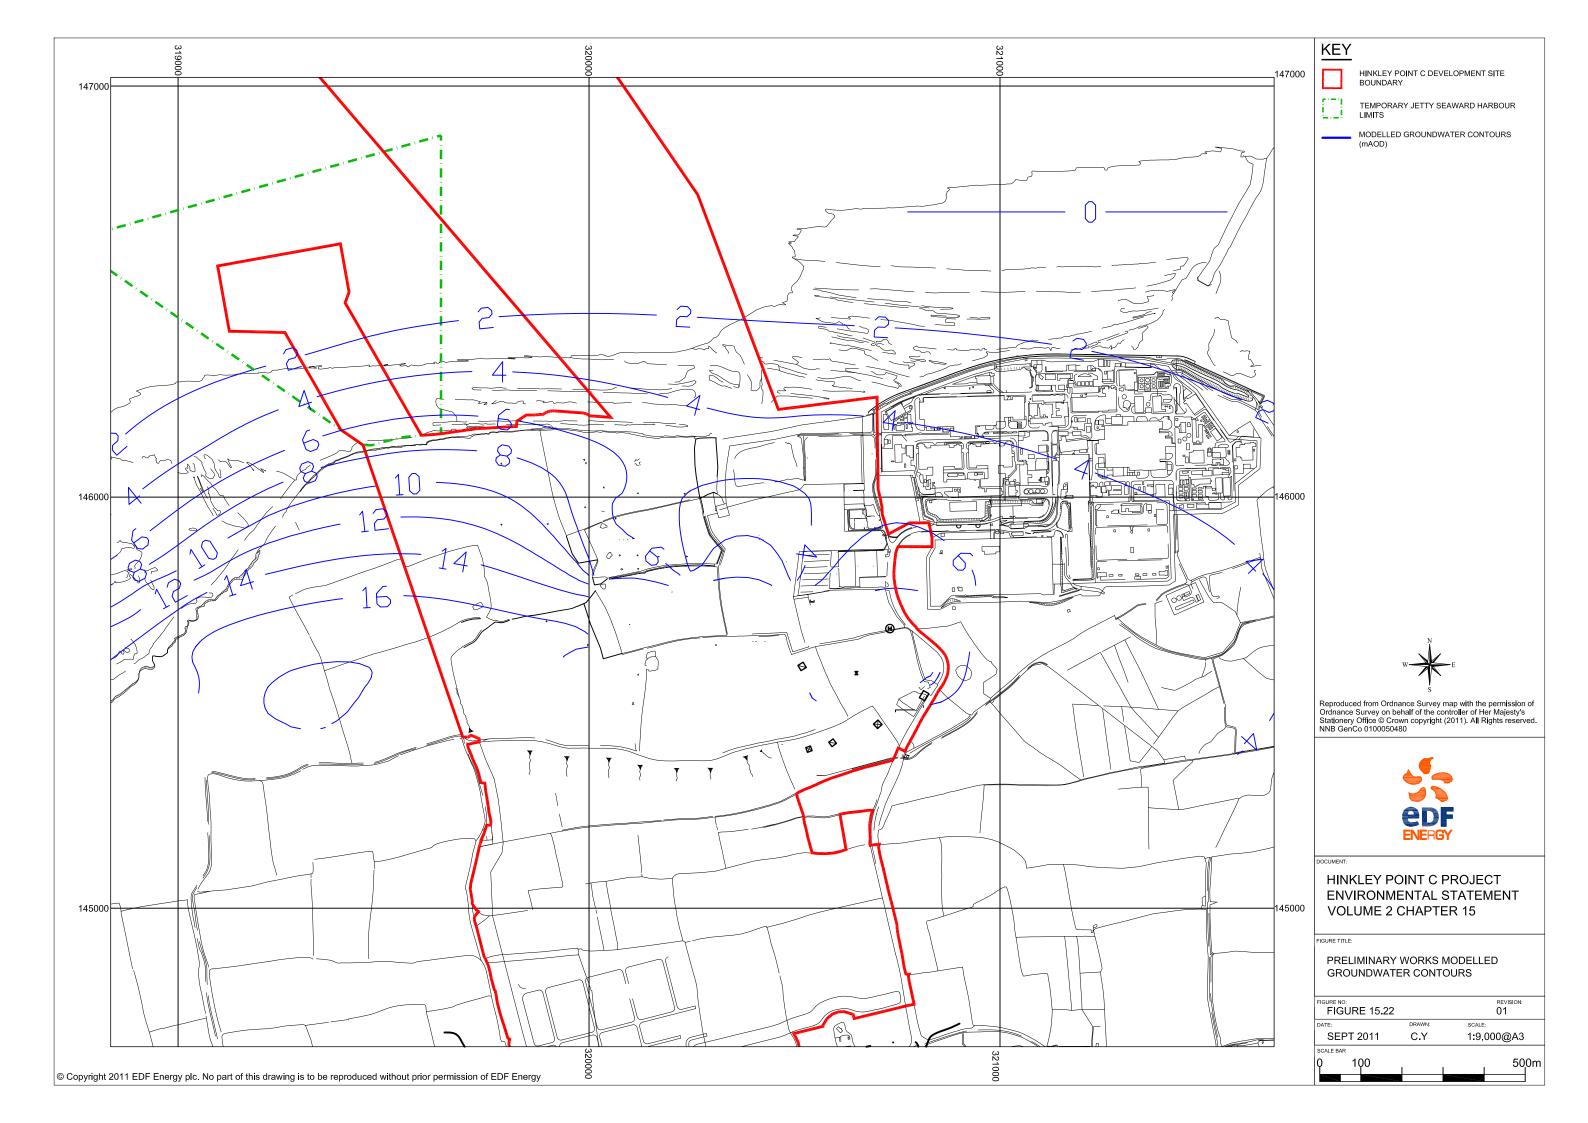
DOCUM

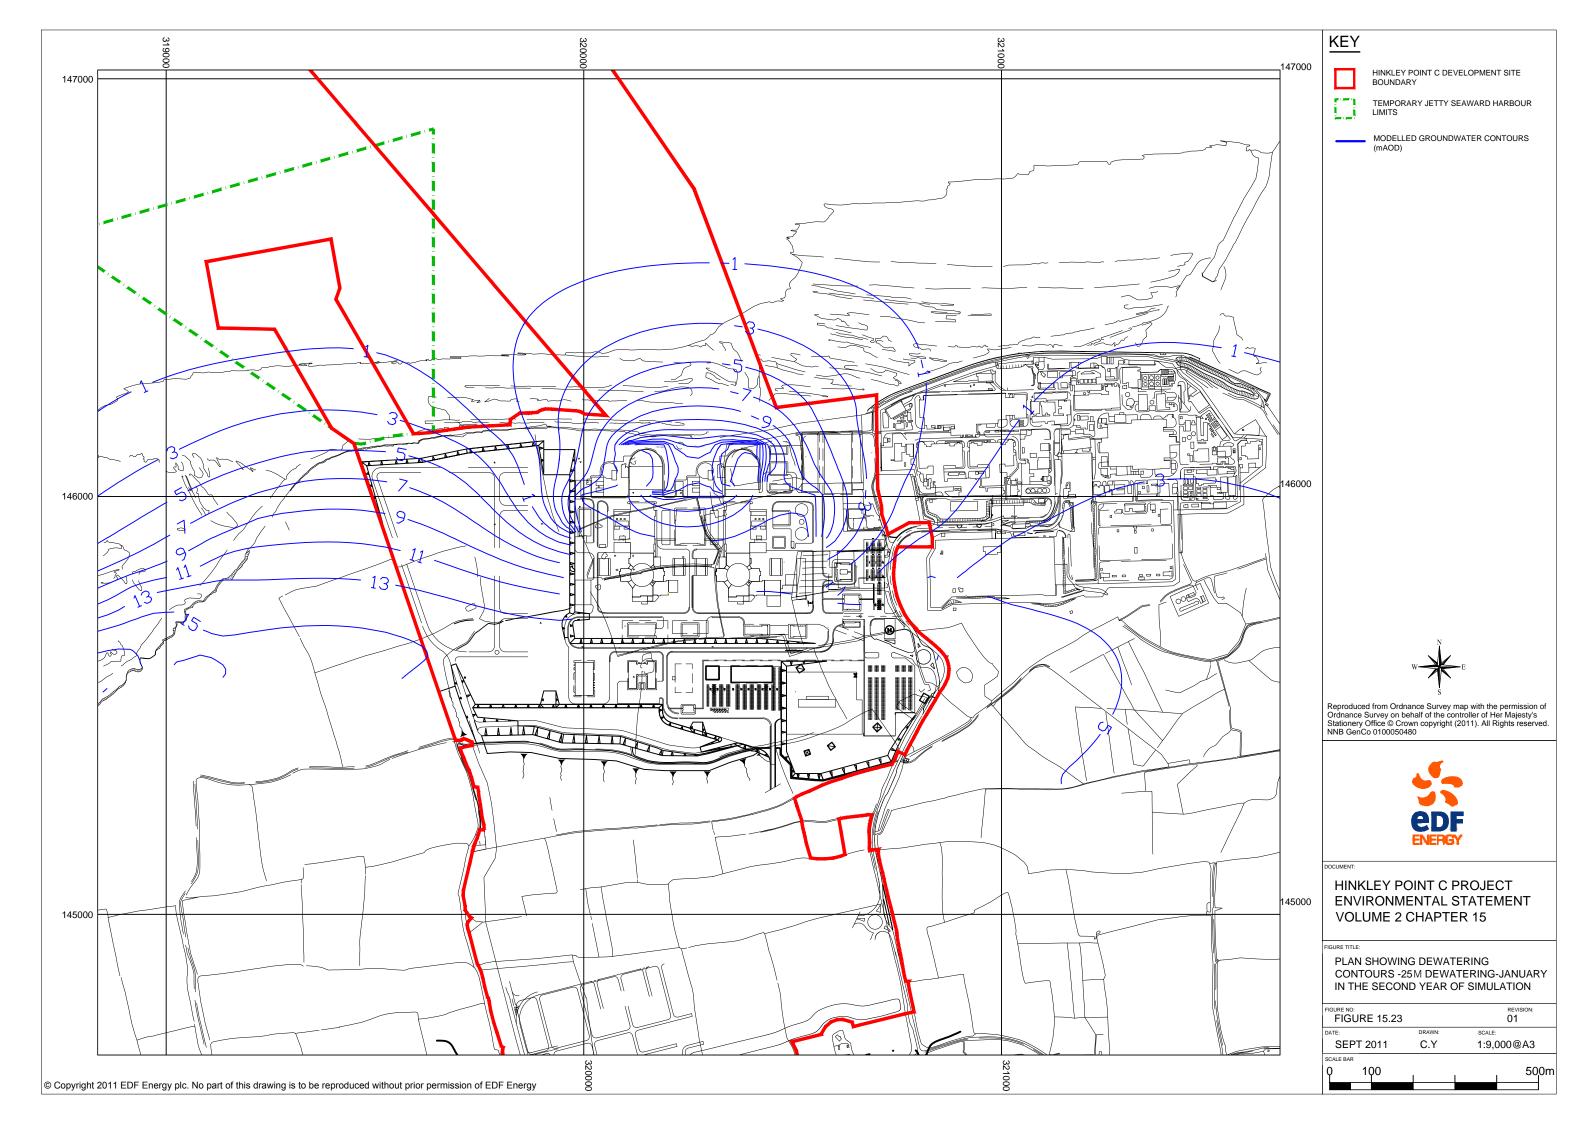
HINKLEY POINT C PROJECT ENVIRONMENTAL STATEMENT VOLUME 2 CHAPTER 15


FIGURE TITLE

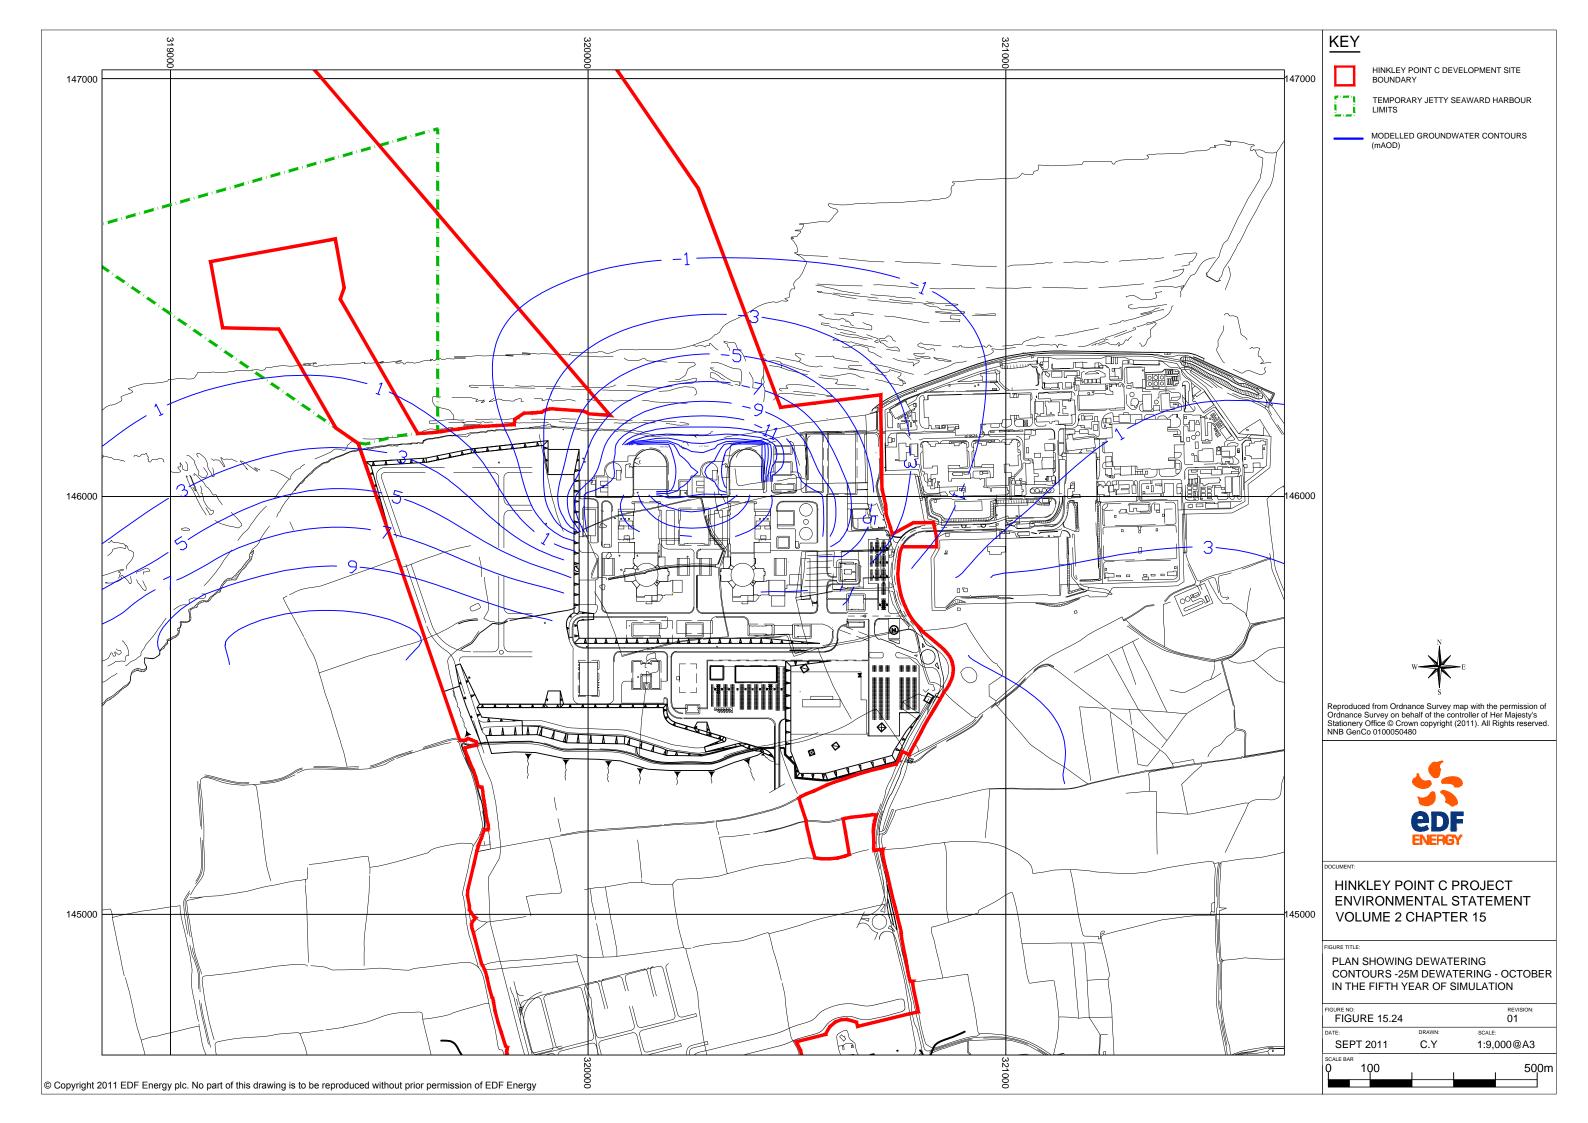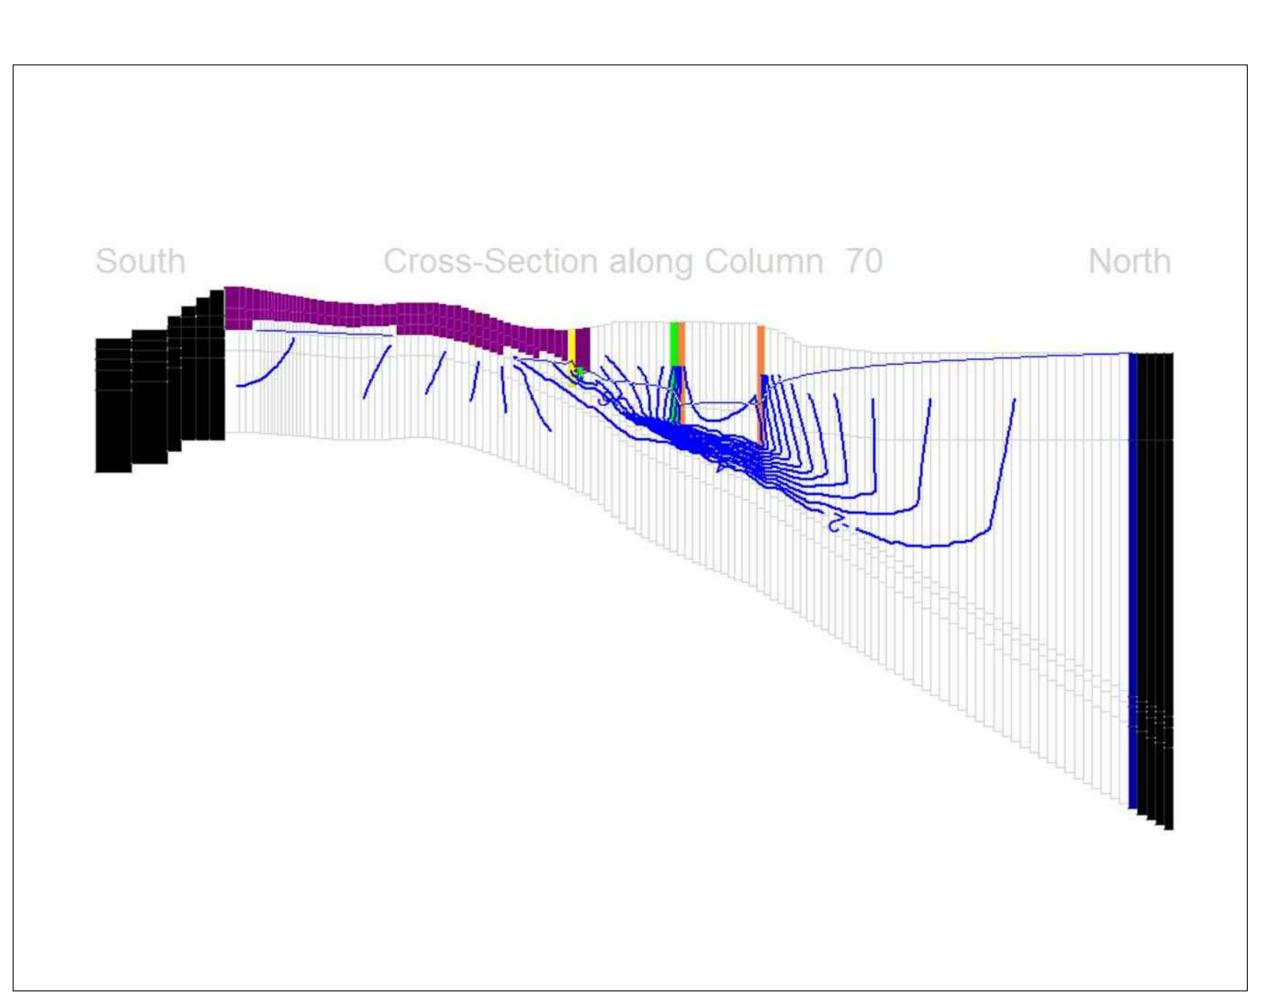
SPATIAL DISTRIBUTION OF MODEL RECHARGE ZONES

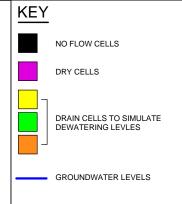
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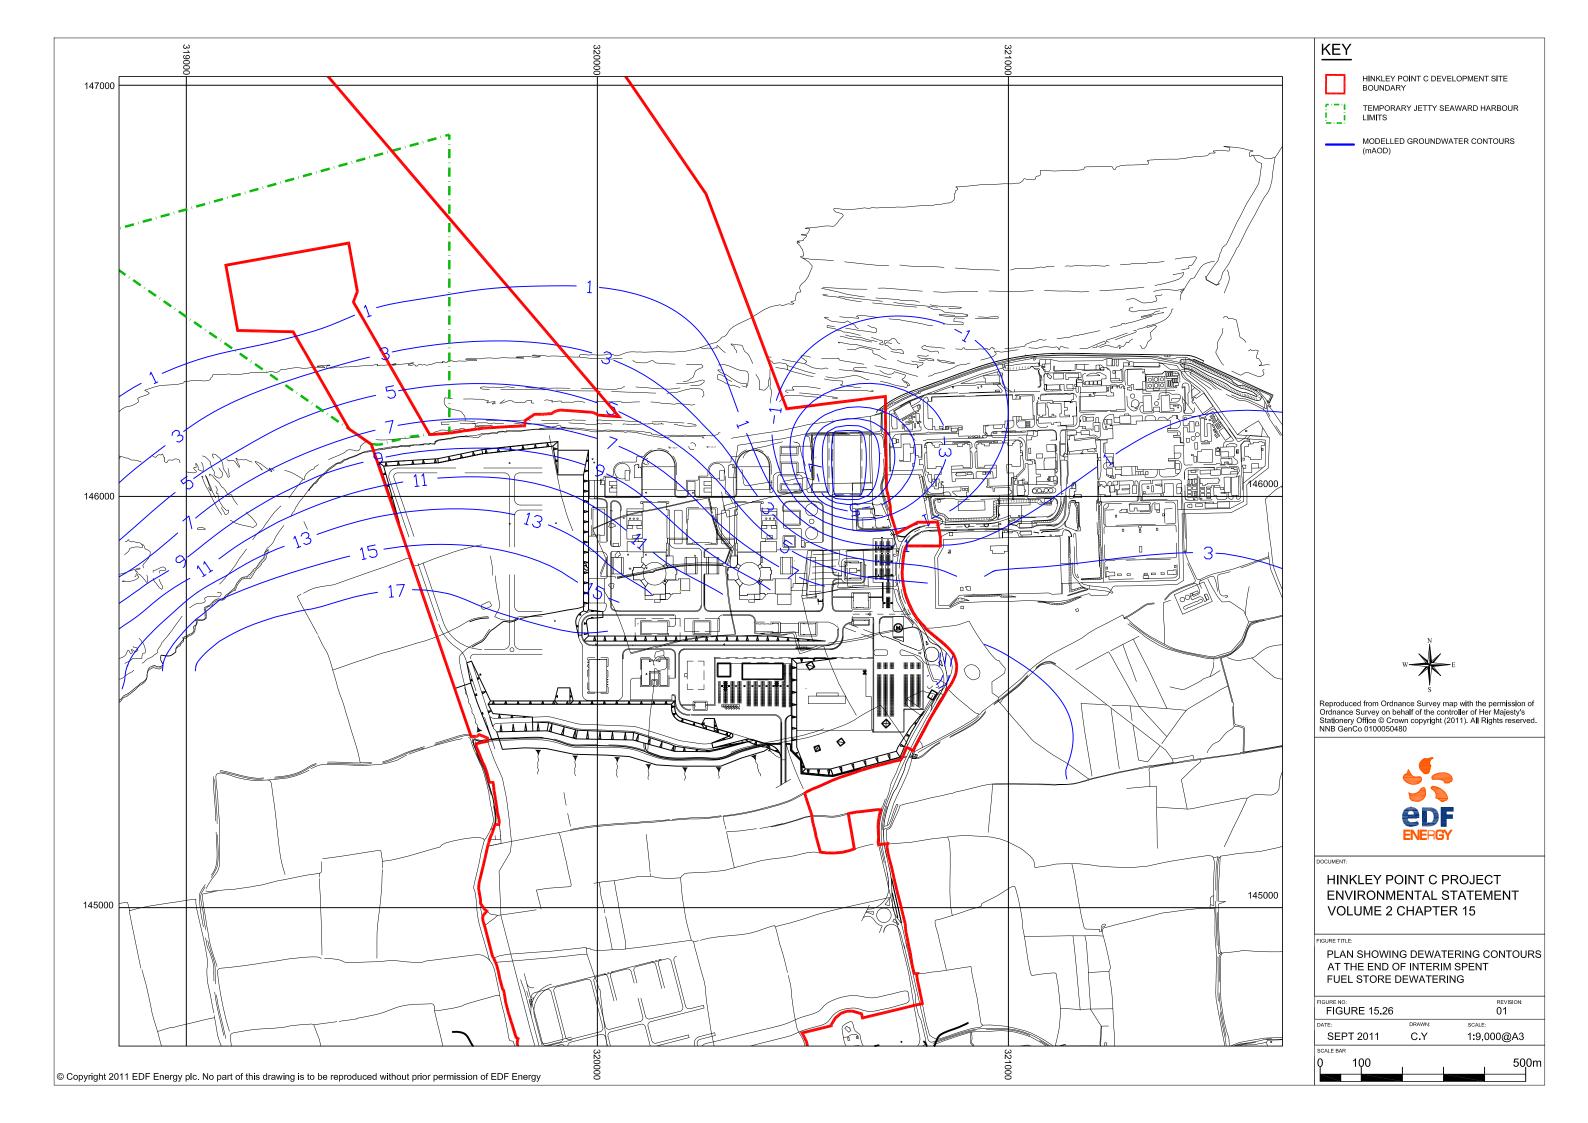






HINKLEY POINT C PROJECT **ENVIRONMENTAL STATEMENT VOLUME 2 CHAPTER 15**


FIGURE TITLE:
CROSS SECTION THROUGH MODFLOW
DEWATERING MODEL AT COLUMN
70-OCTOBER IN THE 5TH YEAR OF
SIMULATION

FIGURE 15.25		REVISION: 01	
DATE:	DRAWN:	SCALE:	
SEPT 2011	C.Y	1:9,000@A3	
SCALE BAR			



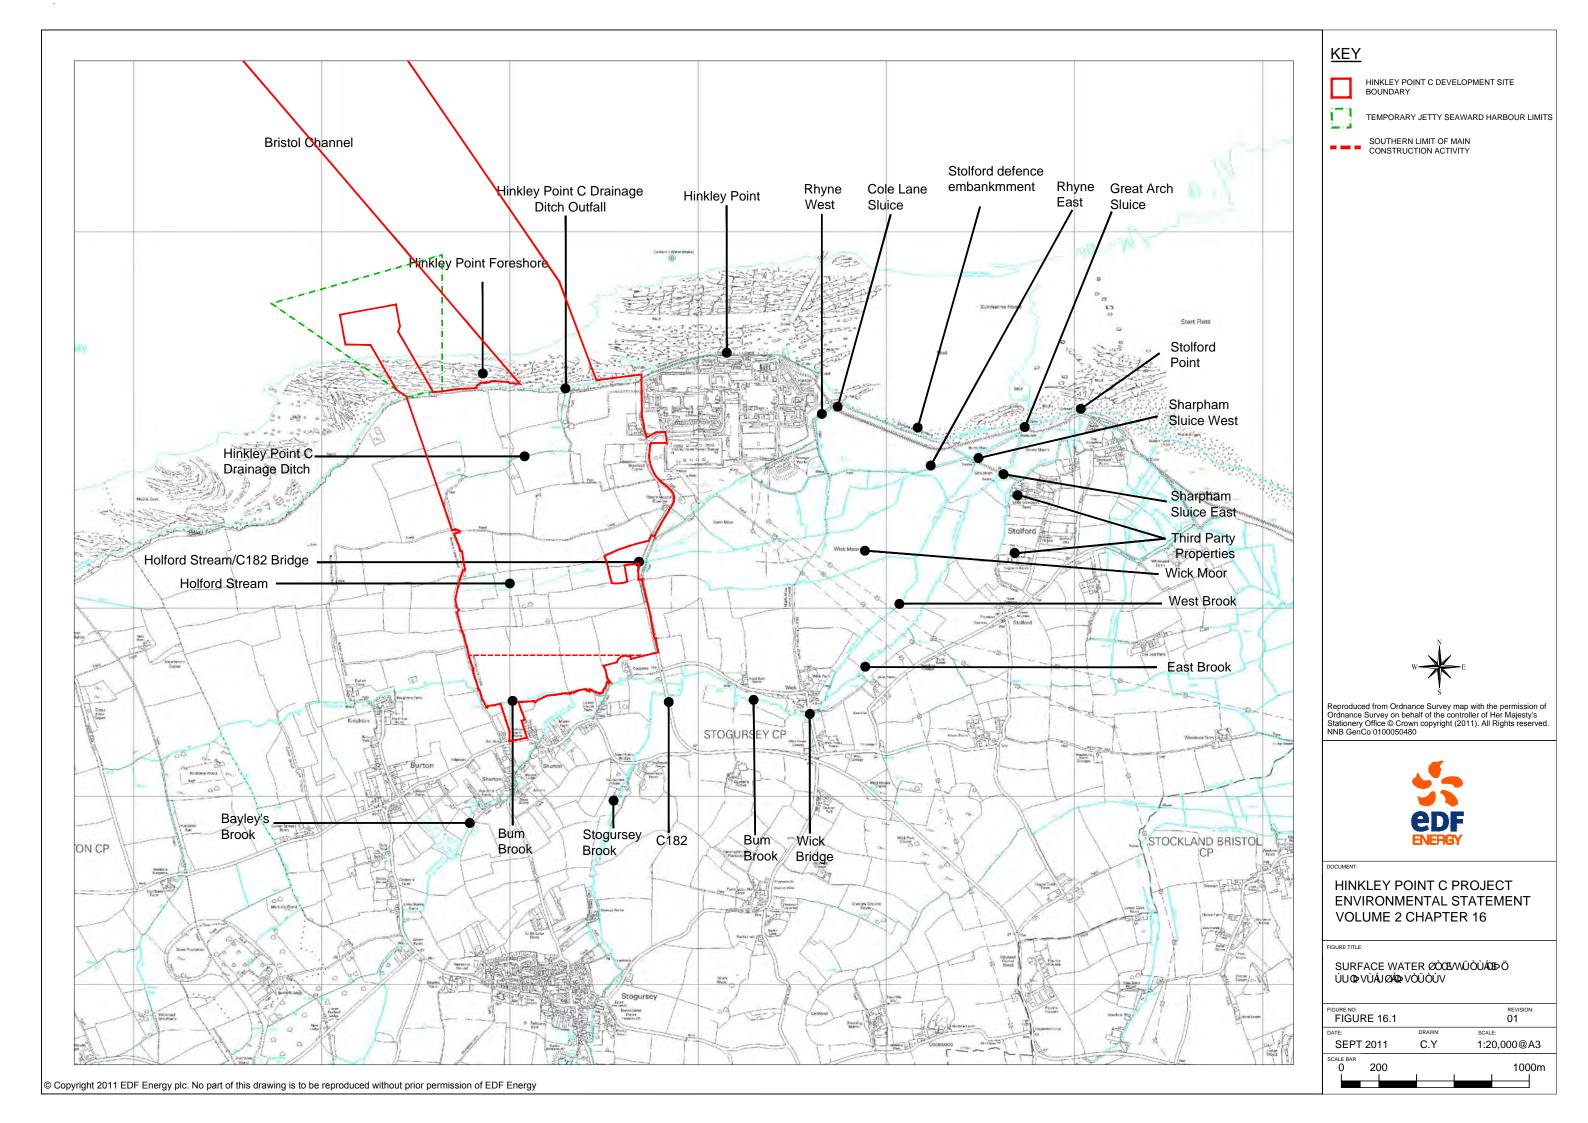

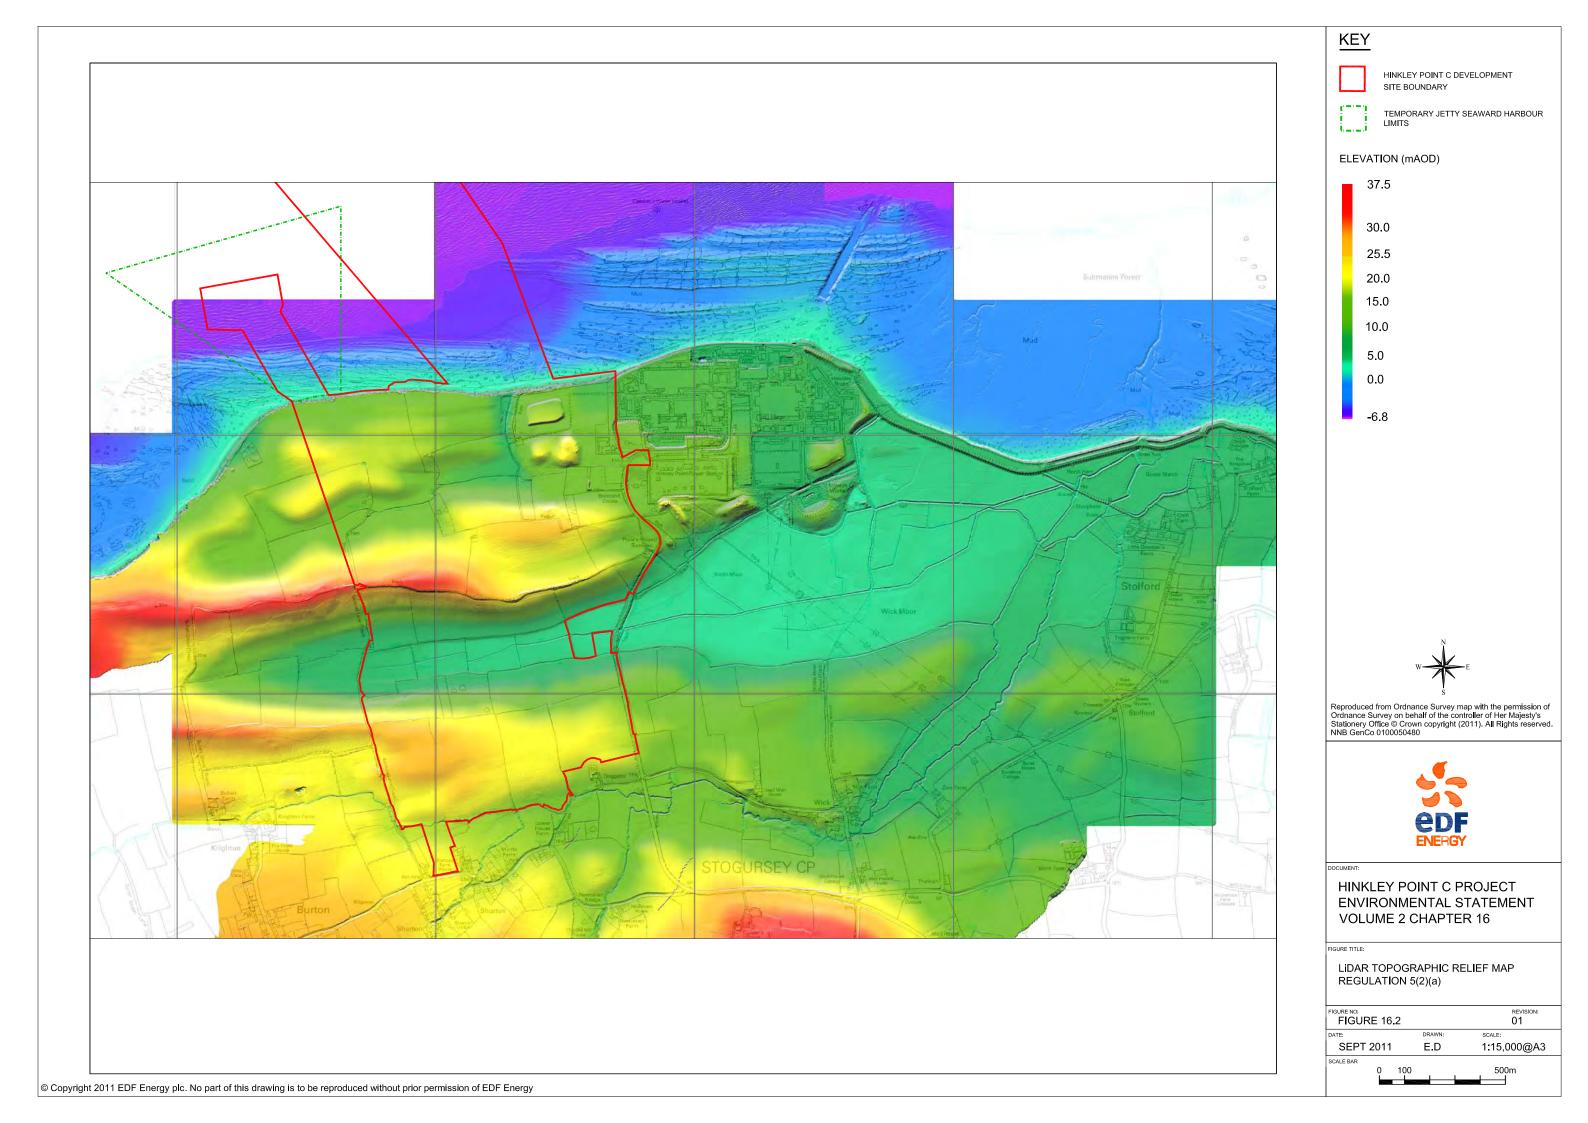

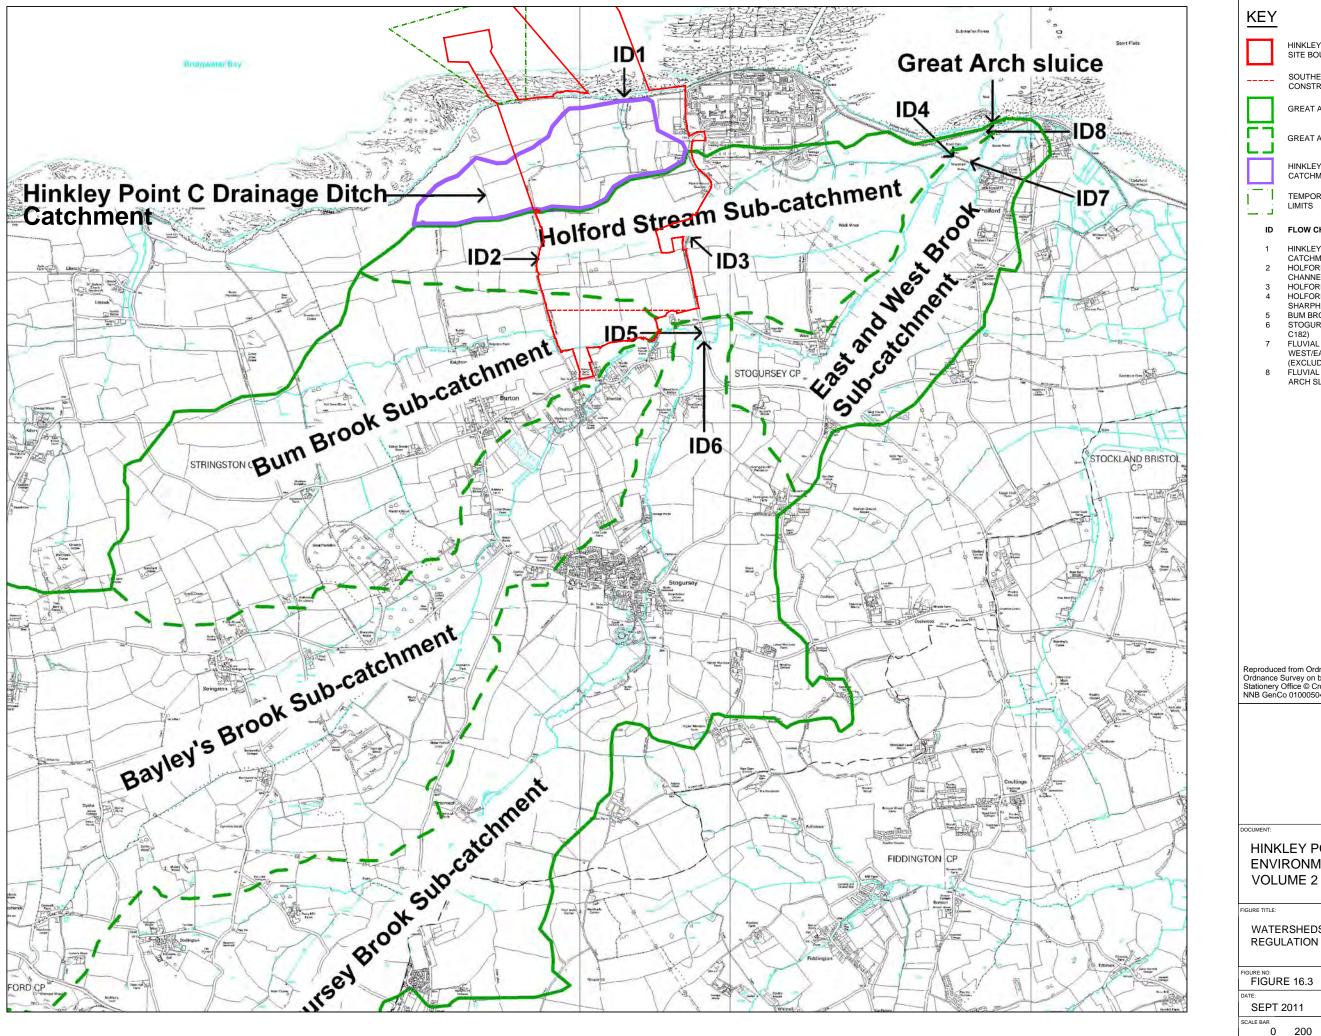

HINKLEY POINT C DEVELOPMENT SITE BOUNDARY SOUTHERN EXTENT OF MAIN GREAT ARCH SLUICE CATCHMENT GREAT ARCH SLUICE SUB-CATCHMENT HINKLEY POINT C DRAINAGE DITCH TEMPORARY JETTY SEAWARD HARBOUR FLOW CHARACTERISTIC LOCATION HINKLEY POINT C DRAINAGE DITCH CATCHMENT HOLFORD STREAM (WEST OF START OF CHANNEL)
HOLFORD STREAM (UPSTREAM OF THE C182) HOLFORD STREAM (UPSTREAM OF SHARPHAM SLUICE)
BUM BROOK (UPSTREAM OF THE C182)
STOGURSEY BROOK (UPSTREAM OF THE FLUVIAL NETWORK UPSTREAM OF WEST/EAST BROOK CONFLUENCE (EXCLUDING HOLFORD STREAM)
FLUVIAL NETWORK UPSTREAM OF GREAT ARCH SLUICE

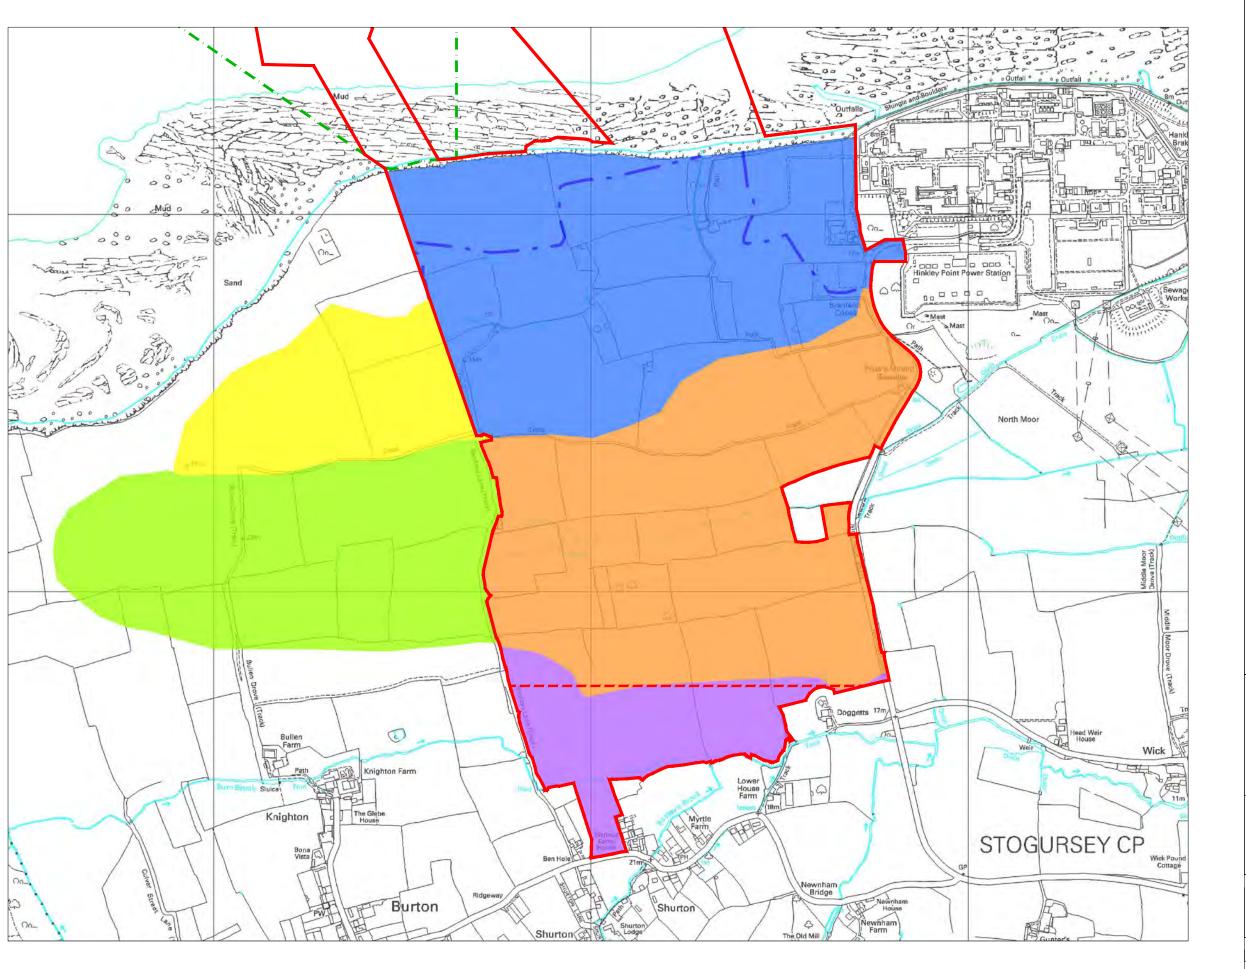
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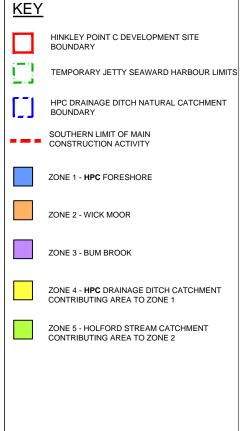


HINKLEY POINT C PROJECT **ENVIRONMENTAL STATEMENT VOLUME 2 CHAPTER 16**

WATERSHEDS & SUB-CATCHMENTS REGULATION 5(2)(a)

FIGURE 16.3		REVISION: 01
:	DRAWN:	SCALE:
SEPT 2011	E.D	1:25,000@A3
0 200	1 [1,000m







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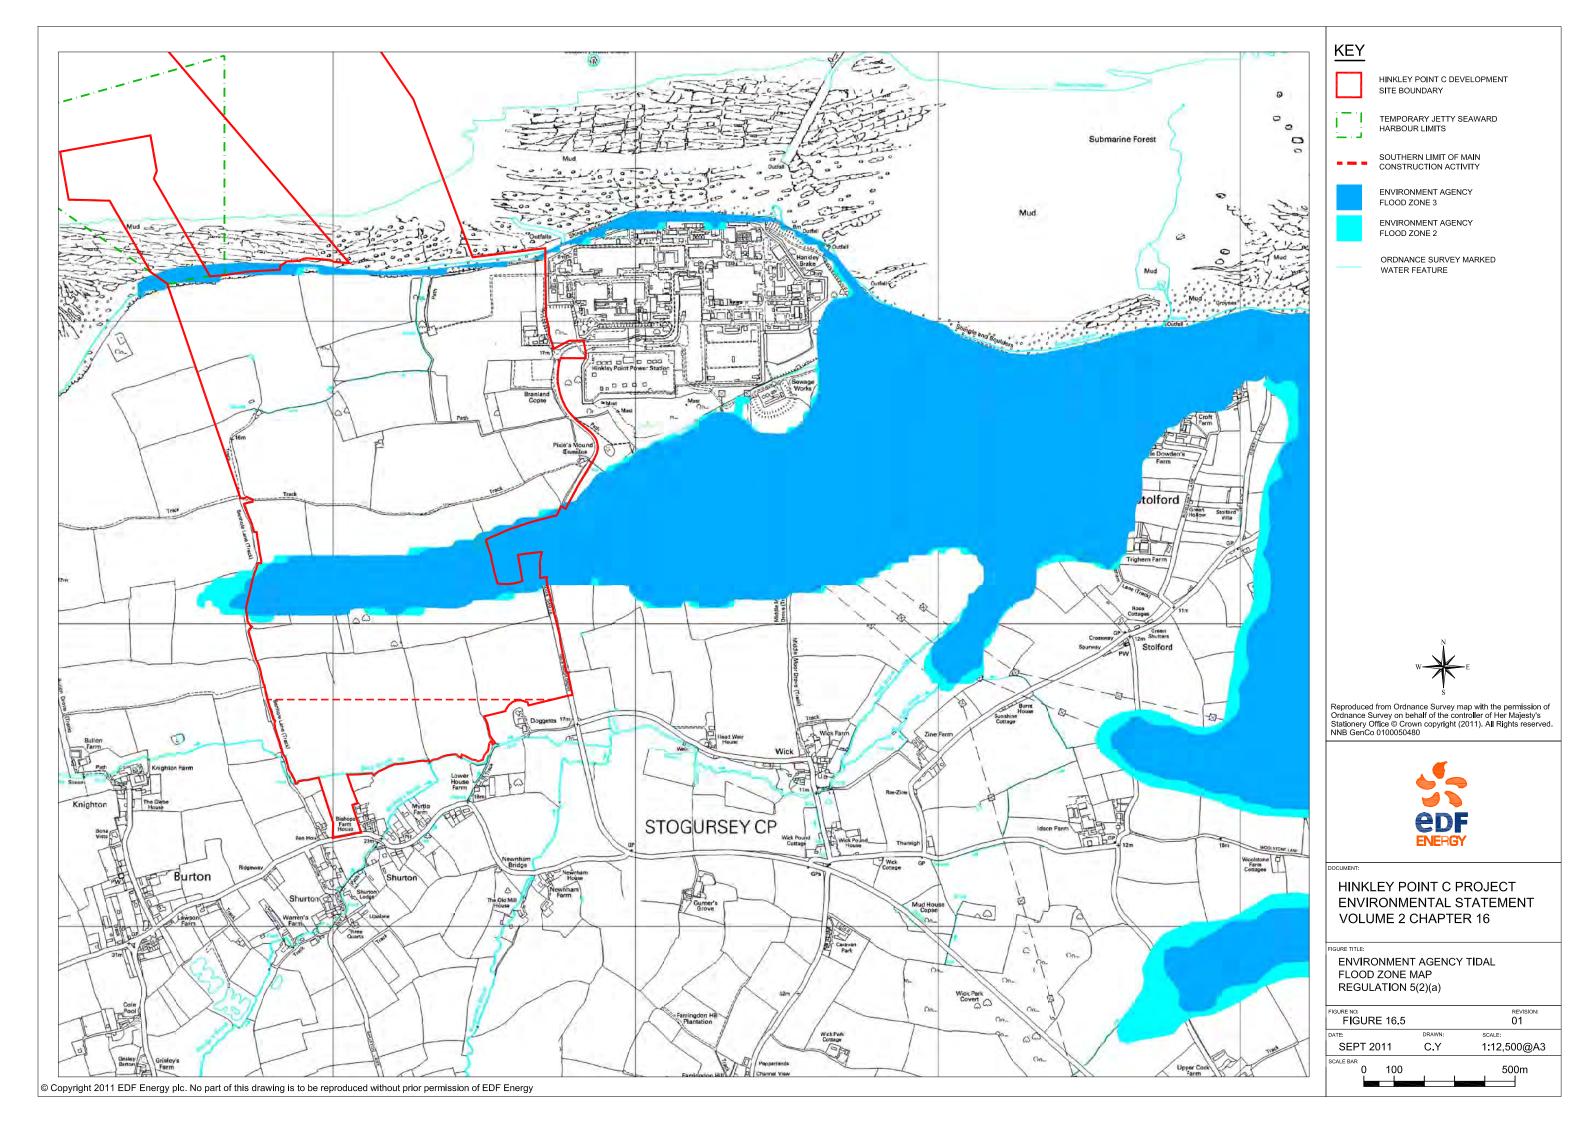
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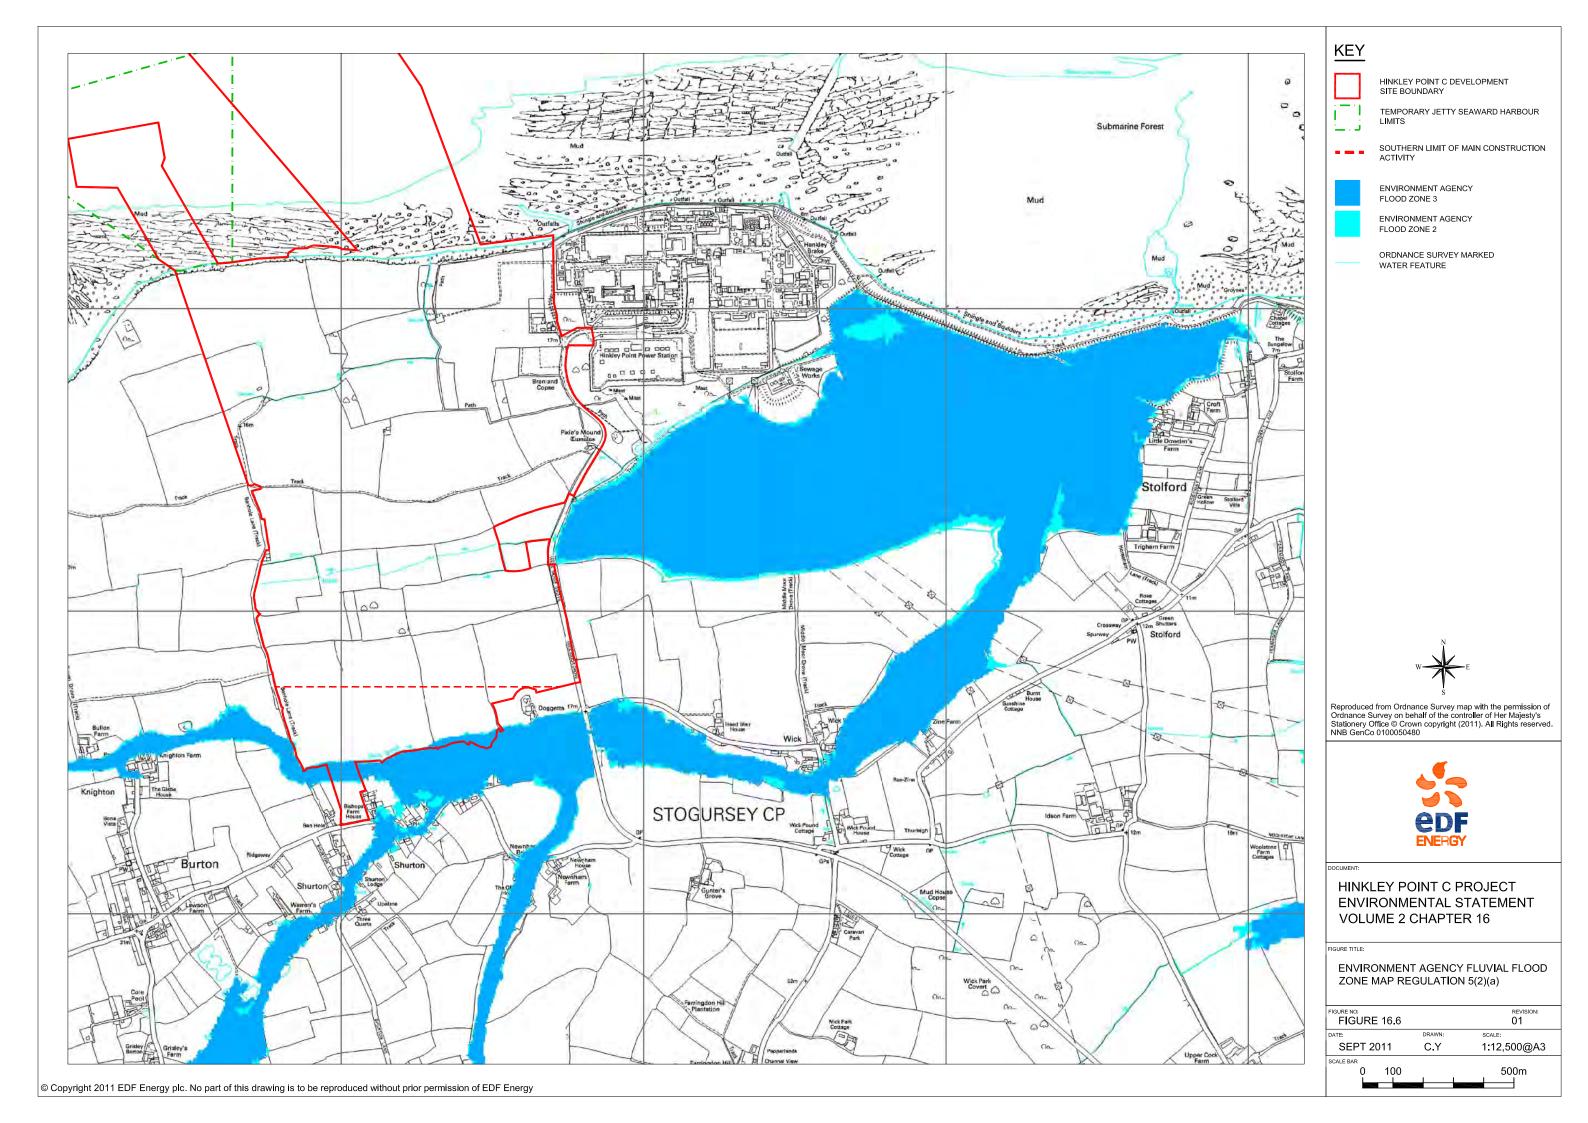
HINKLEY POINT C PROJECT ENVIRONMENTAL STATEMENT VOLUME 2 CHAPTER 16


FIGURE TITLI


ON-SITE & UPSTREAM SUB-CATCHMENTS REGULATION 5 (2)(a)

FIGURE NO:	RE 16.4		REVISION: 01
DATE:		DRAWN:	SCALE:
SEPT	2011	C.Y	1:10,000@A3
SCALE BAR	100		500m





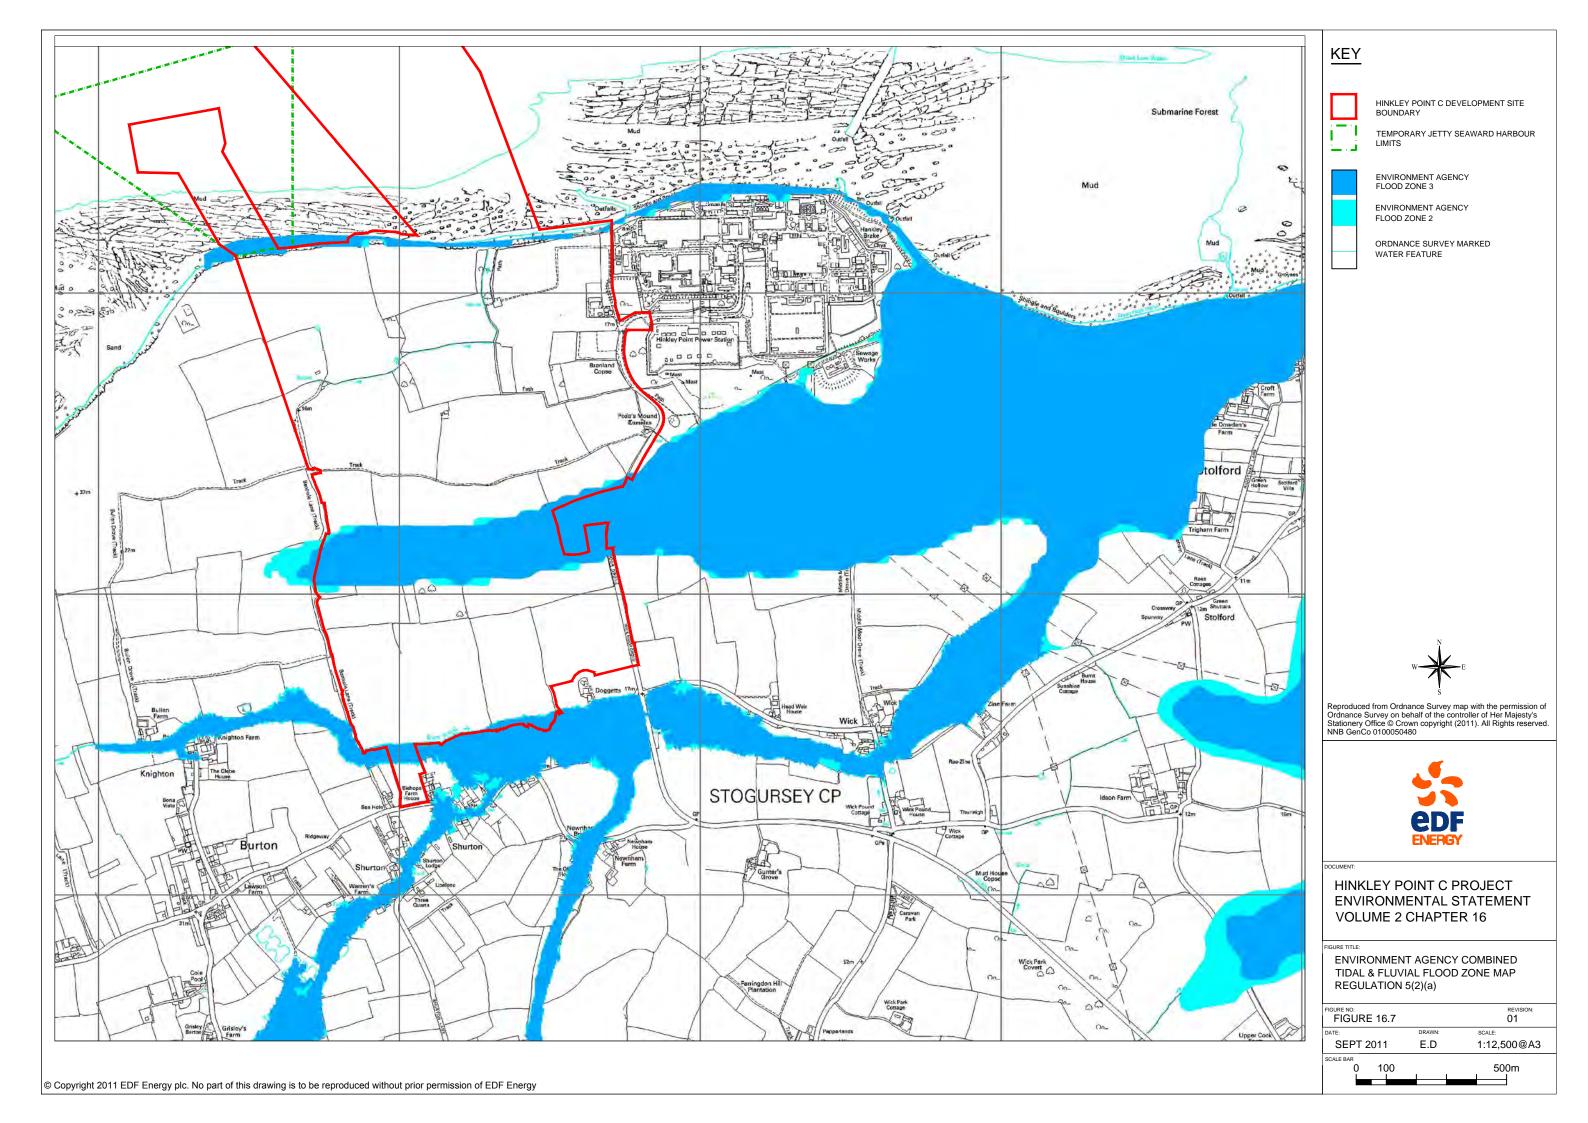

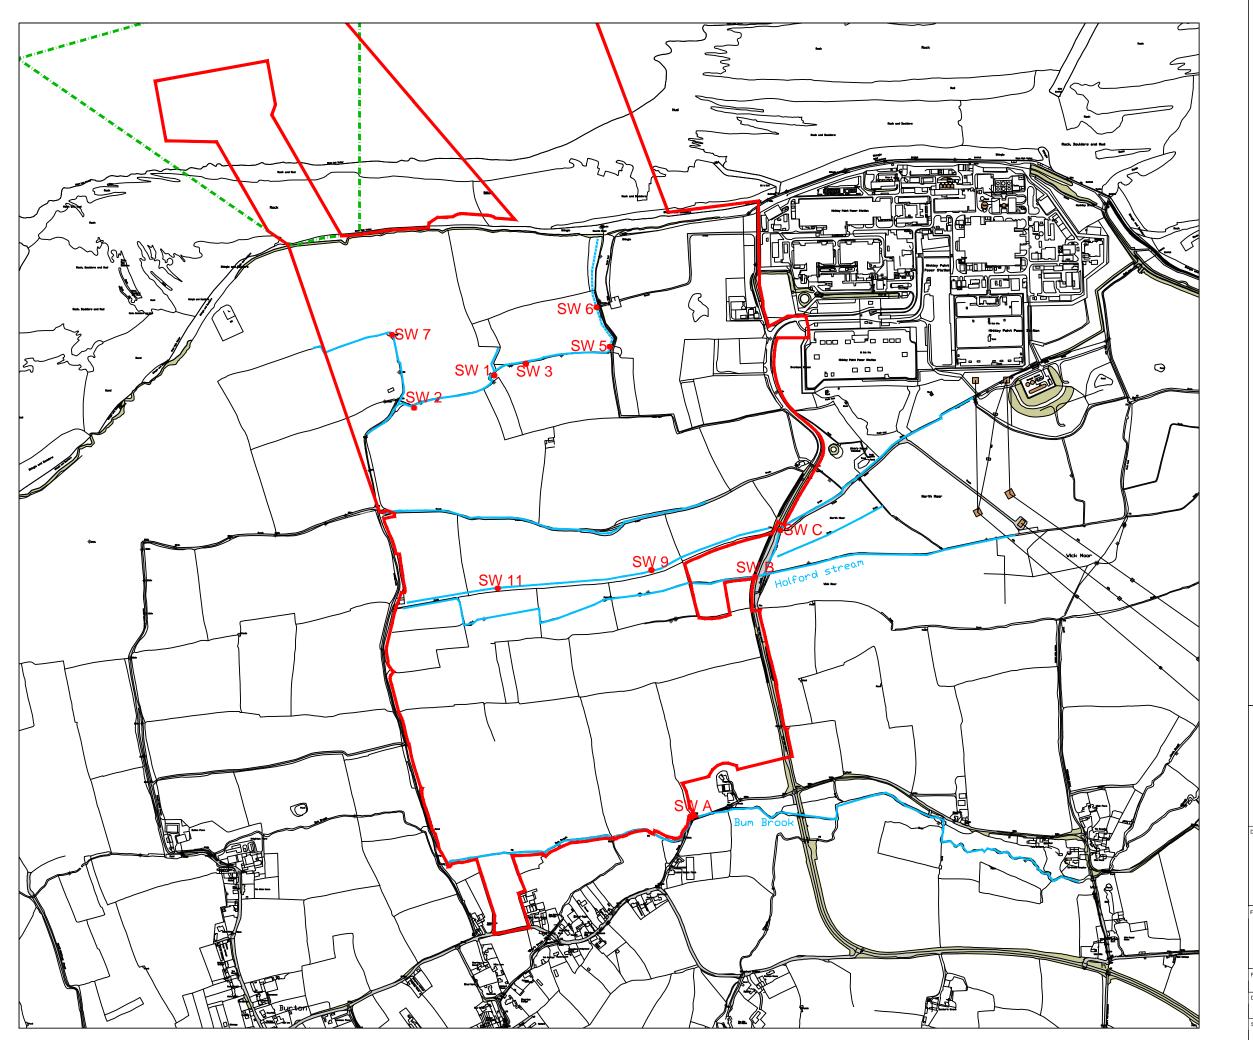



HINKLEY POINT C DEVELOPMENT SITE BOUNDARY



TEMPORARY JETTY SEAWARD HARBOUR LIMITS

SURFACE WATER FEATURE

SURFACE WATER QUALITY SAMPLING LOCATION



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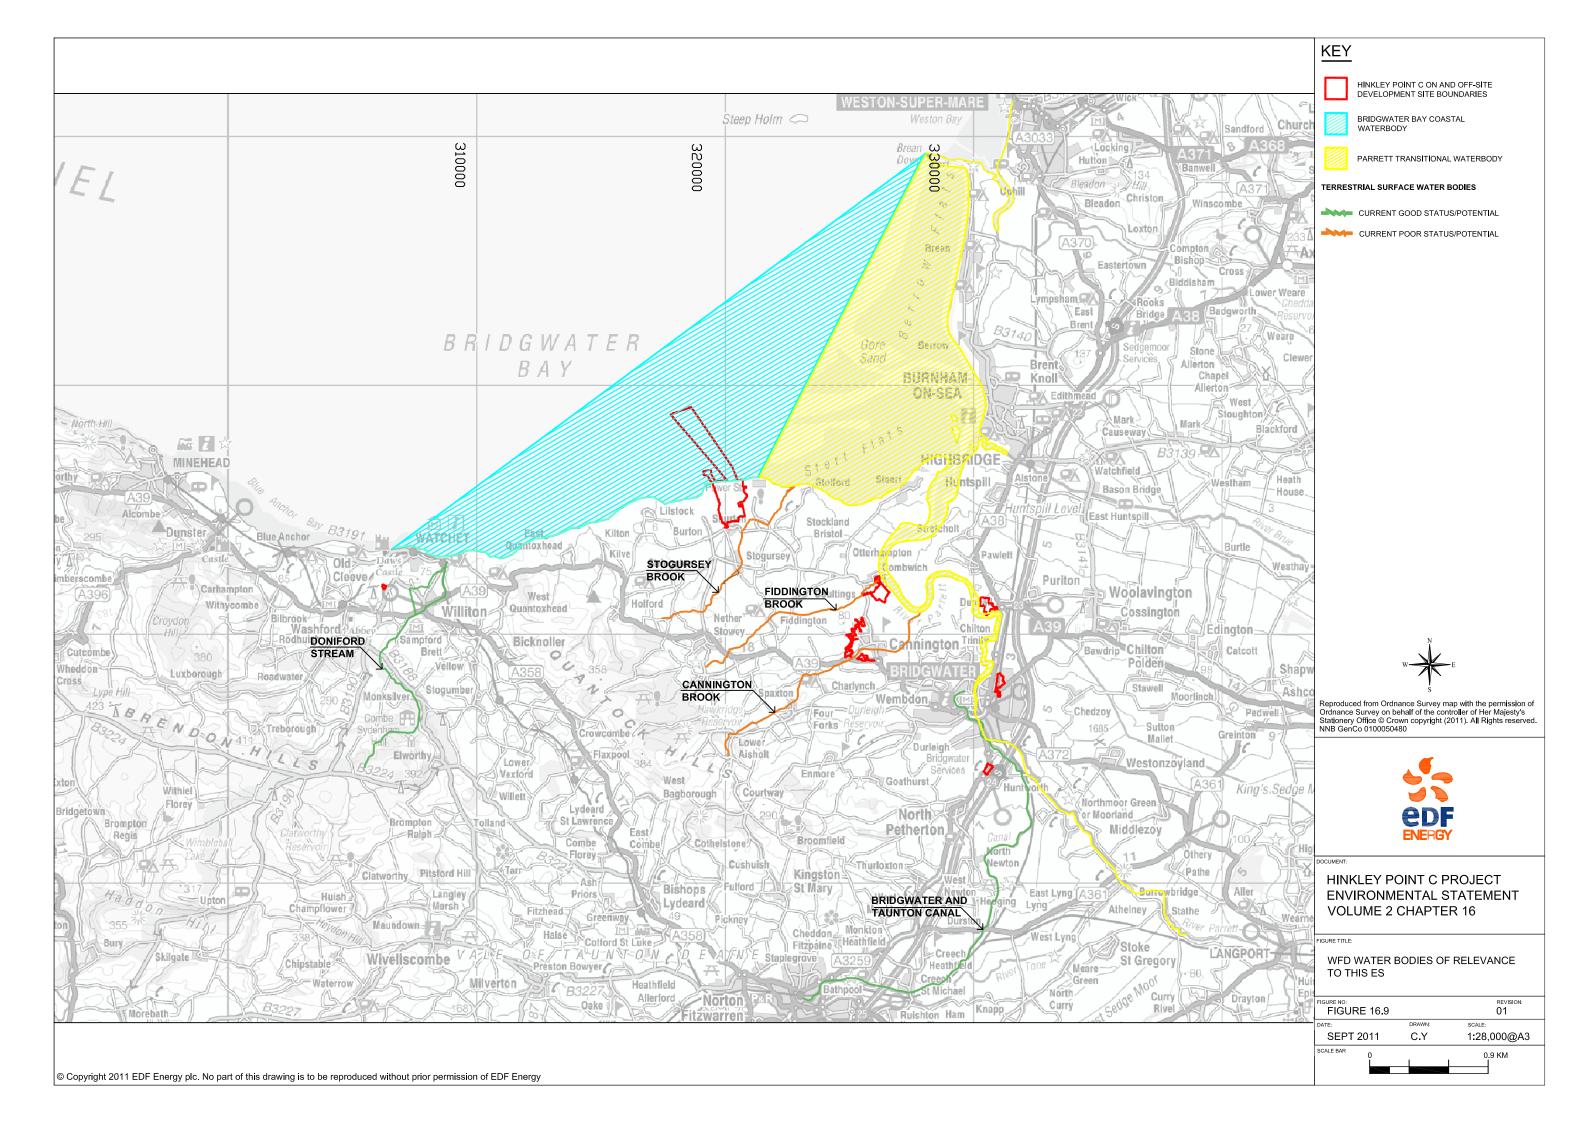
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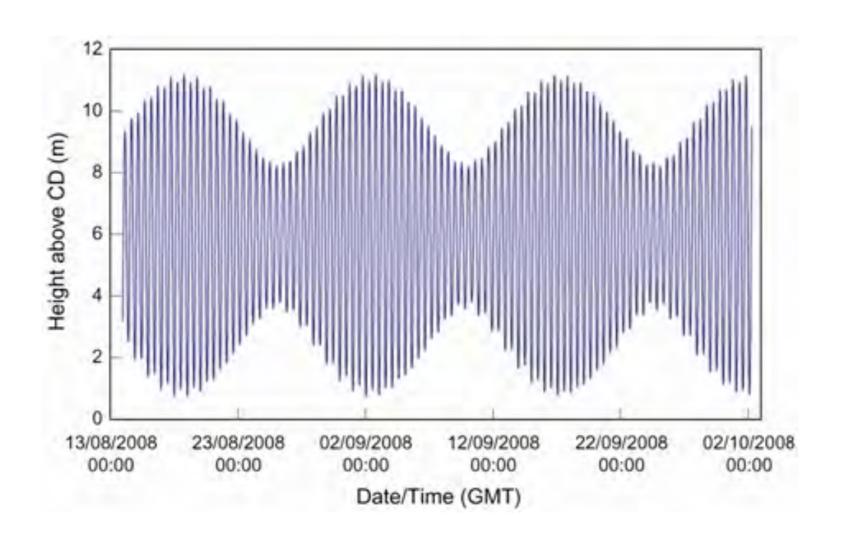
HINKLEY POINT C PROJECT ENVIRONMENTAL STATEMENT VOLUME 2 CHAPTER 15

GURE TITLE:

FRESHWATER SURFACE MONITORING LOCATION PLAN REGULATION 5(2)(a)

FIGURE NO: FIGURE 16.8		REVISION: 01
DATE:	DRAWN:	SCALE:
SEPT 2011	R.W	1:10,000@A3
SCALE BAR 0	200	500m





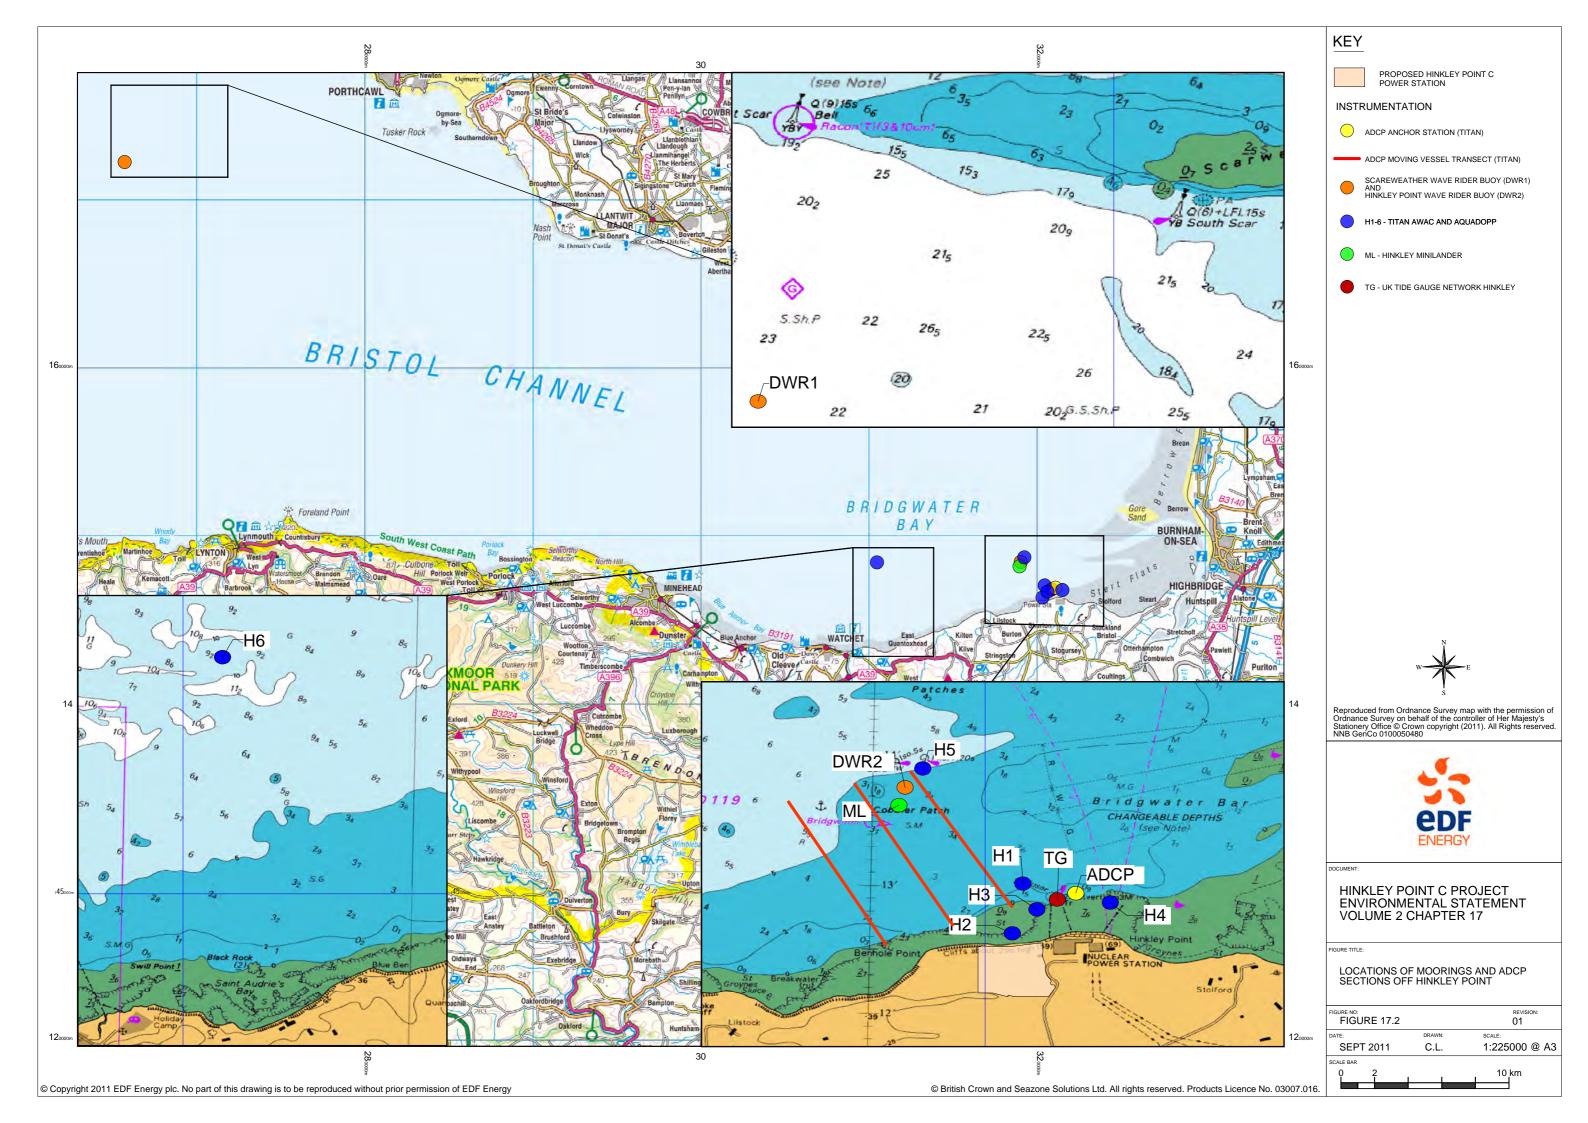


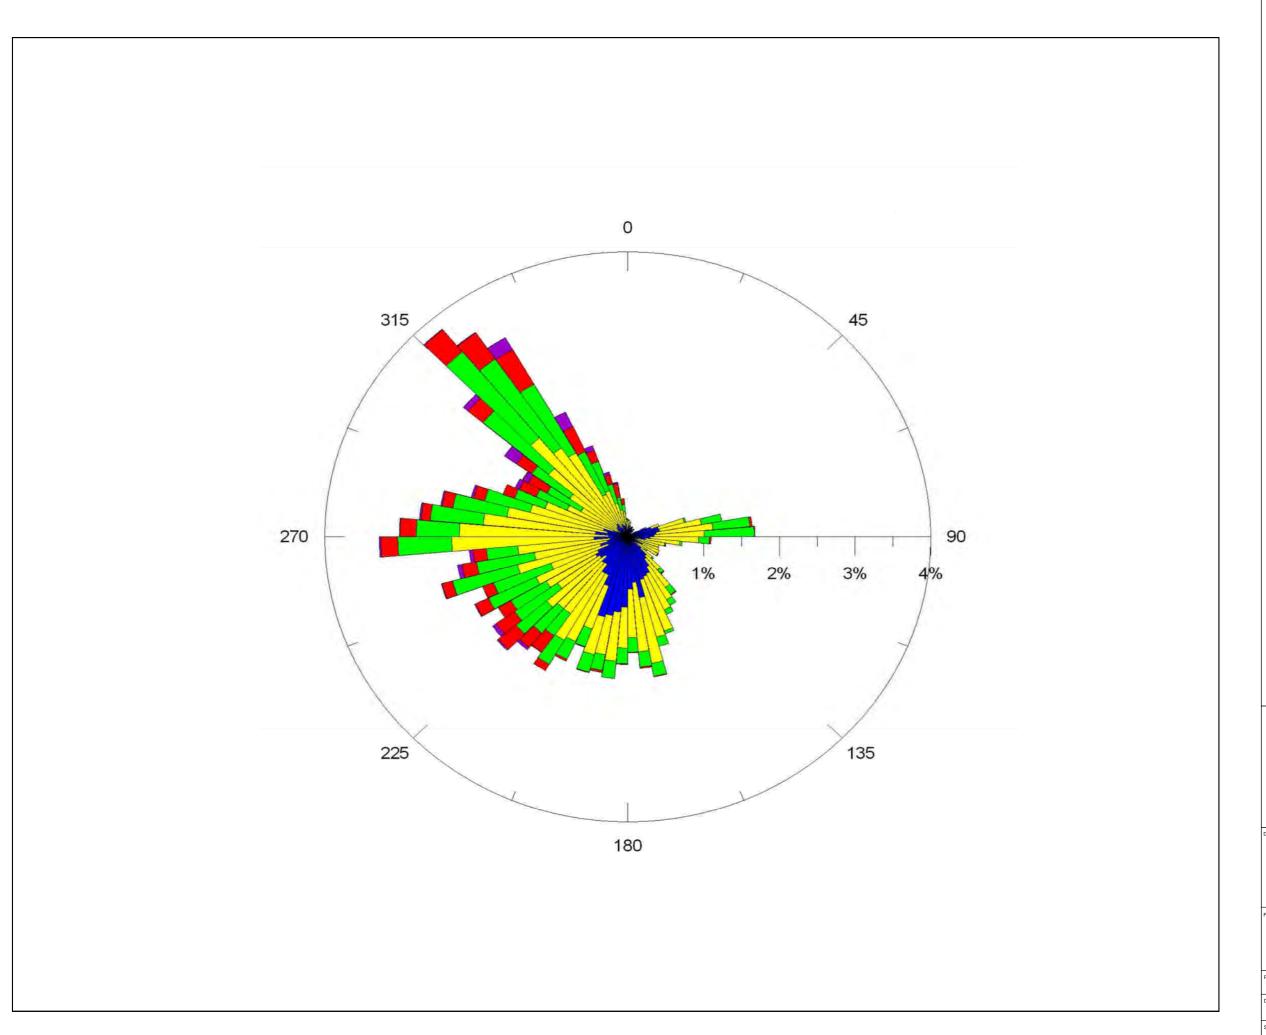
HINKLEY POINT C PROJECT ENVIRONMENTAL STATEMENT VOLUME 2 CHAPTER 17


FIGURE TITL

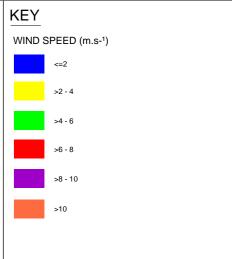PREDICTED TIDAL ELEVATIONS DURING THE HYDROGRAPHIC SURVEY

GURE NO: FIGURE 17.1			REVISION:	
SEPT 2011	C.L.	SCALE:		
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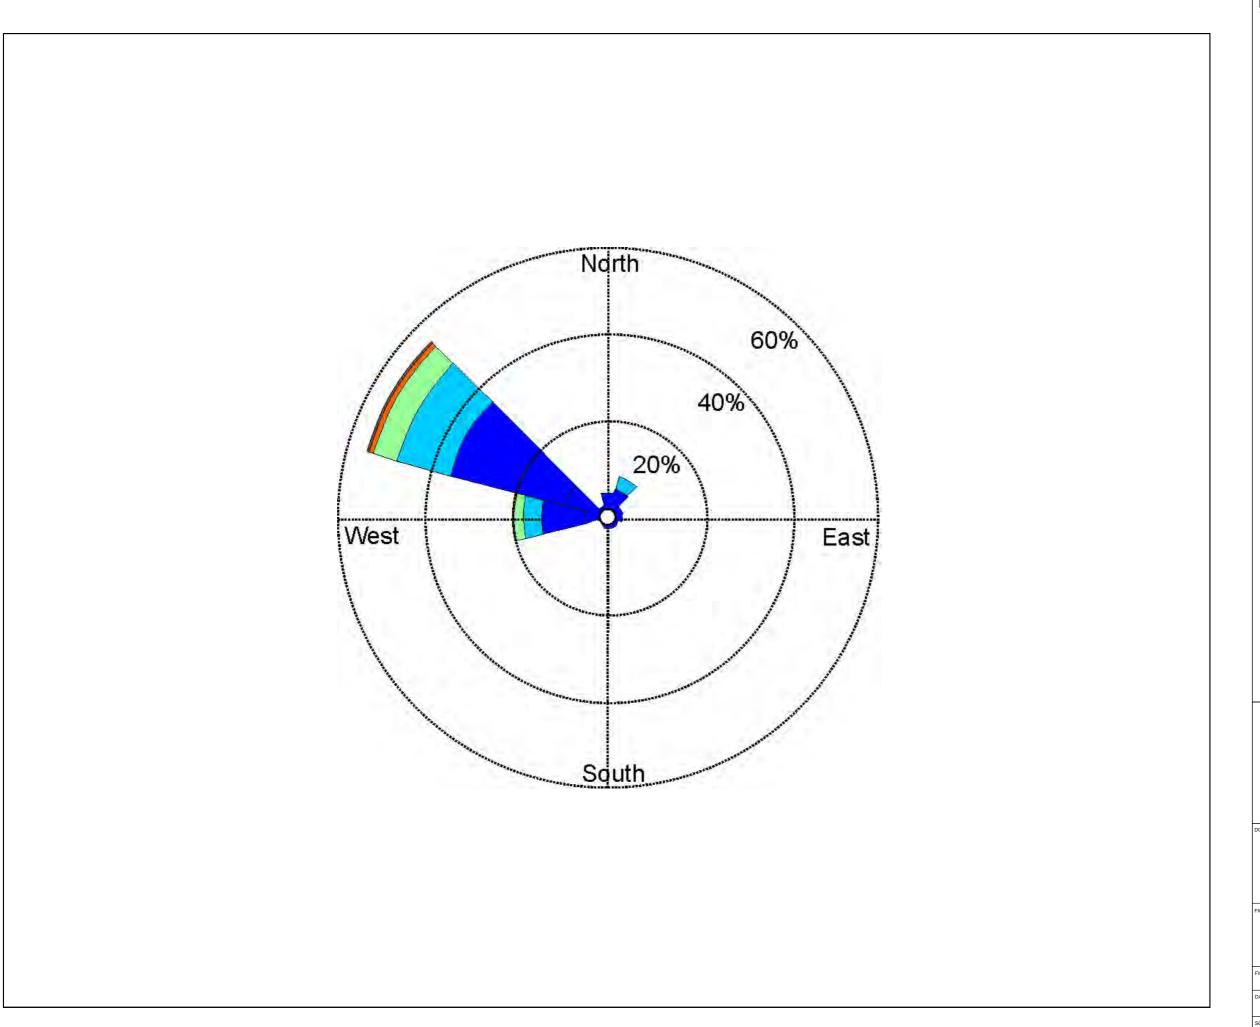


HINKLEY POINT C PROJECT ENVIRONMENTAL STATEMENT VOLUME 2 CHAPTER 17

FIGURE TITL

FREQUENCY OF WIND SPEED (m.s-1) AT HINKLEY (GORE BUOY) WAVERIDER LOCATION, DECEMBER 2008-JULY 2009

FIGURE 17.3			REVISION:
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ALE BAR			









HINKLEY POINT C PROJECT ENVIRONMENTAL STATEMENT VOLUME 2 CHAPTER 17

FIGURE TITL

WAVE HEIGHT, DIRECTION AND FREQUENCY AT HINKLEY (GORE BUOY) WAVERIDER LOCATION, DECEMBER 2008 - JULY 2009

FIGURE NO: FIGURE 17.4		REVISION: 01
SEPT 2011	DRAWN: C.L.	SCALE:
SCALE BAR		

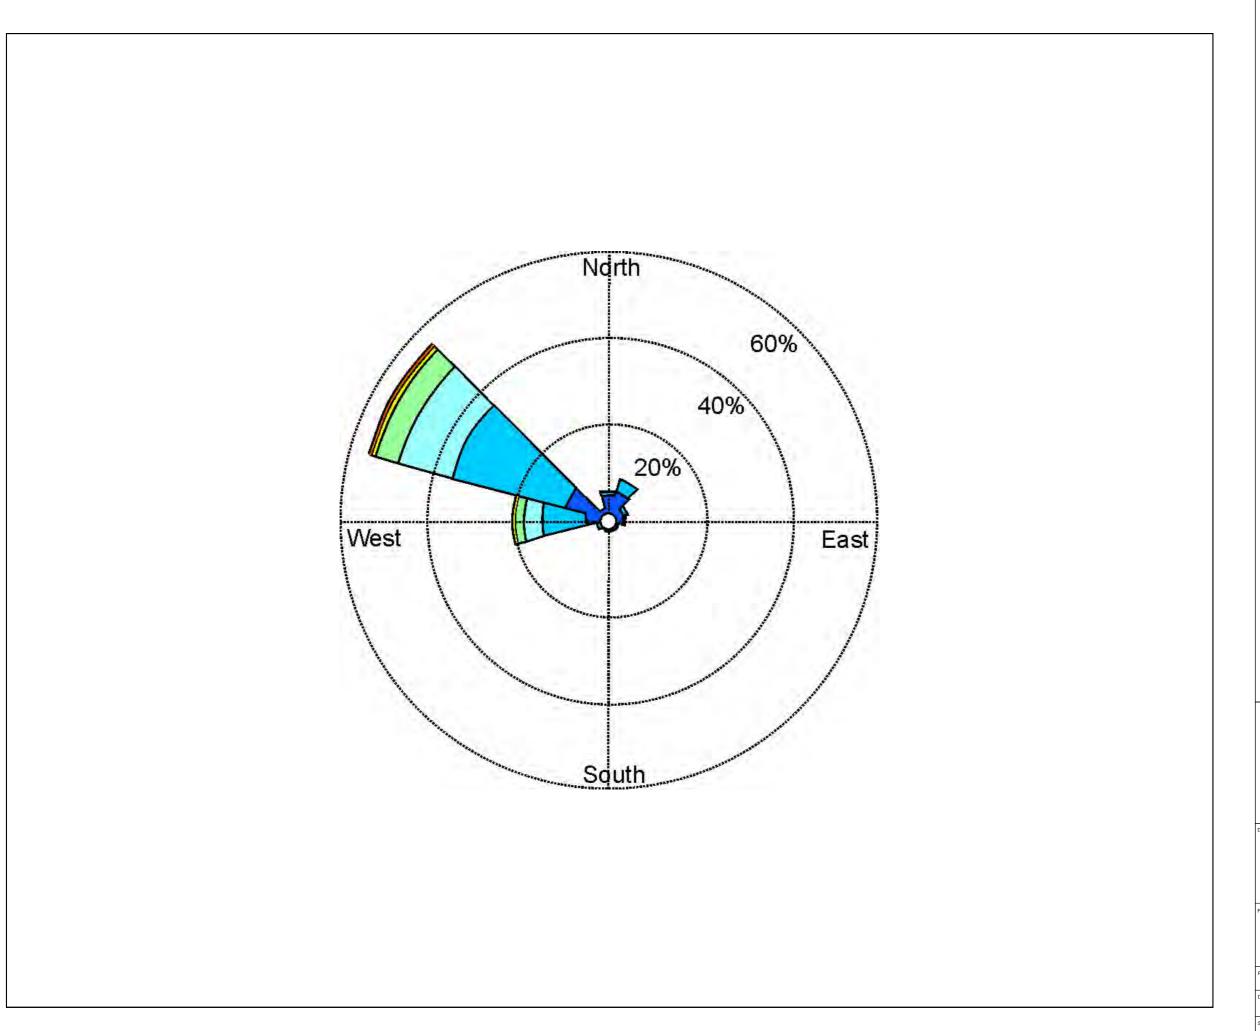

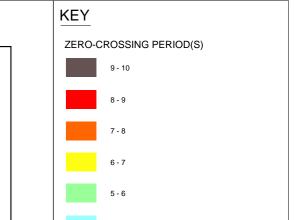




HINKLEY POINT C PROJECT ENVIRONMENTAL STATEMENT VOLUME 2 CHAPTER 17

FIGURE TITL

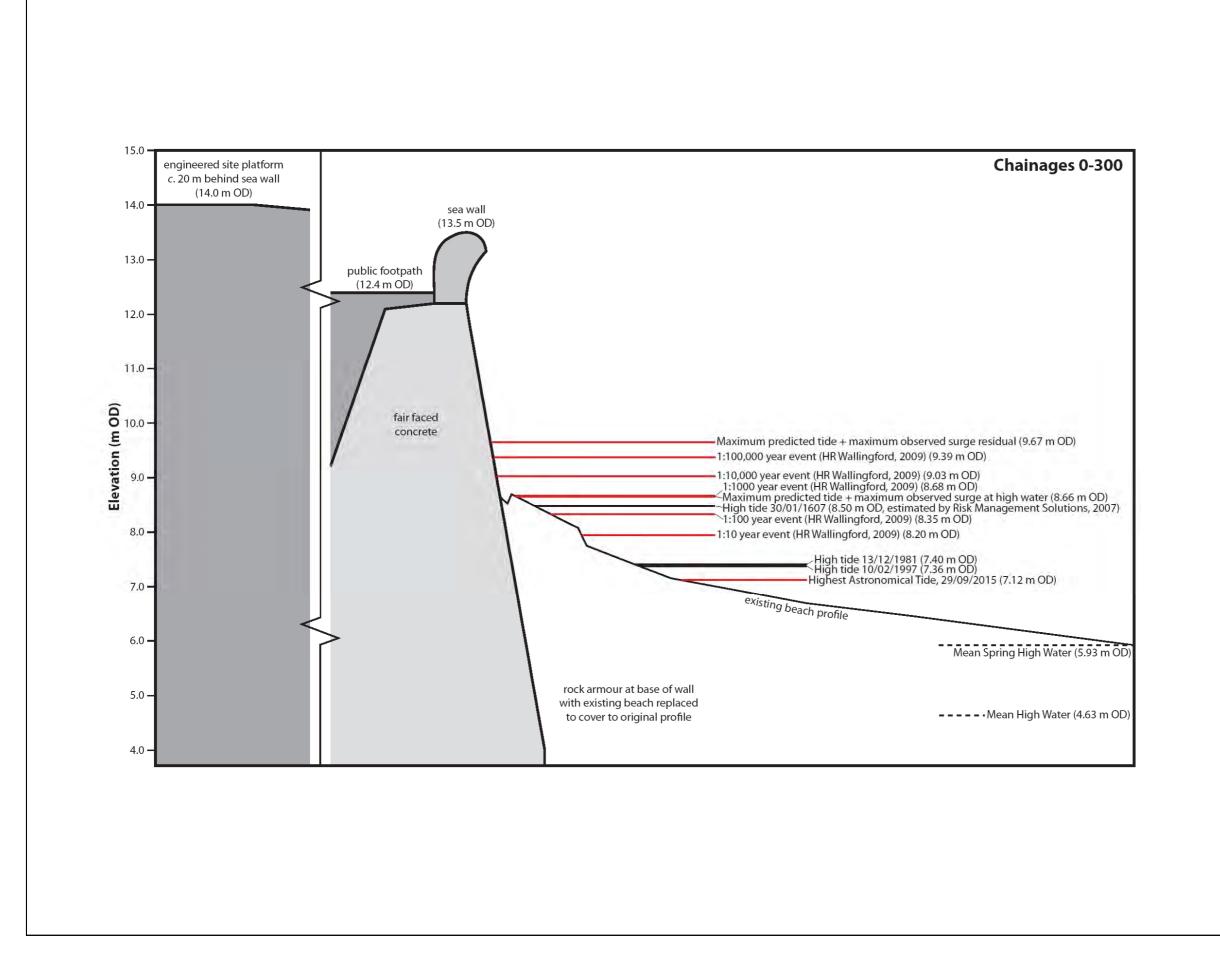WAVE PERIOD, DIRECTION AND FREQENCY AT HINKLEY (GORE BUOY) WAVERIDER LOCATION, DECEMBER 2008 - JULY 2009

GURE NO:		REVISION:	
FIGURE 17.5		01	
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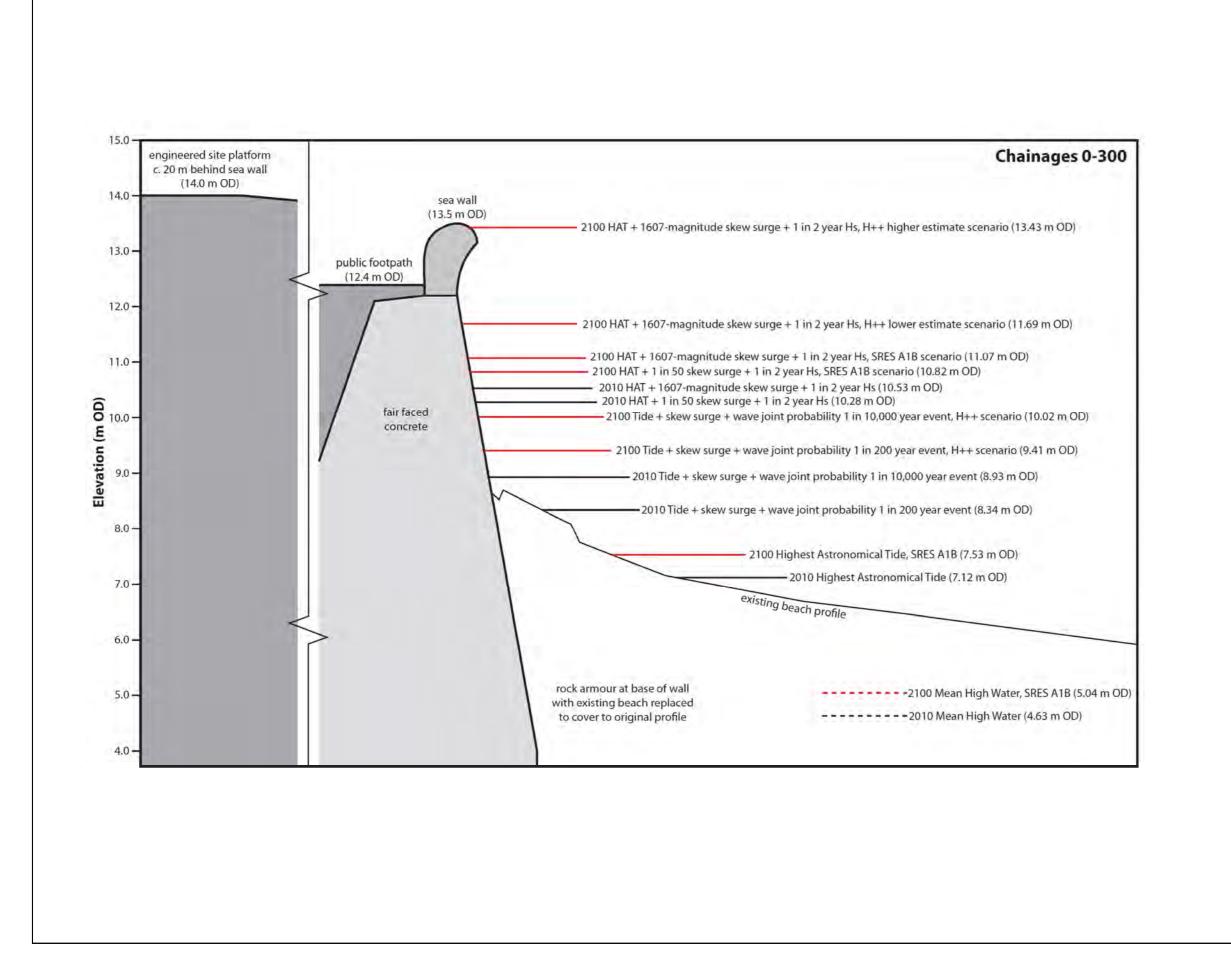



HINKLEY POINT C PROJECT ENVIRONMENTAL STATEMENT VOLUME 2 CHAPTER 17

FIGURE TITL

OBSERVED (BLACK) AND PREDICTED (RED) EXTREME WATER LEVELS, OVERLAIN ON THE PROPOSED SEA WALL DESIGN FOR HPC

FIGURE NO: FIGURE 17.6		REVISION:	
DATE:	DRAWN:	SCALE:	
SEPT 2011	C.L.		
SCALE BAR			



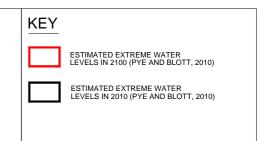




HINKLEY POINT C PROJECT ENVIRONMENTAL STATEMENT VOLUME 2 CHAPTER 17


FIGURE TITL


EXTREME WATER LEVELS ESTIMATED FOR 2010 (BLACK) AND 2100 (RED), OVERLAIN ON THE PROPOSED SEA WALL DESIGN FOR HPC


FIGURE 17.7			REVISION:
DATE:	DRAWN:	SCALE:	
SEPT 2011	C.L.		




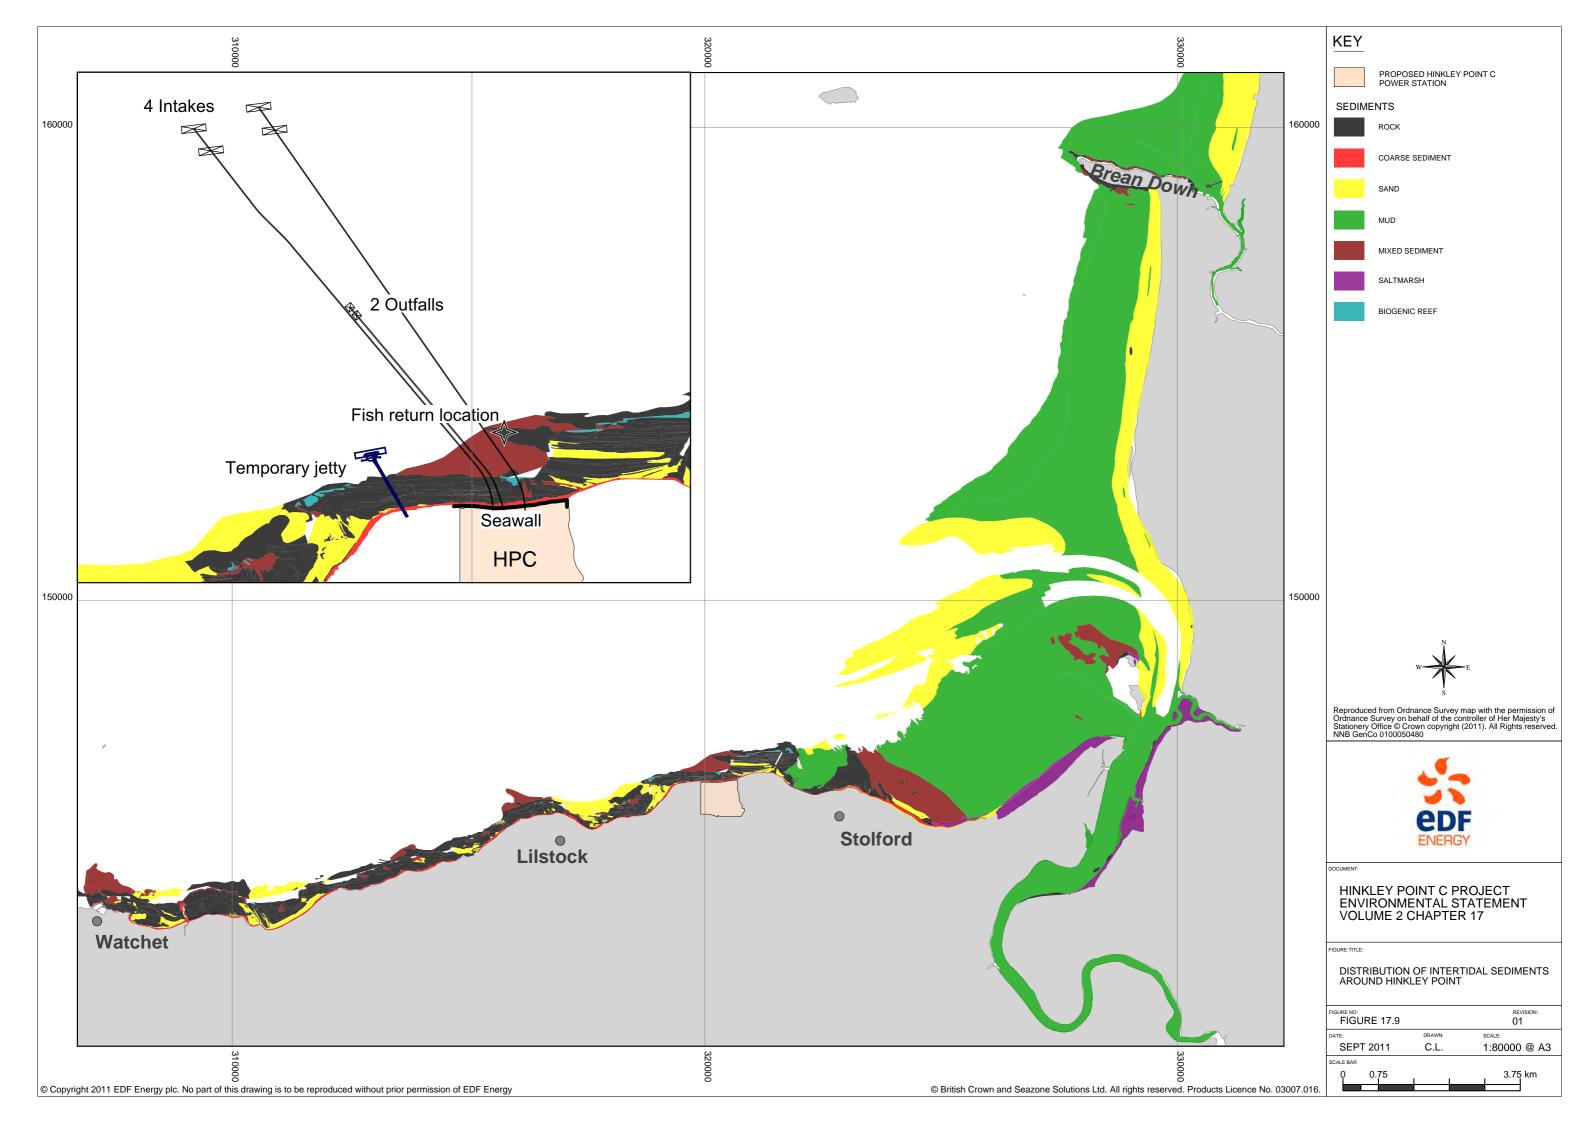


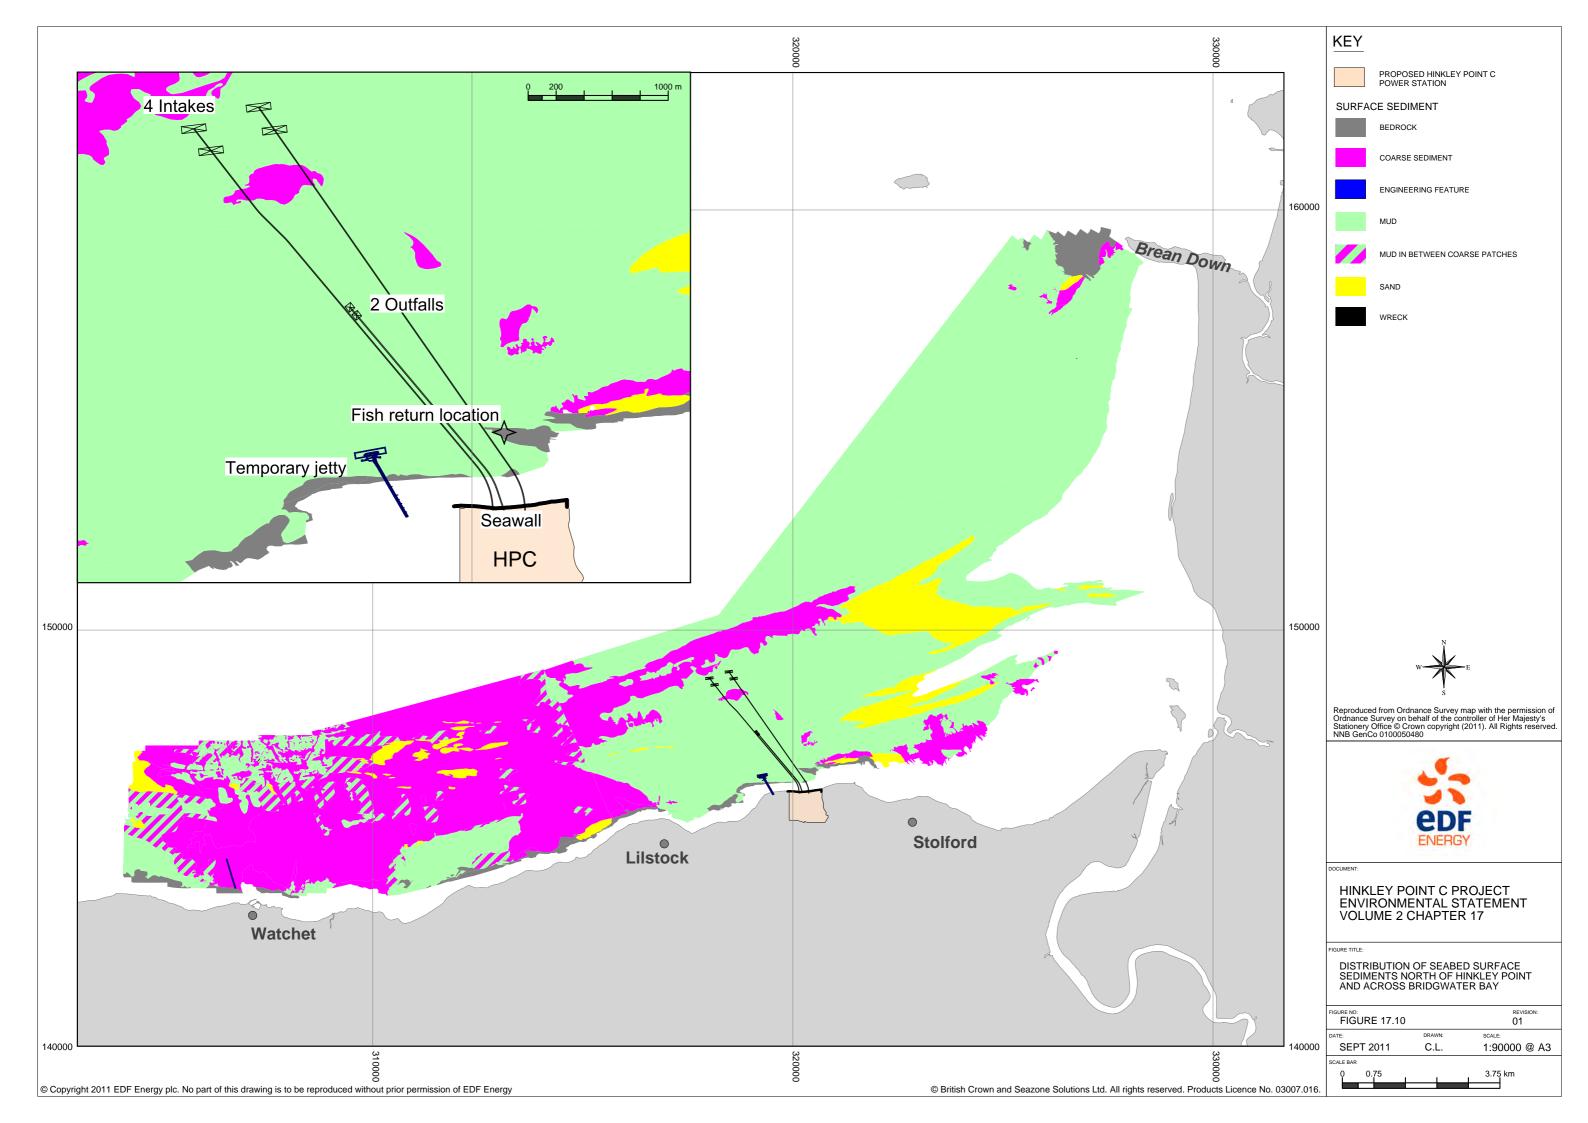


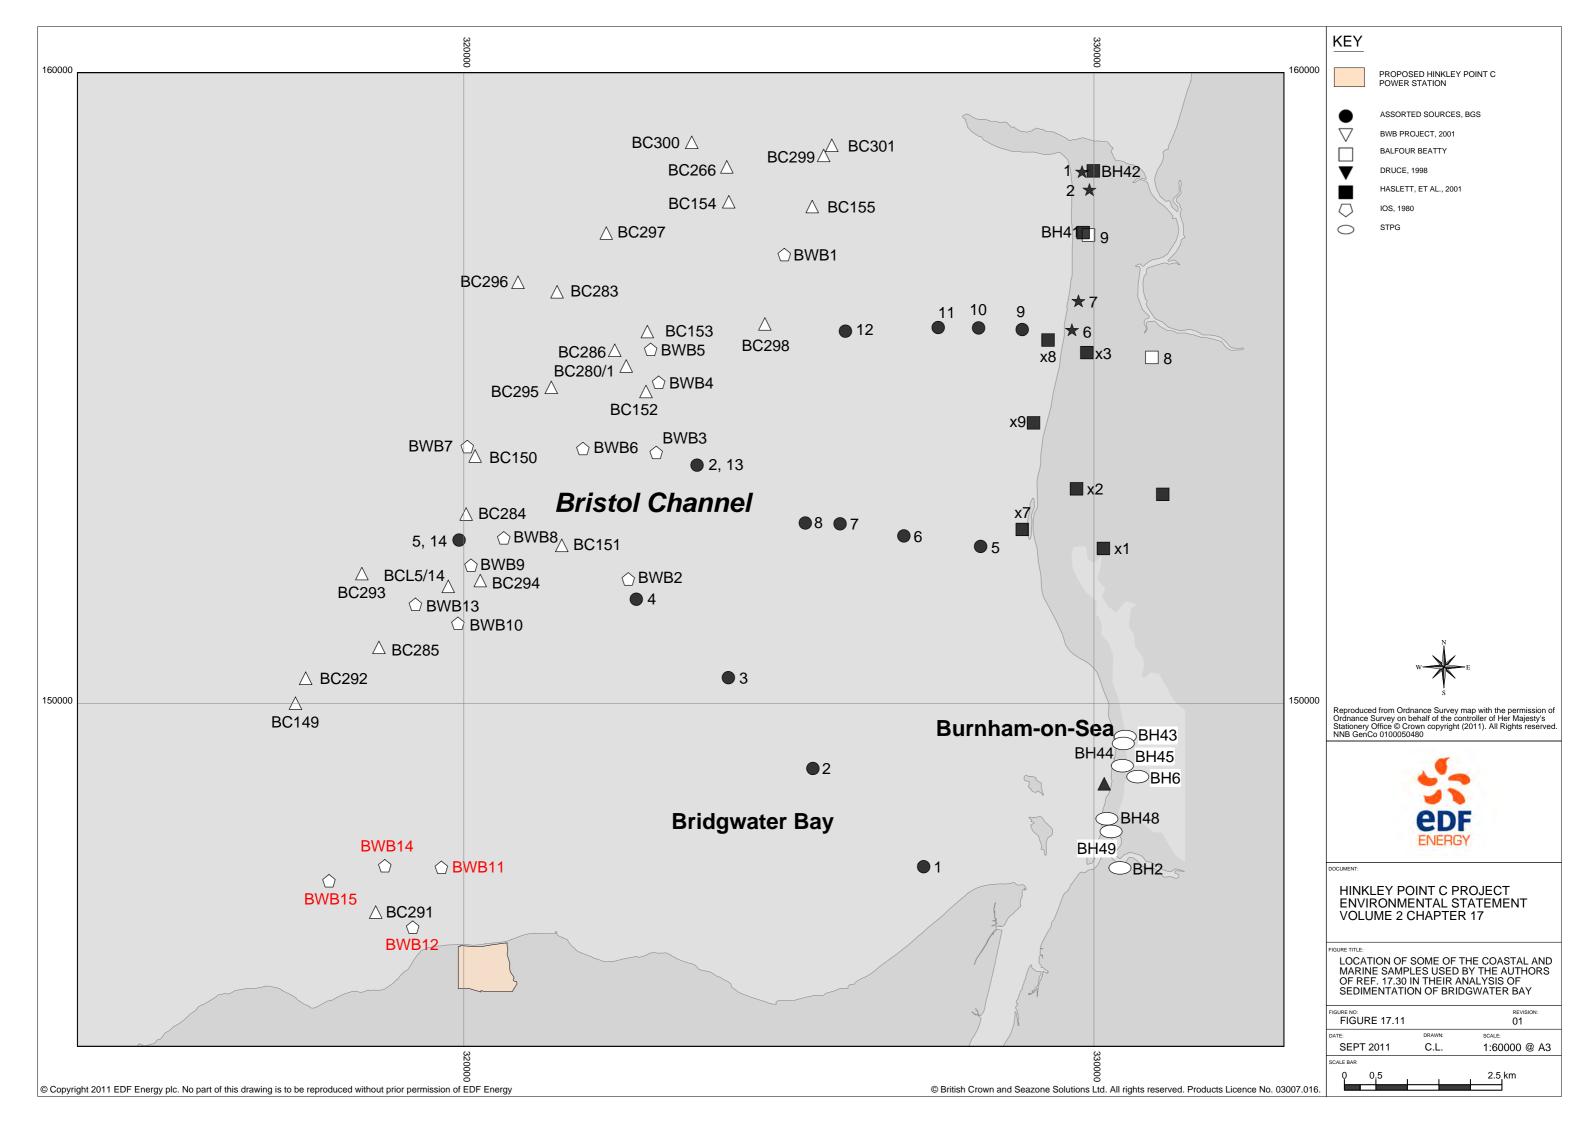

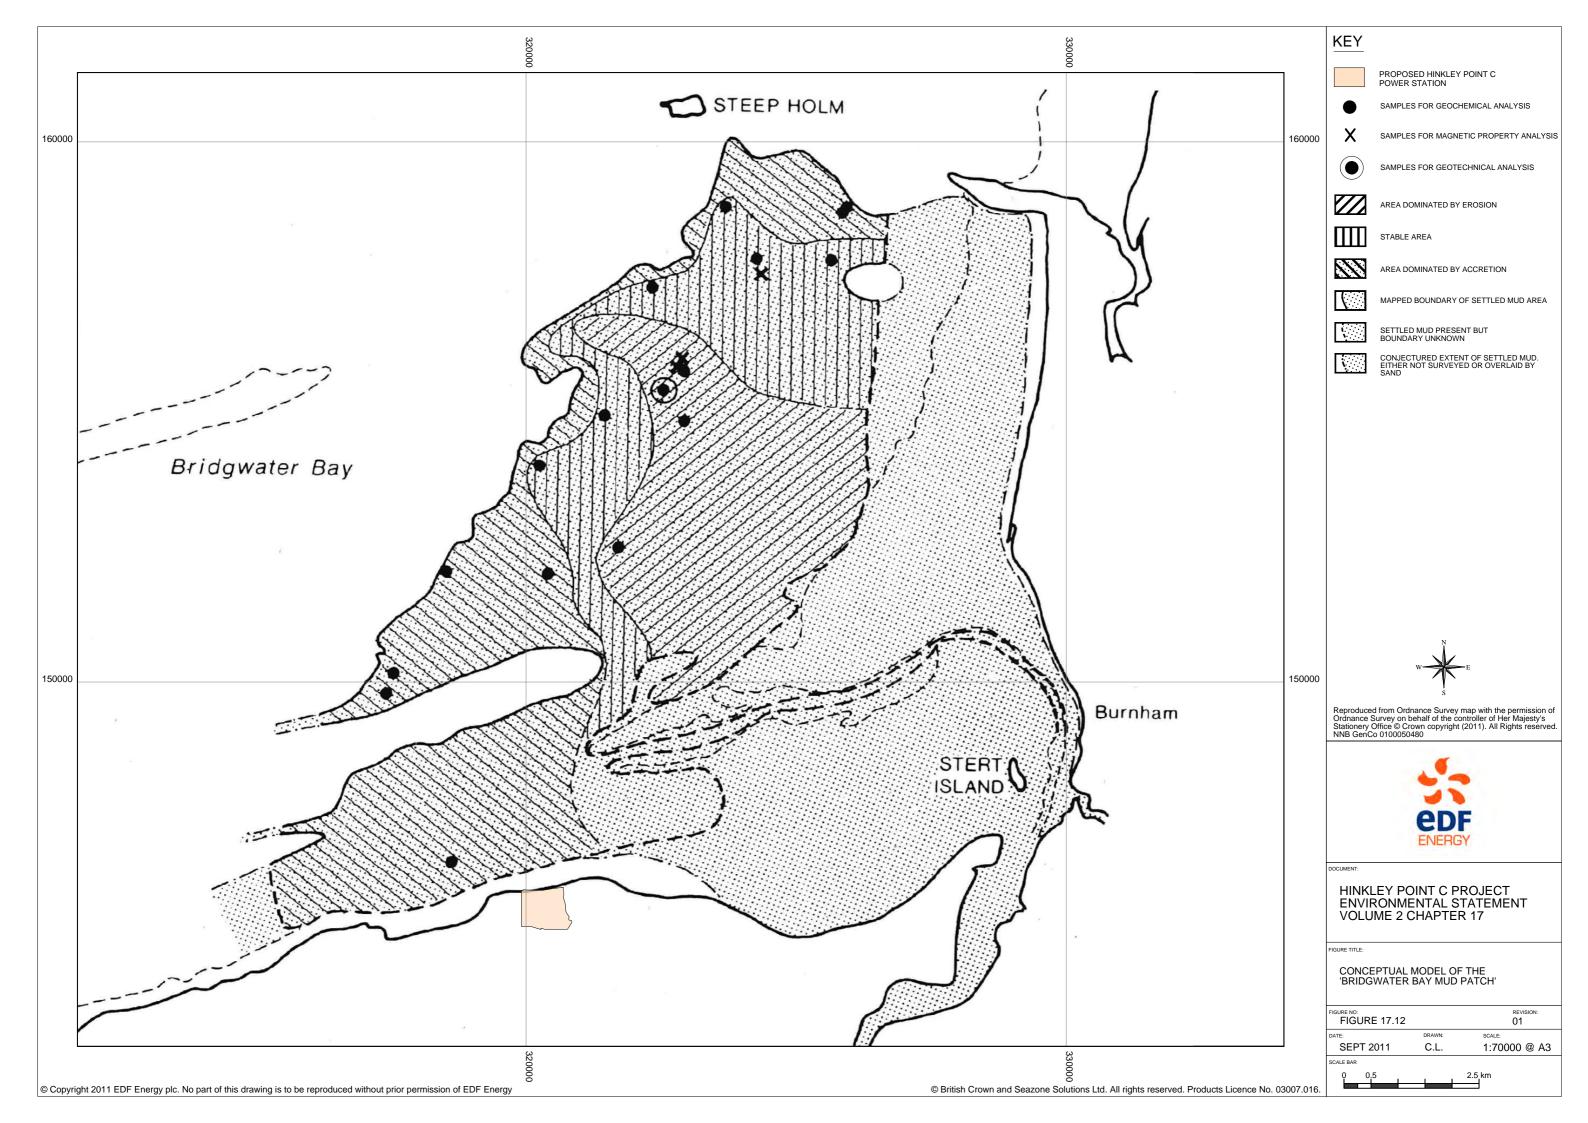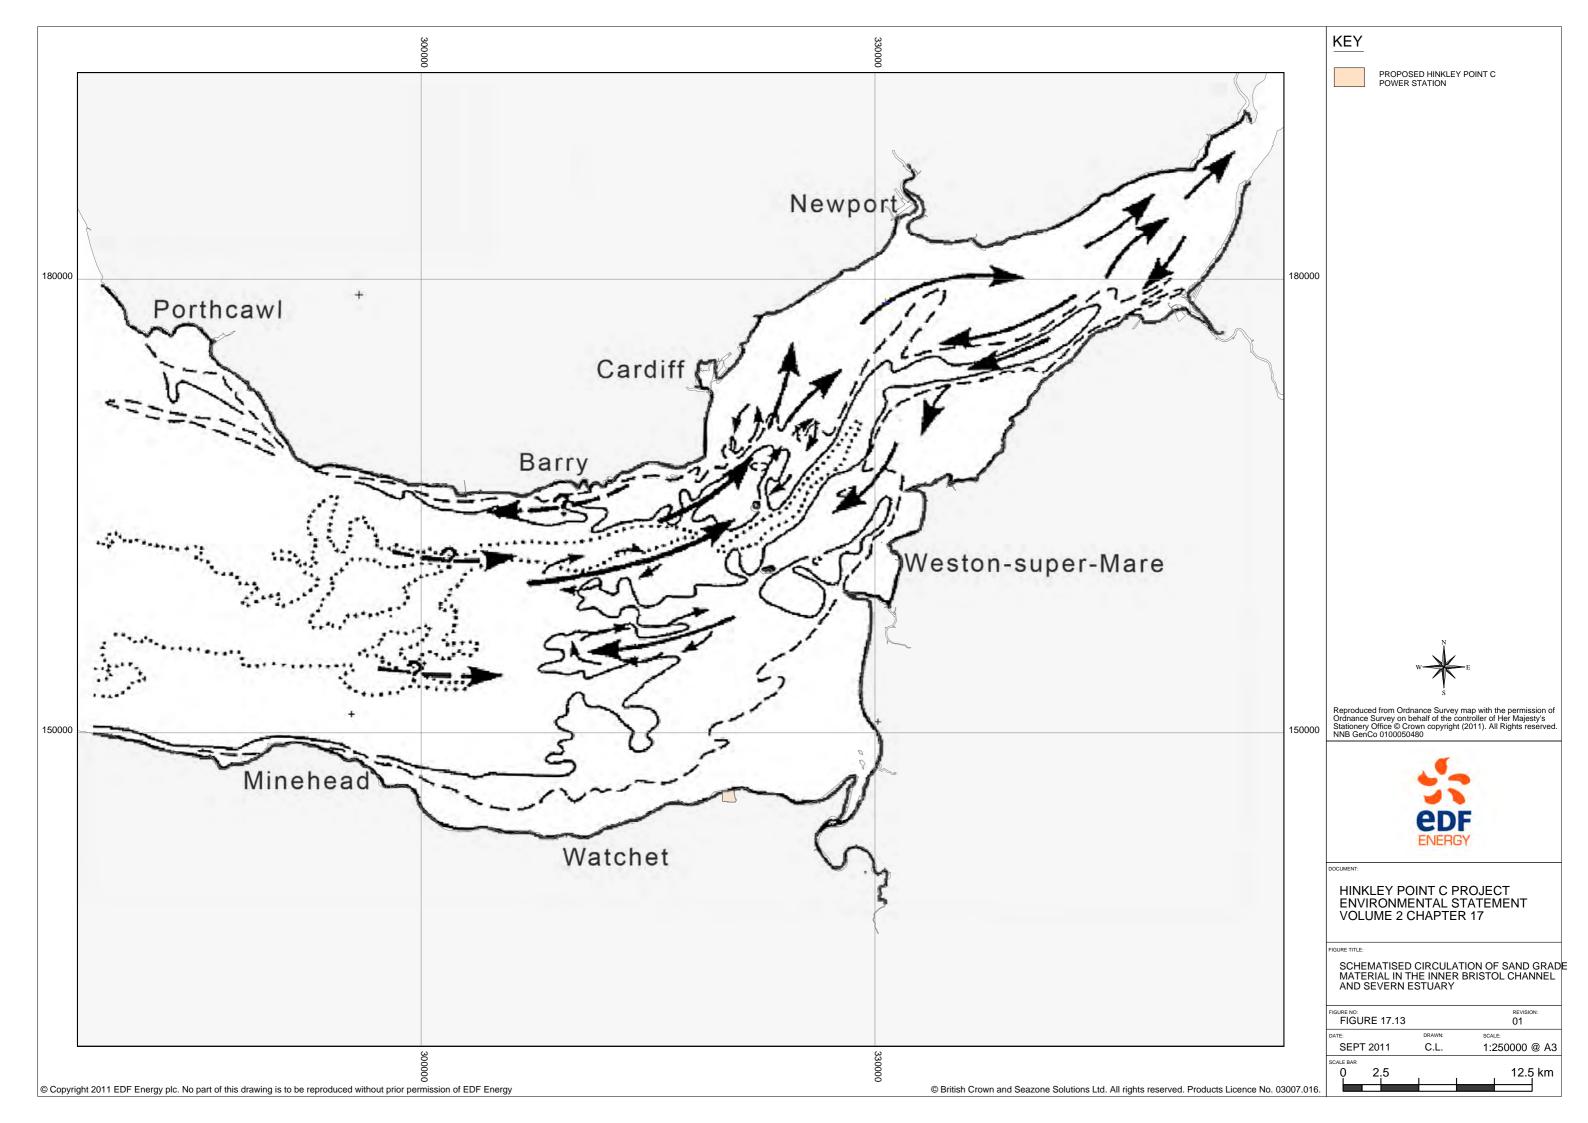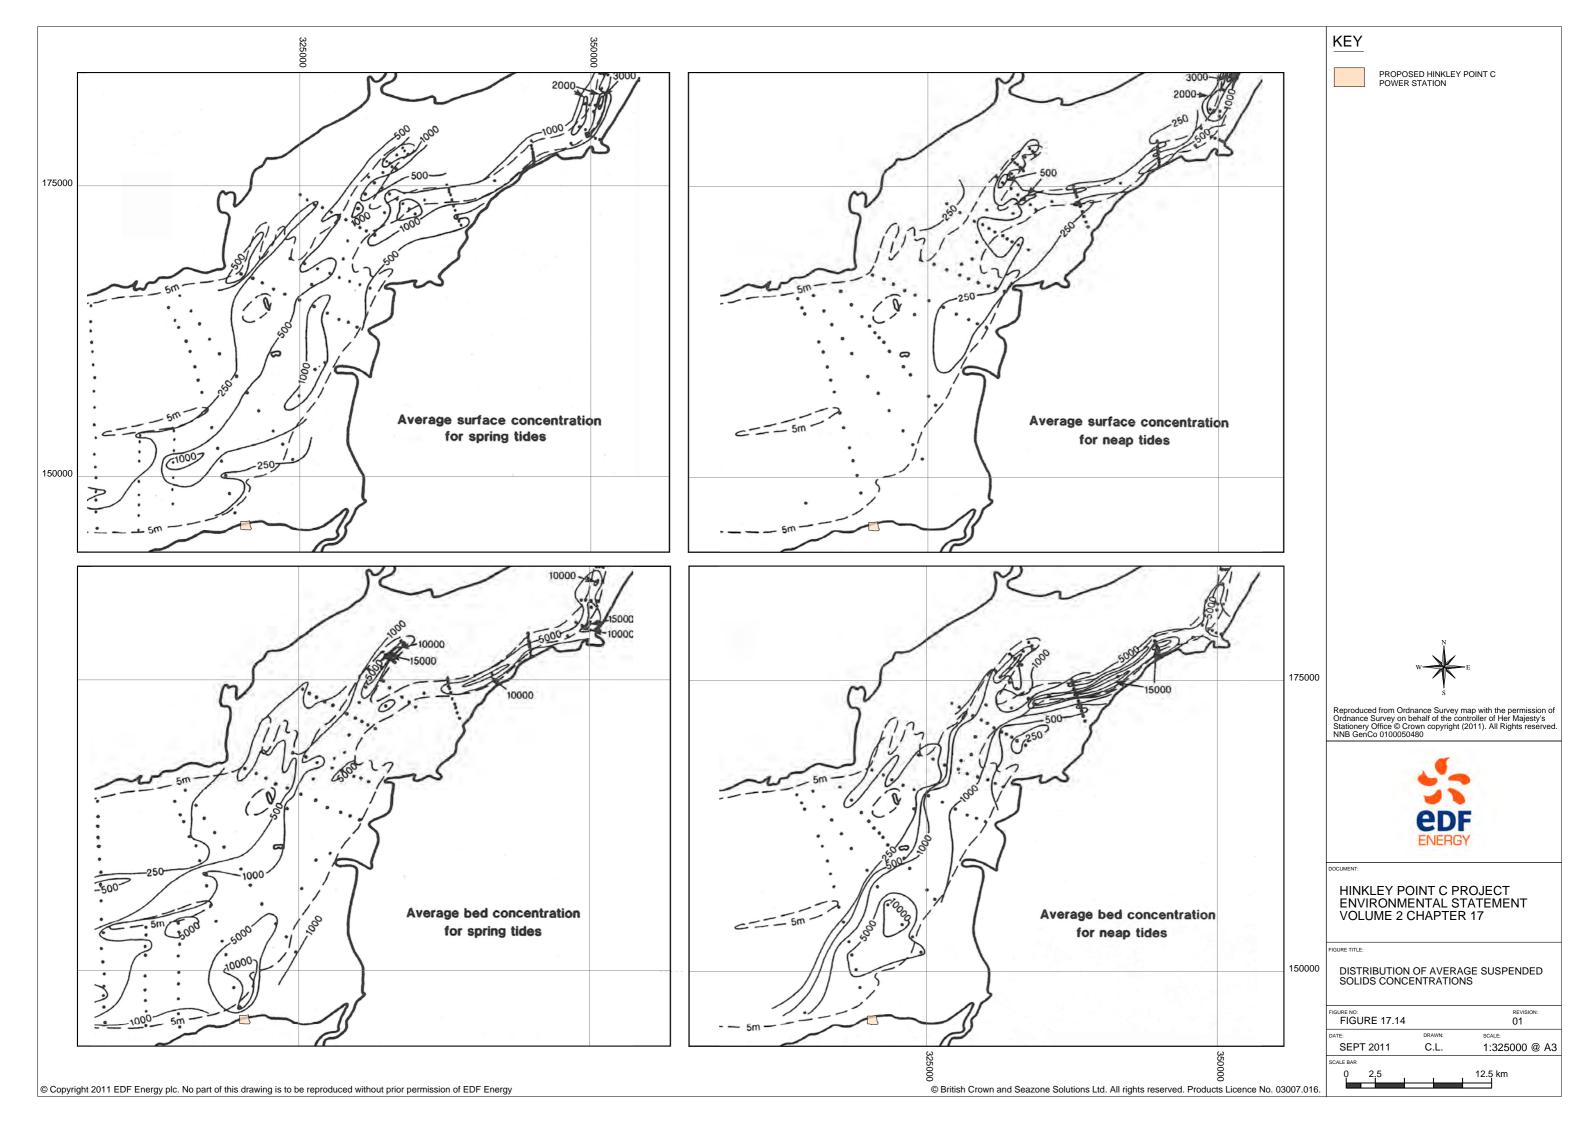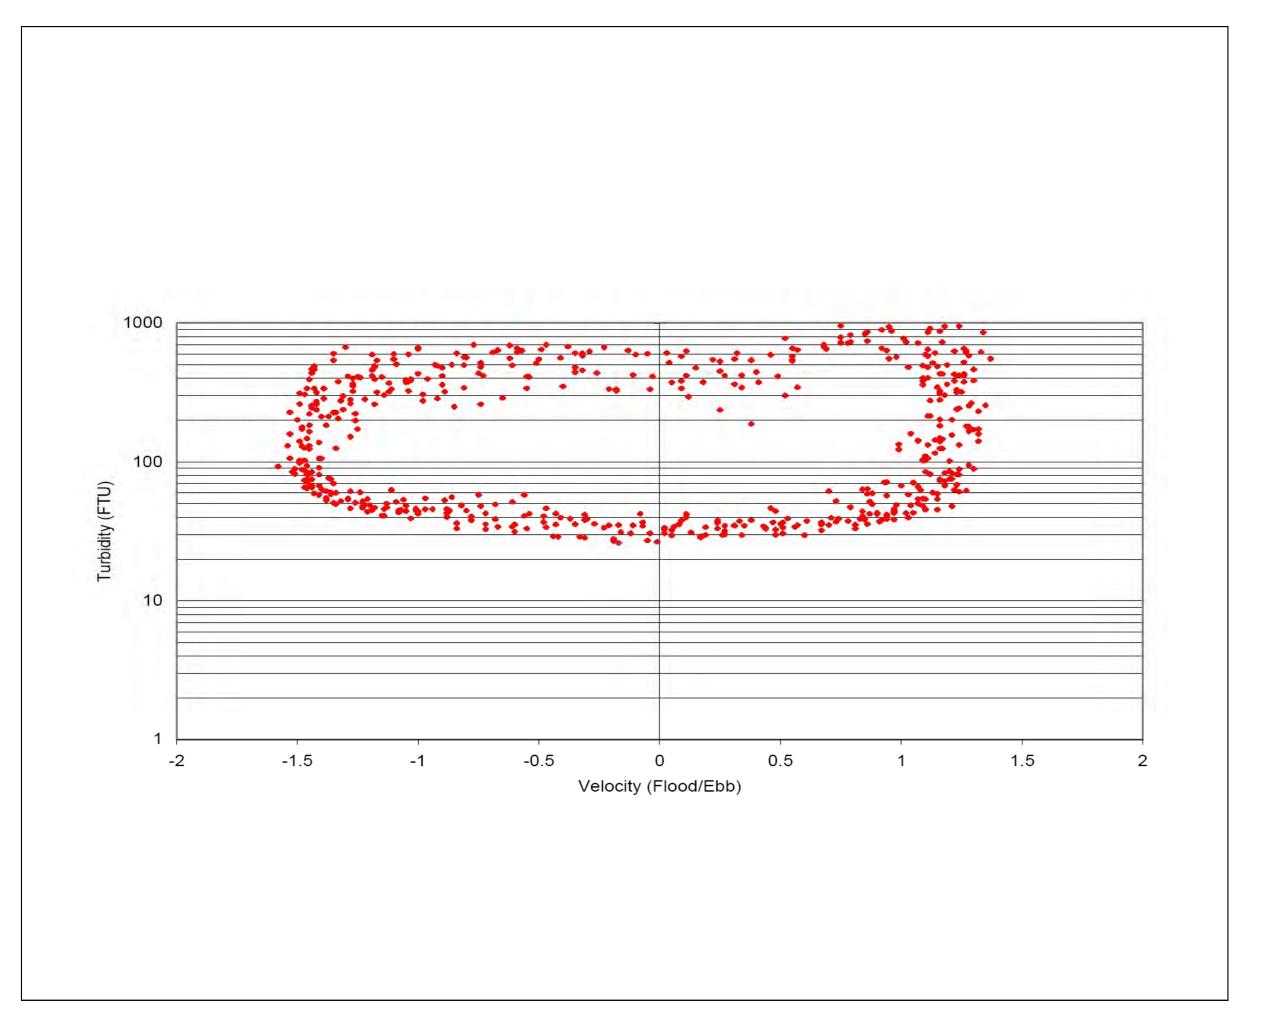









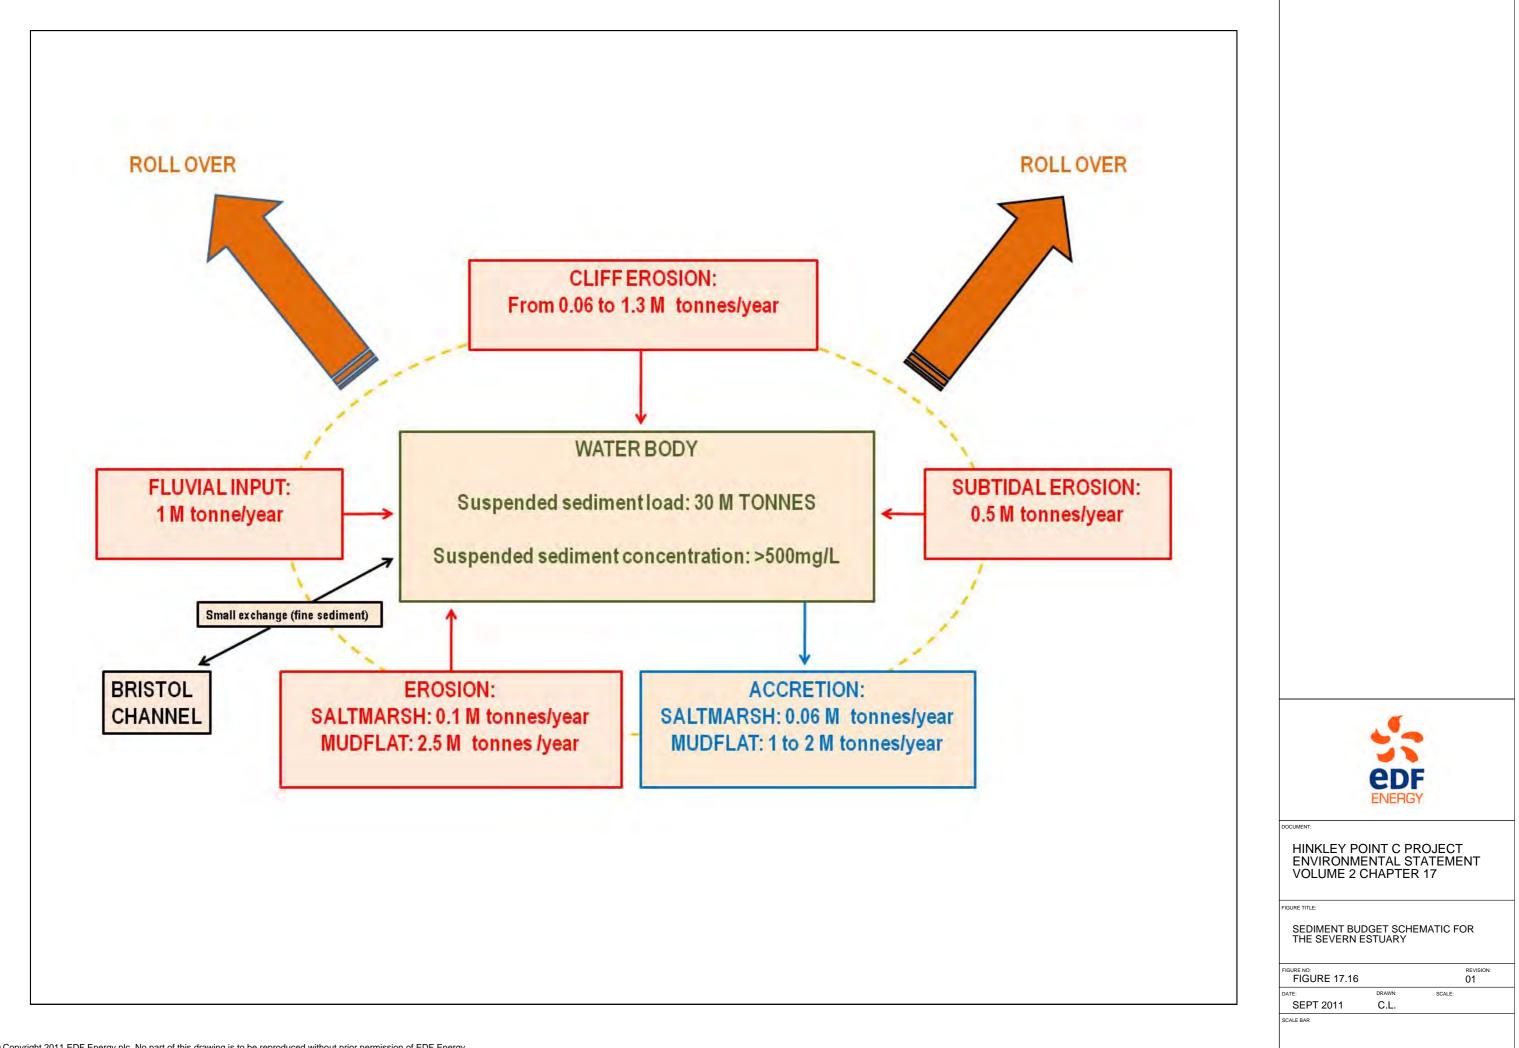
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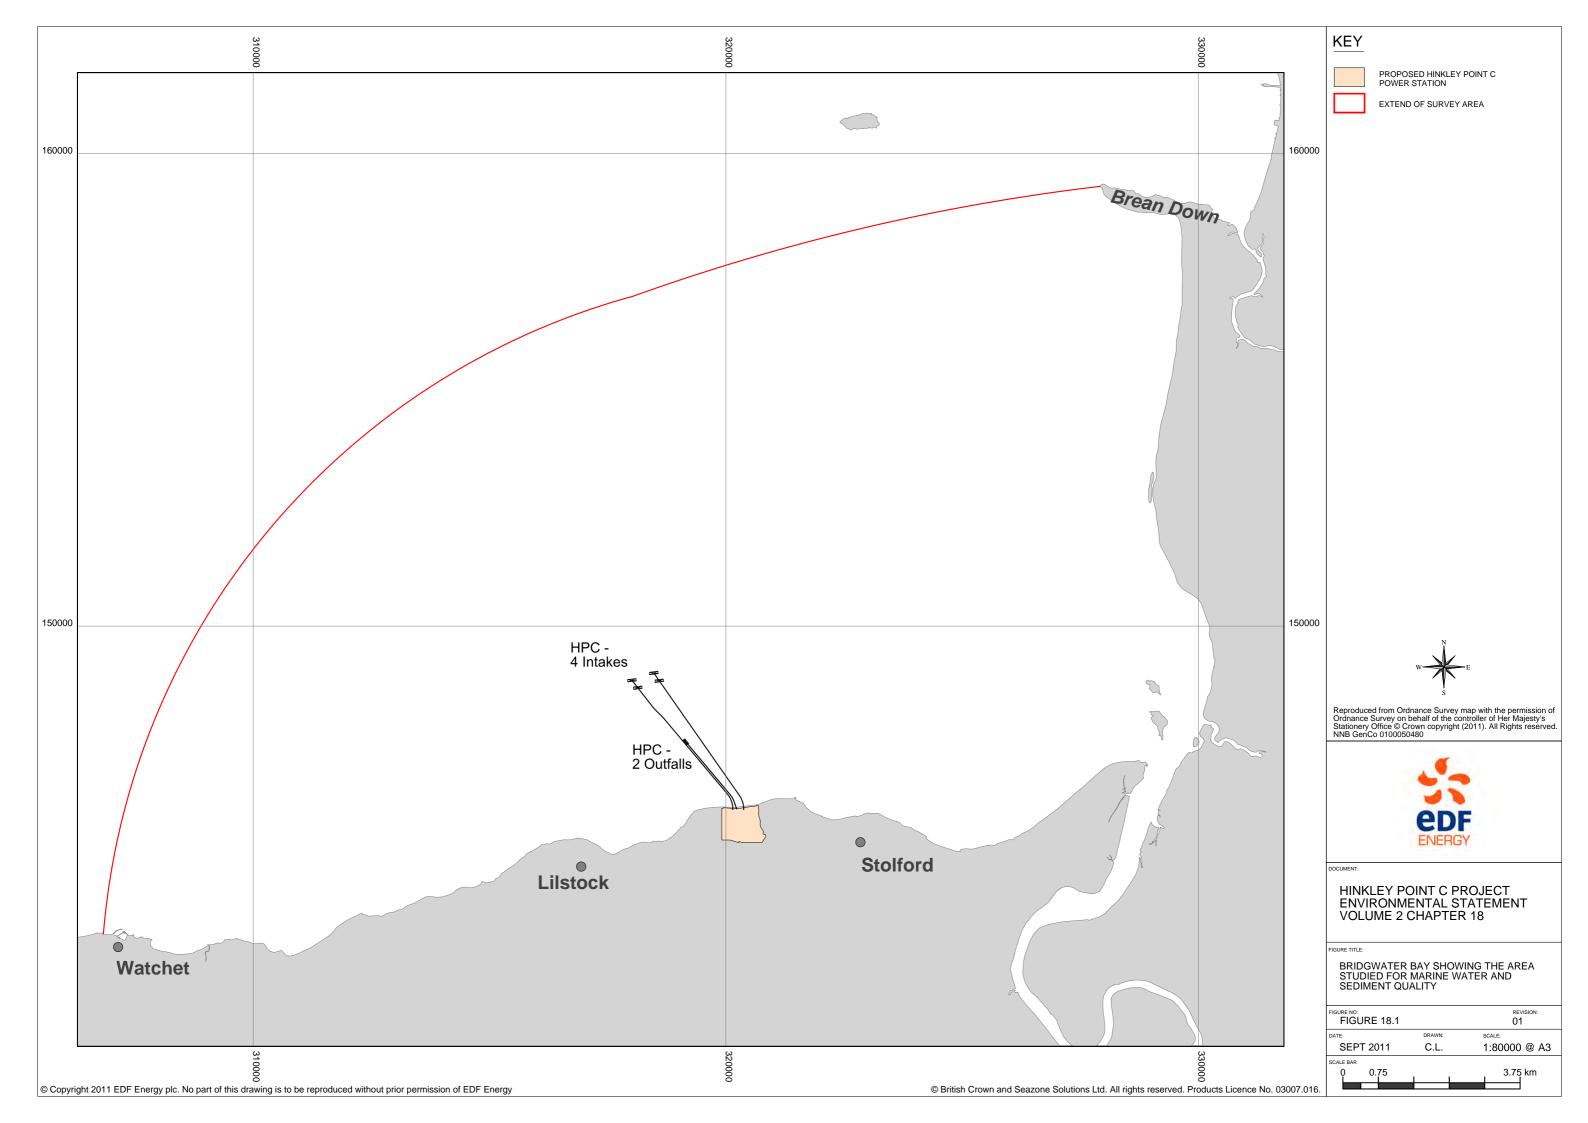
HINKLEY POINT C PROJECT ENVIRONMENTAL STATEMENT VOLUME 2 CHAPTER 17


FIGURE TITL


SUSPENDED SEDIMENT HYSTERESIS -TURBIDITY (FTU) VS SPEED (m/s) - SPRING TIDES AT SITE H6 (SEE FIGURE 17.2)


FIGURE 17.15			REVISION:	
	DRAWN:	SCALE:		
SEPT 2011	C.L.			
E BAR				







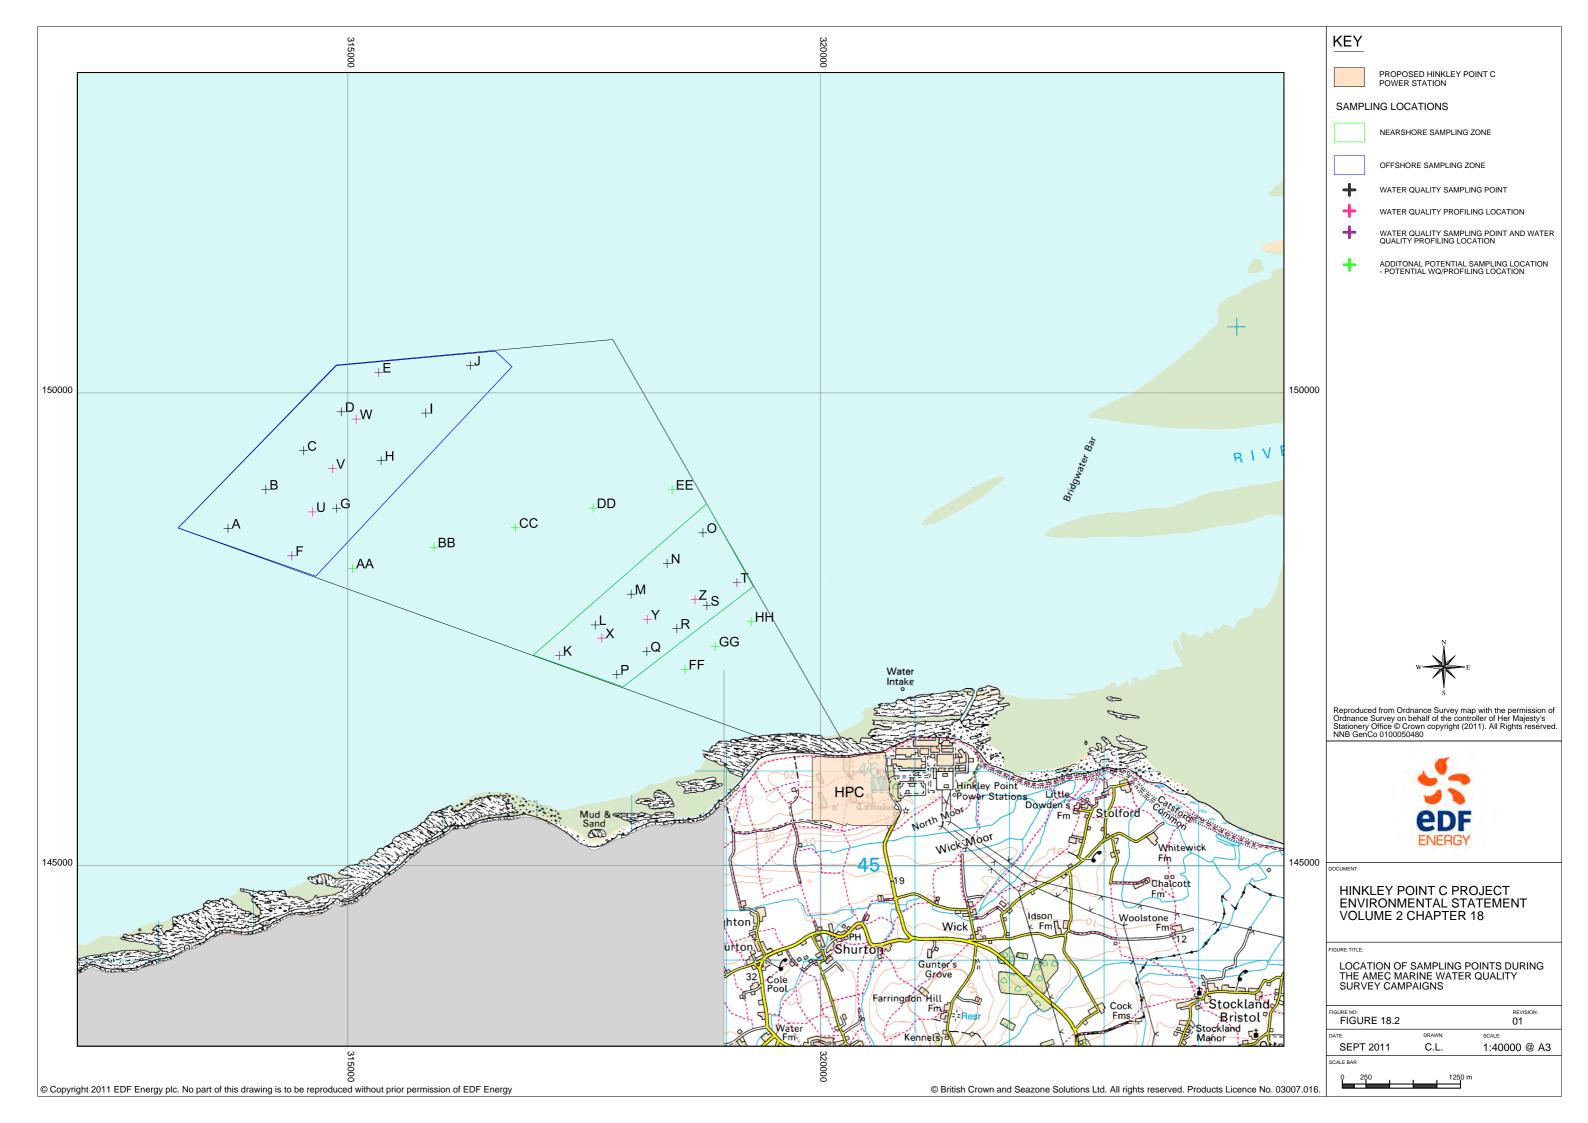


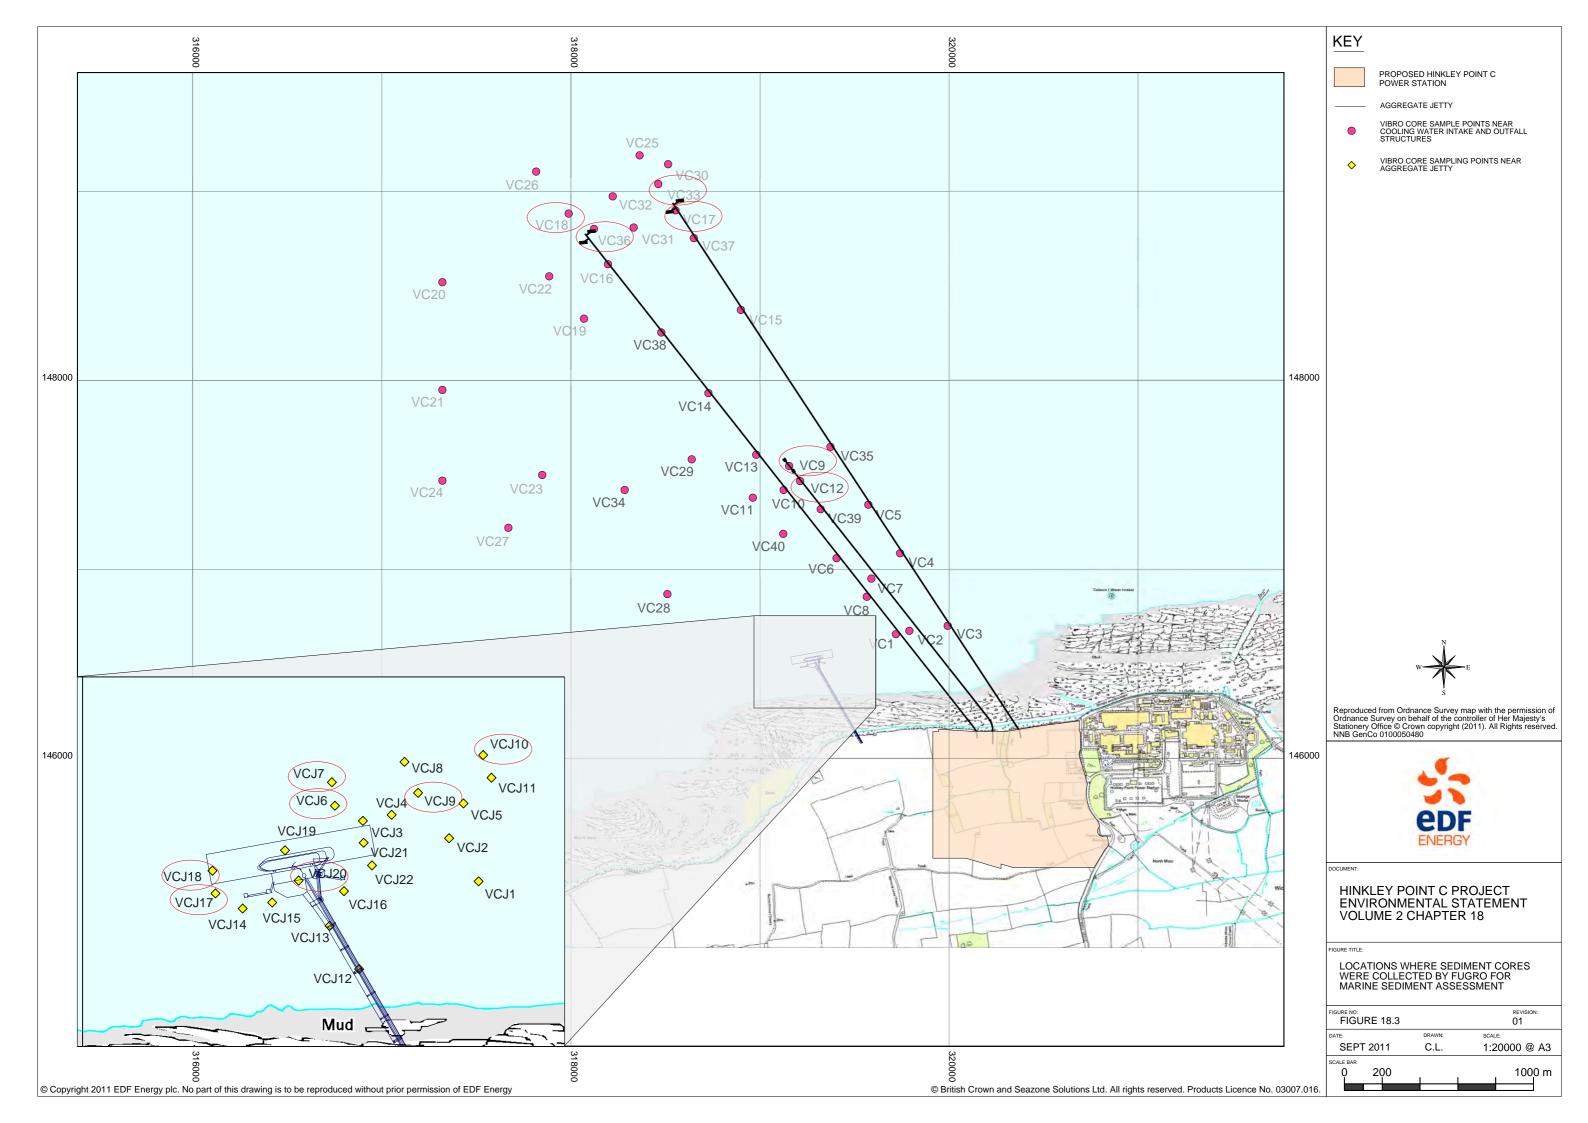


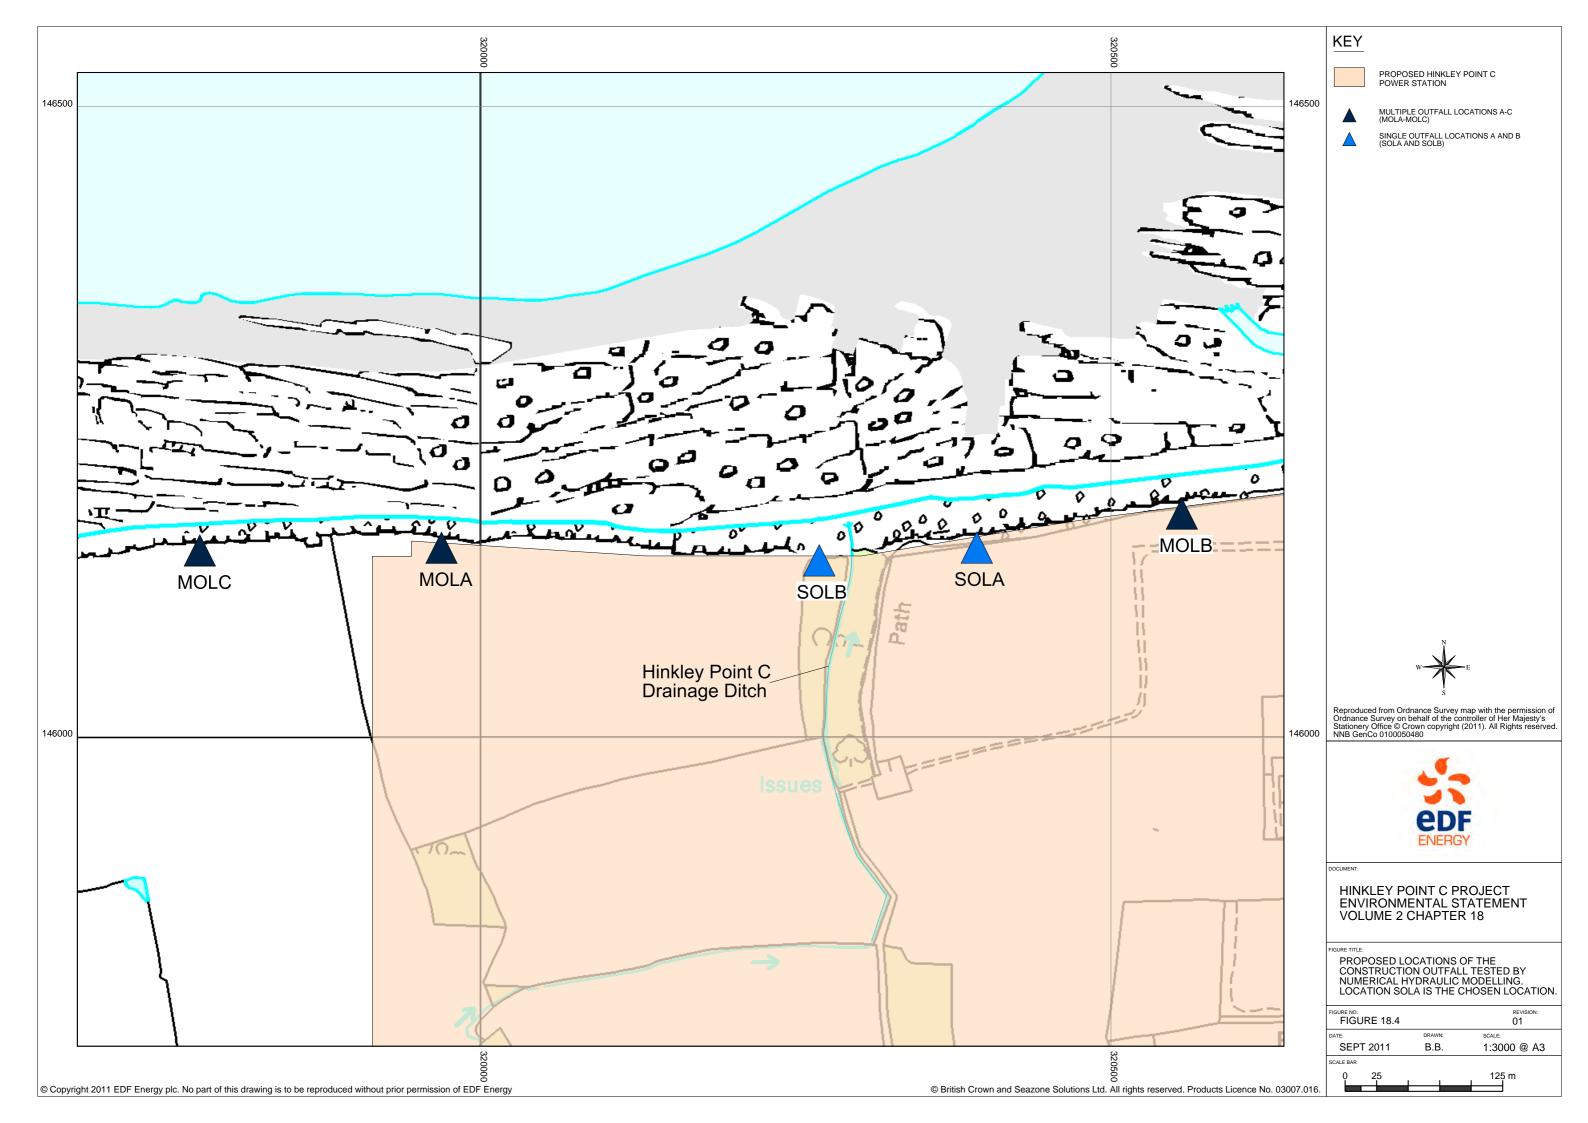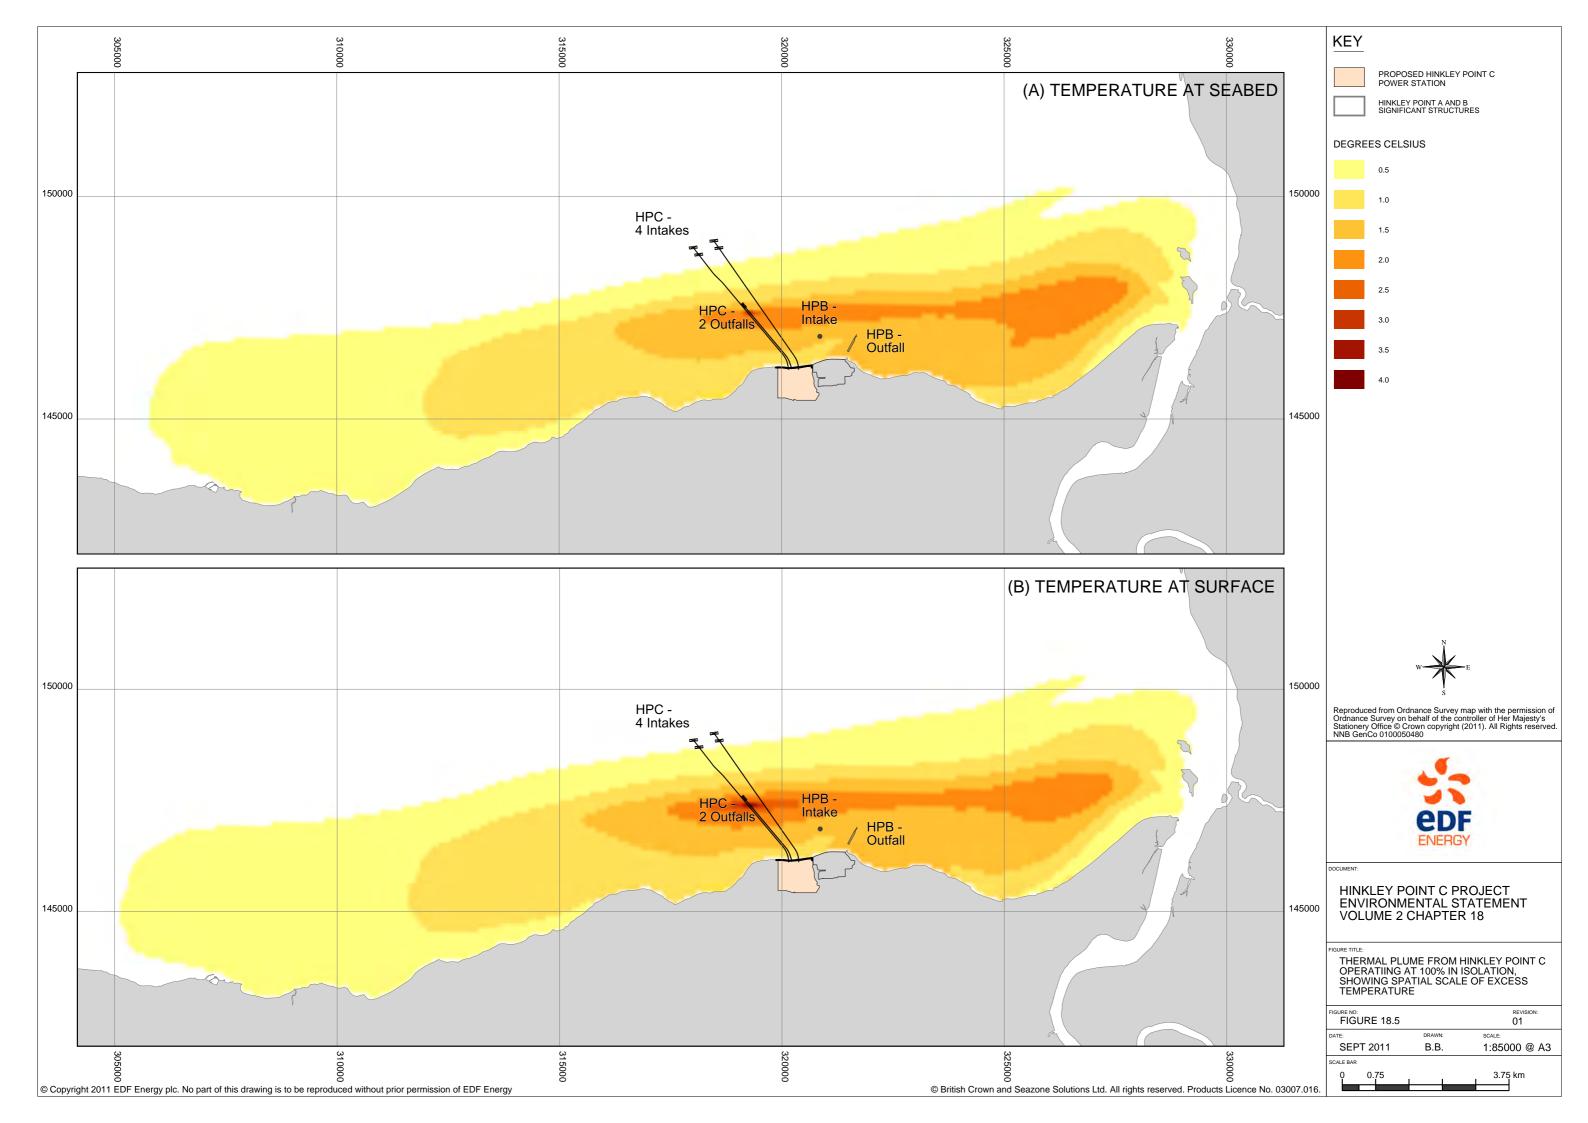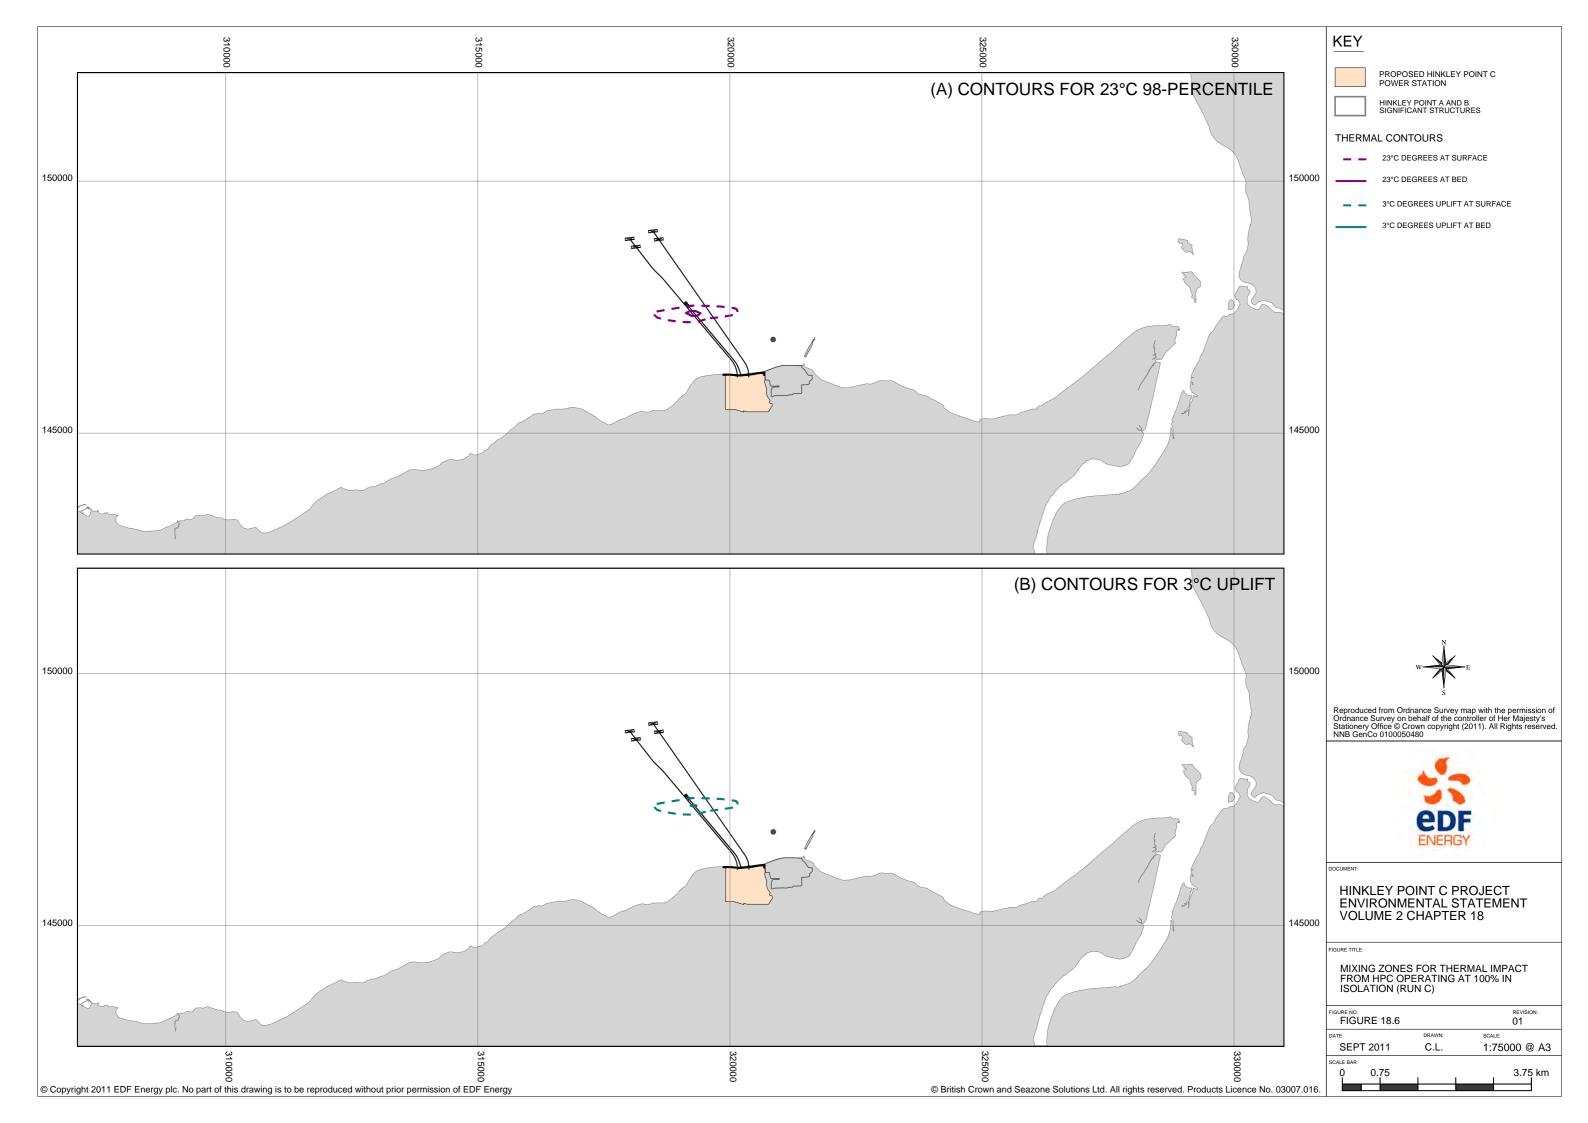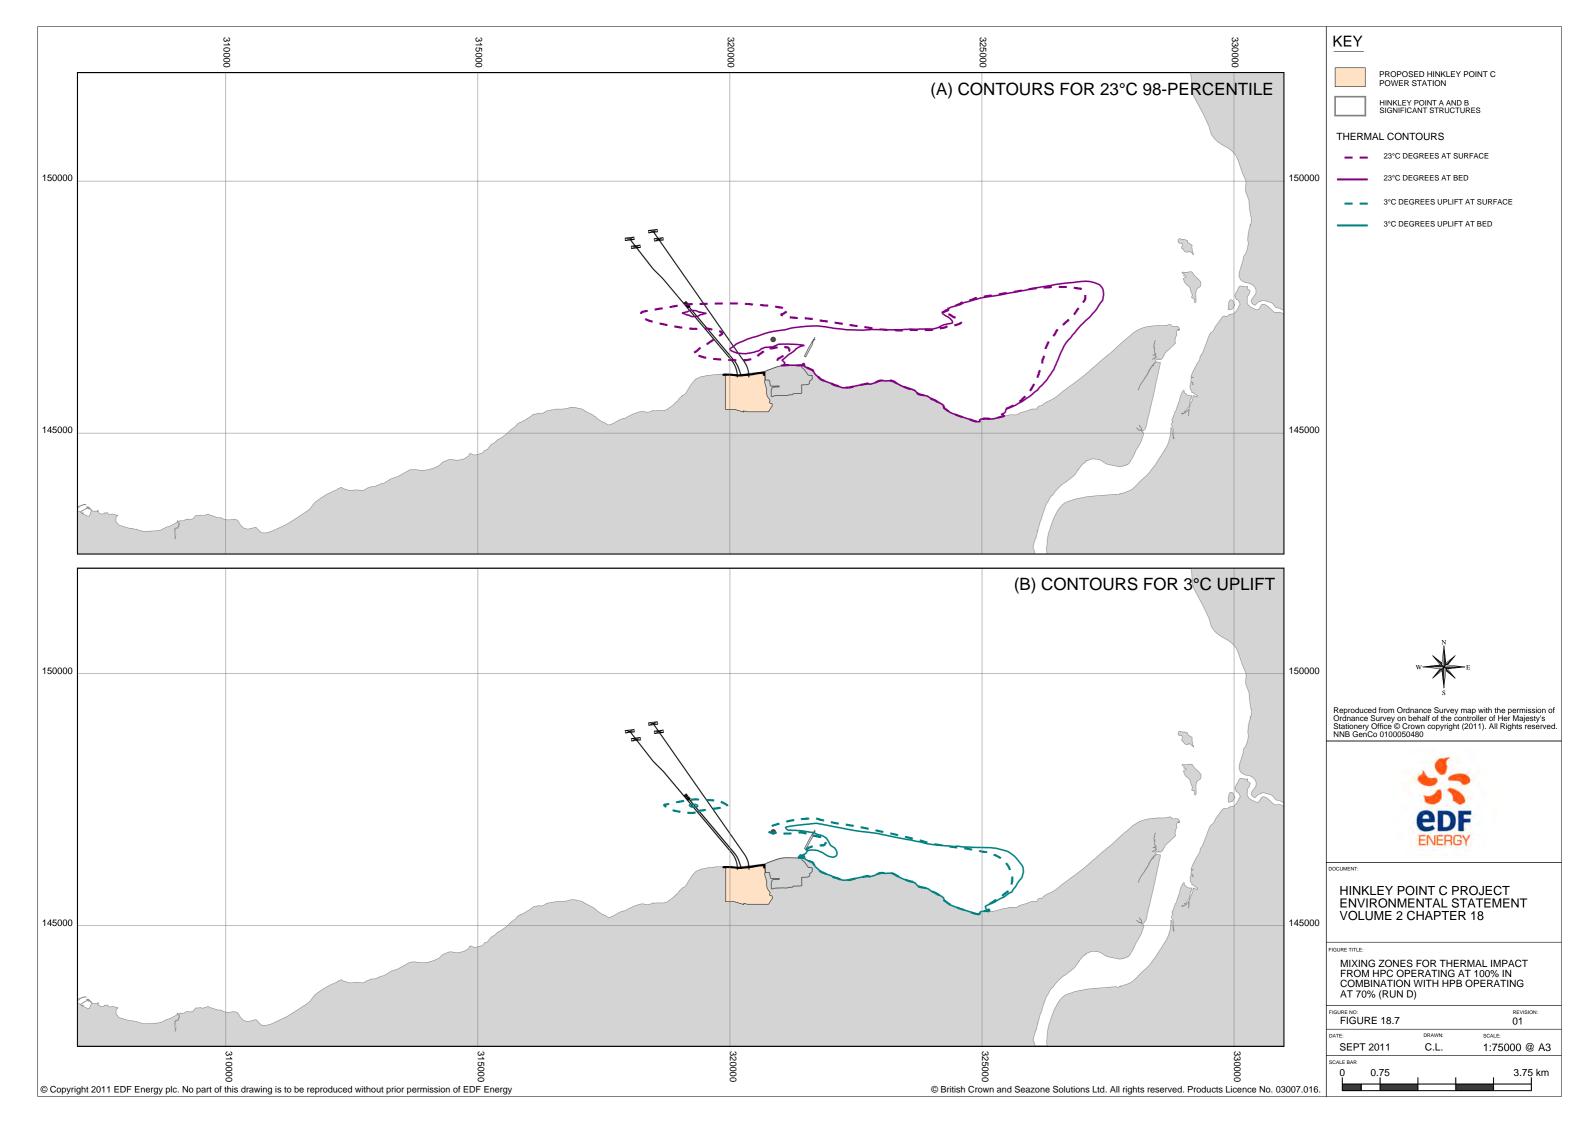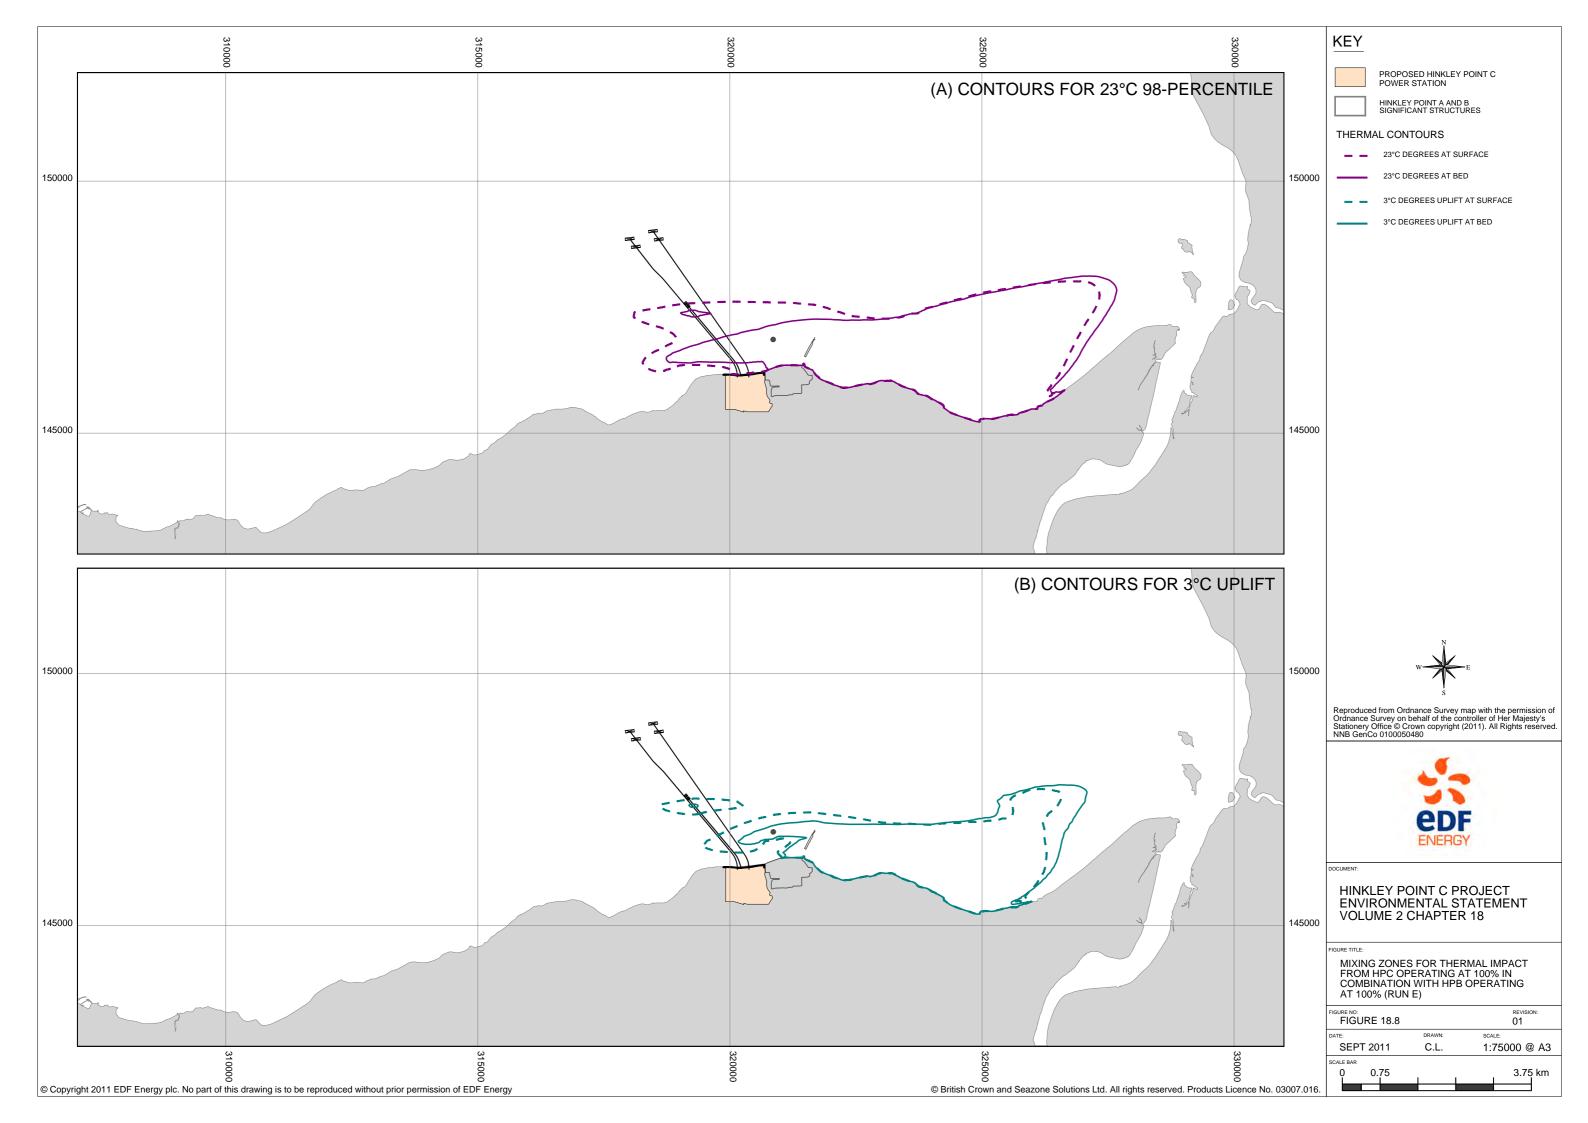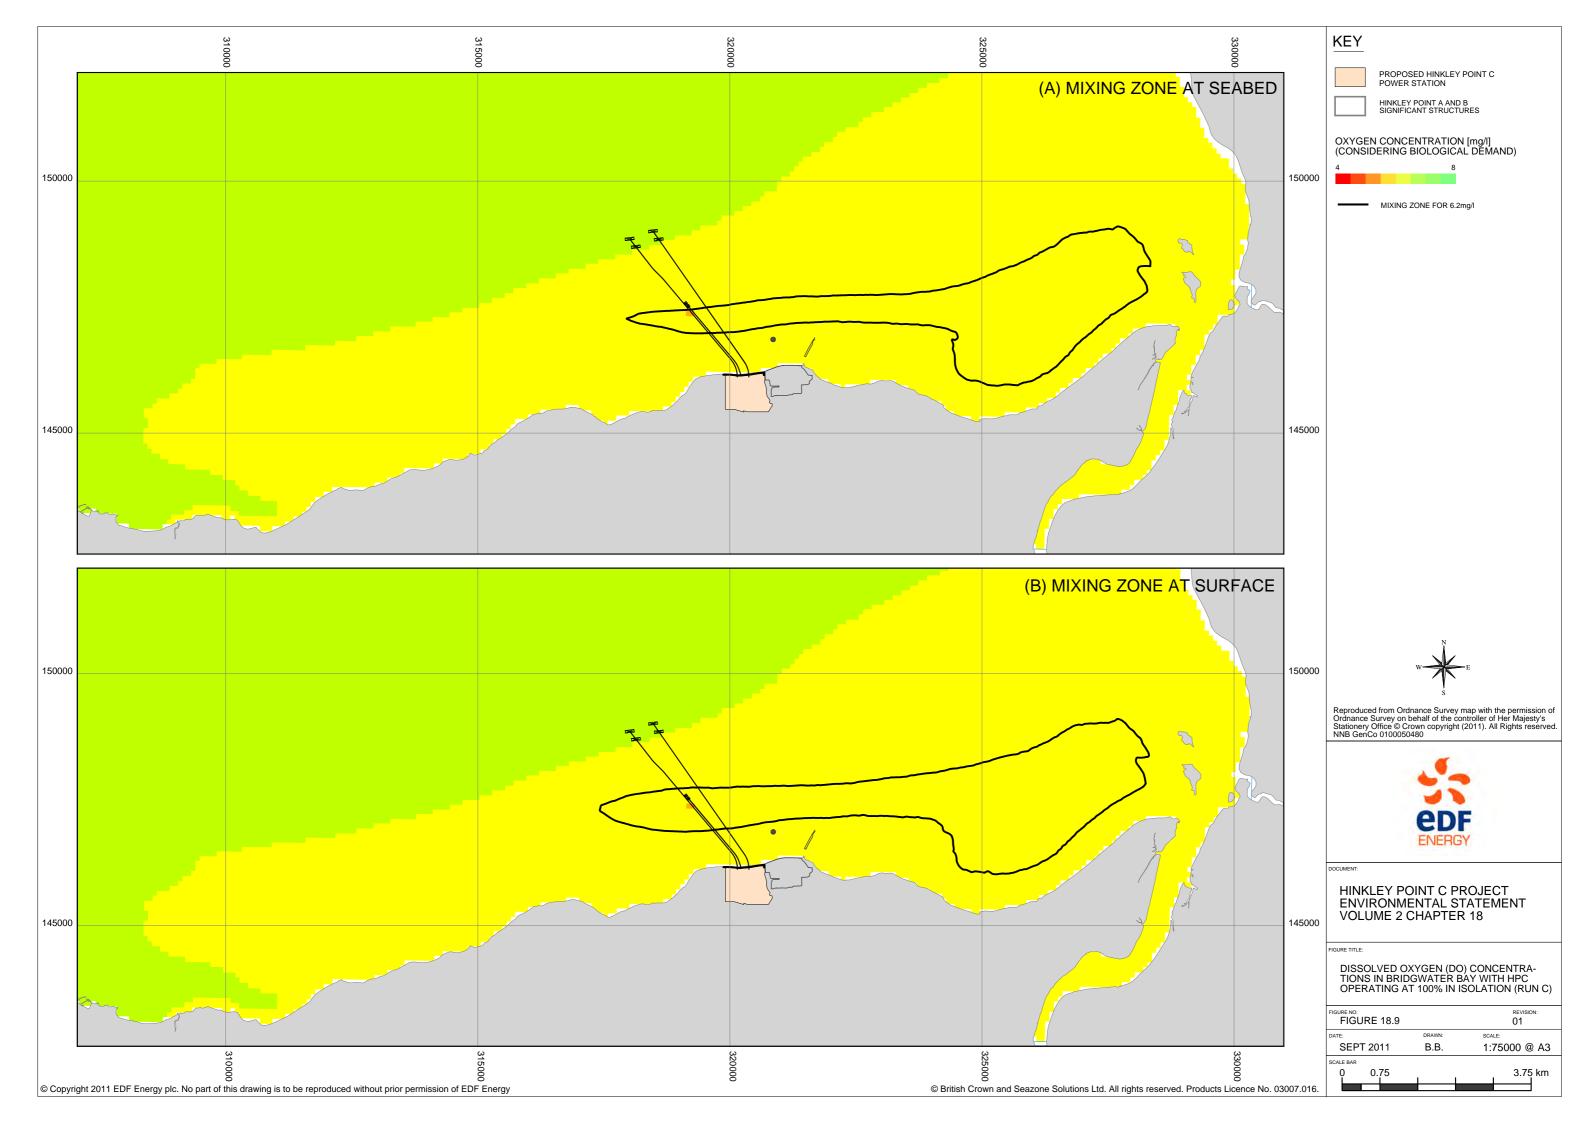


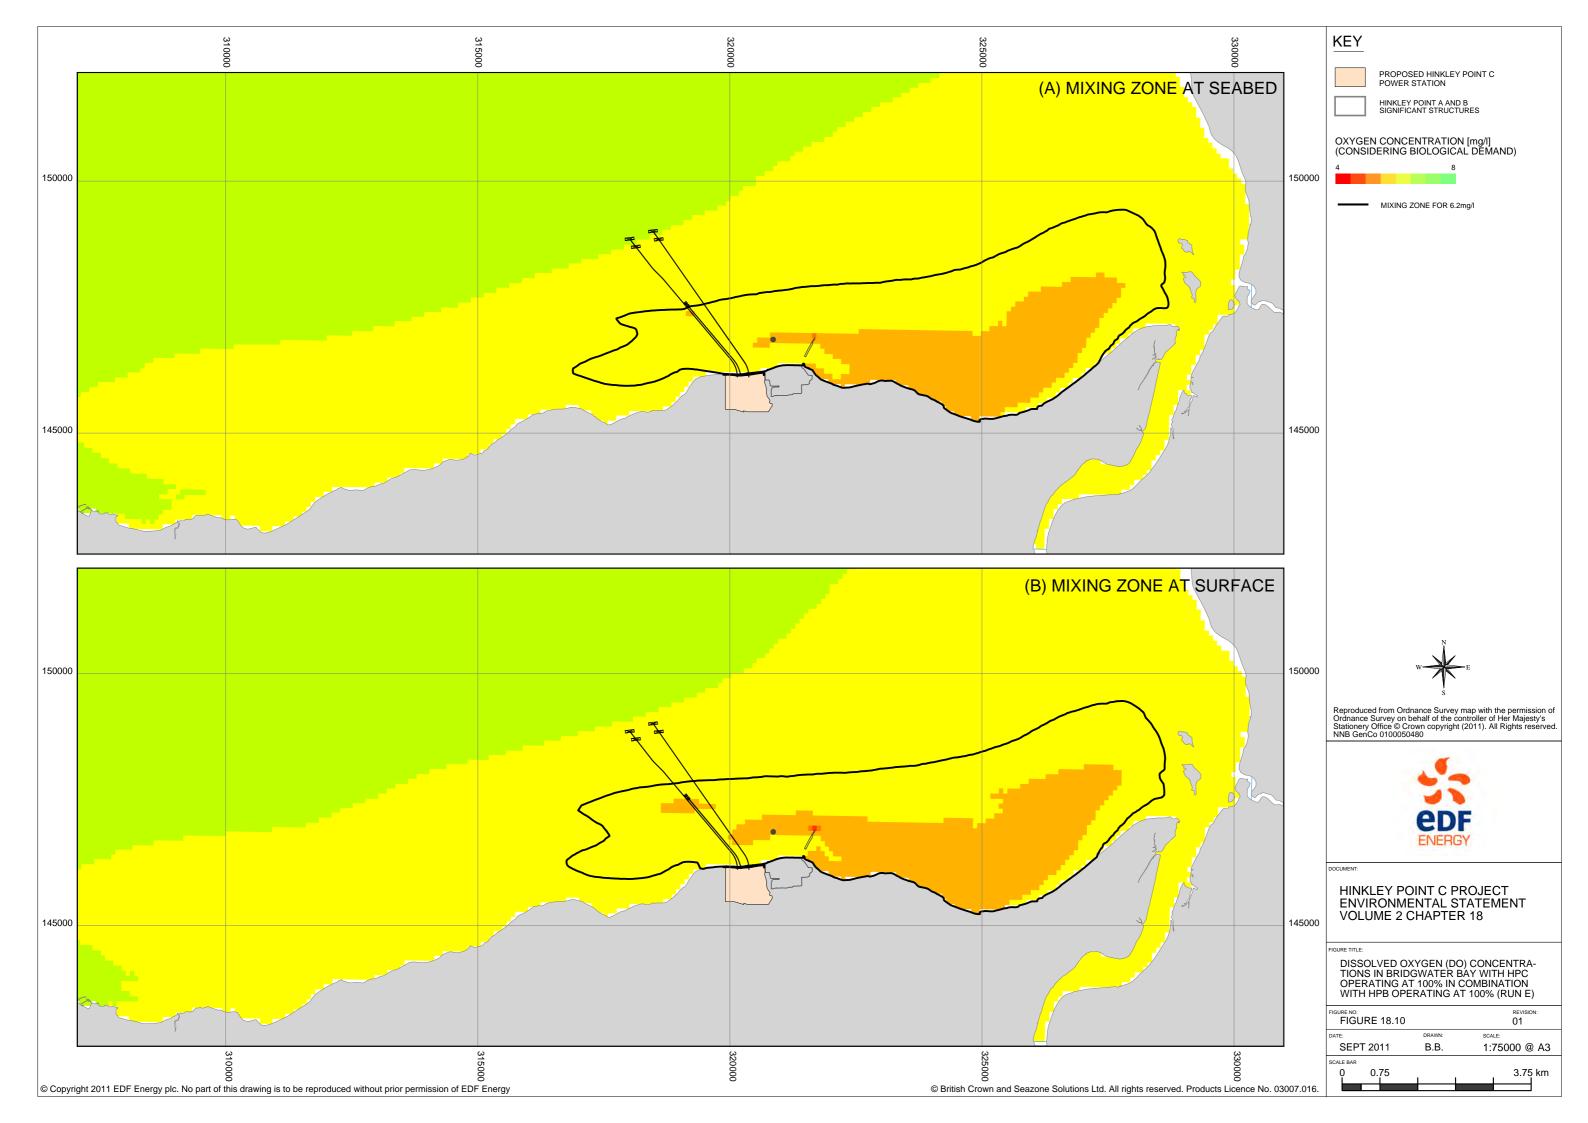


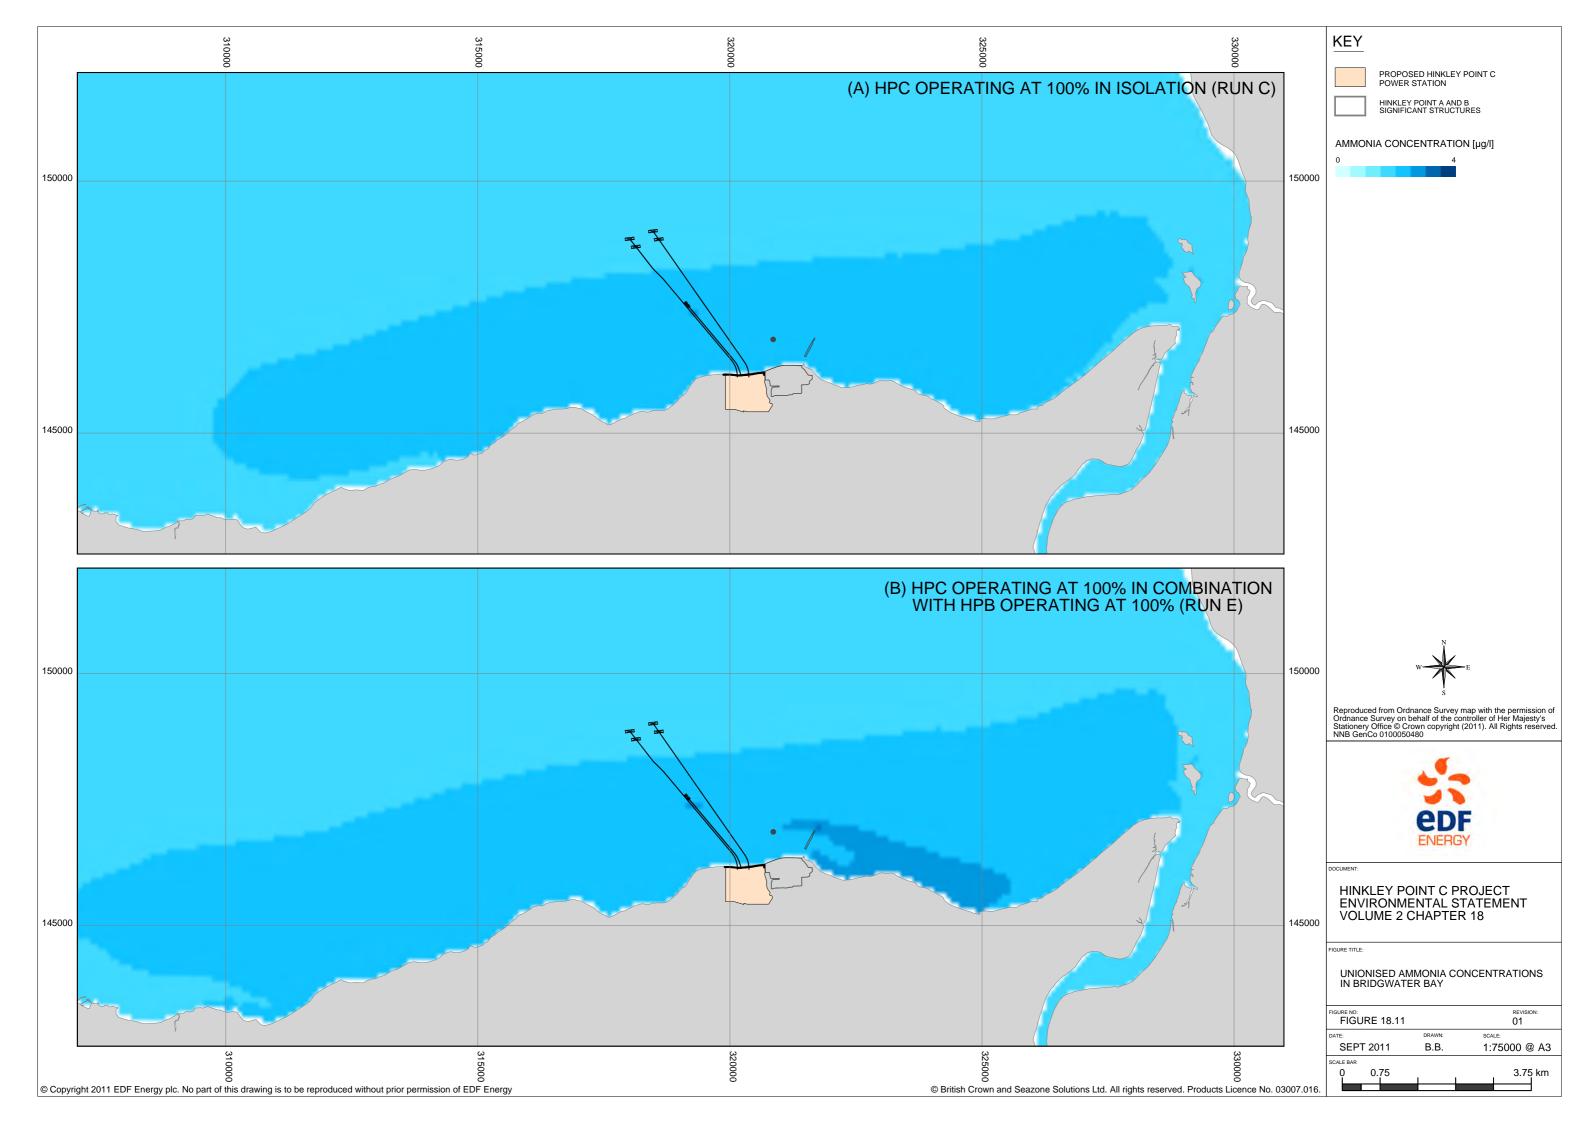


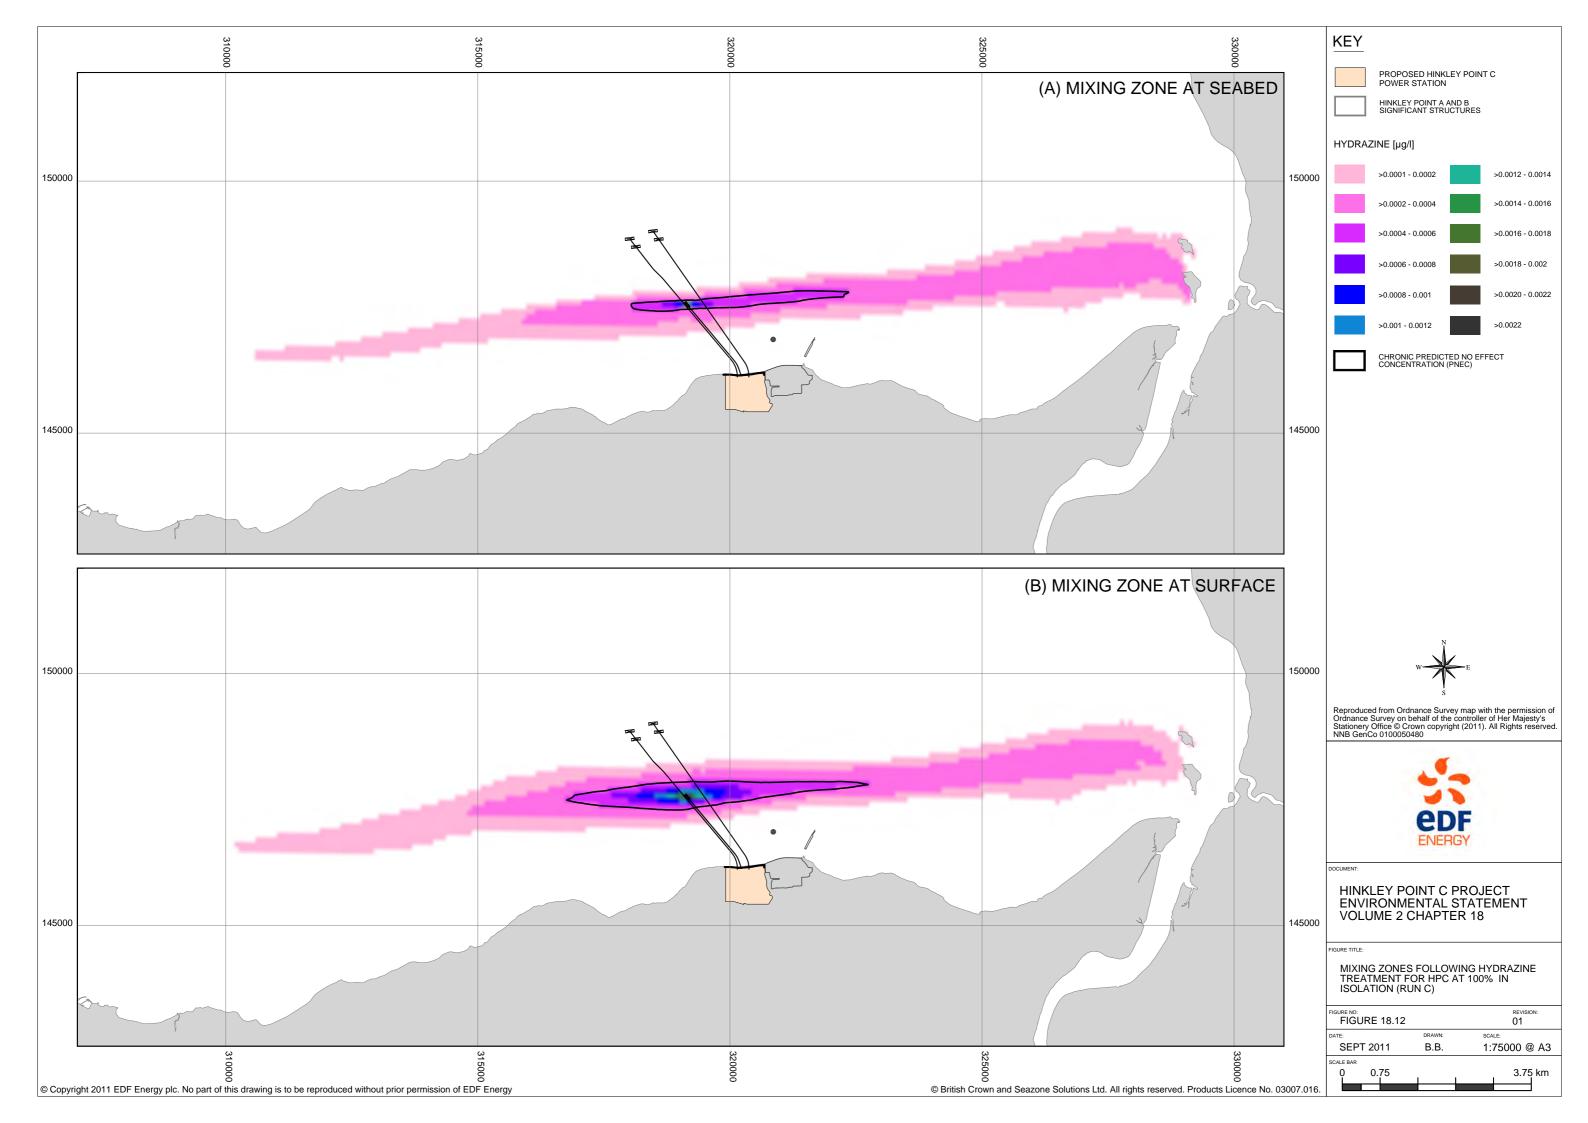


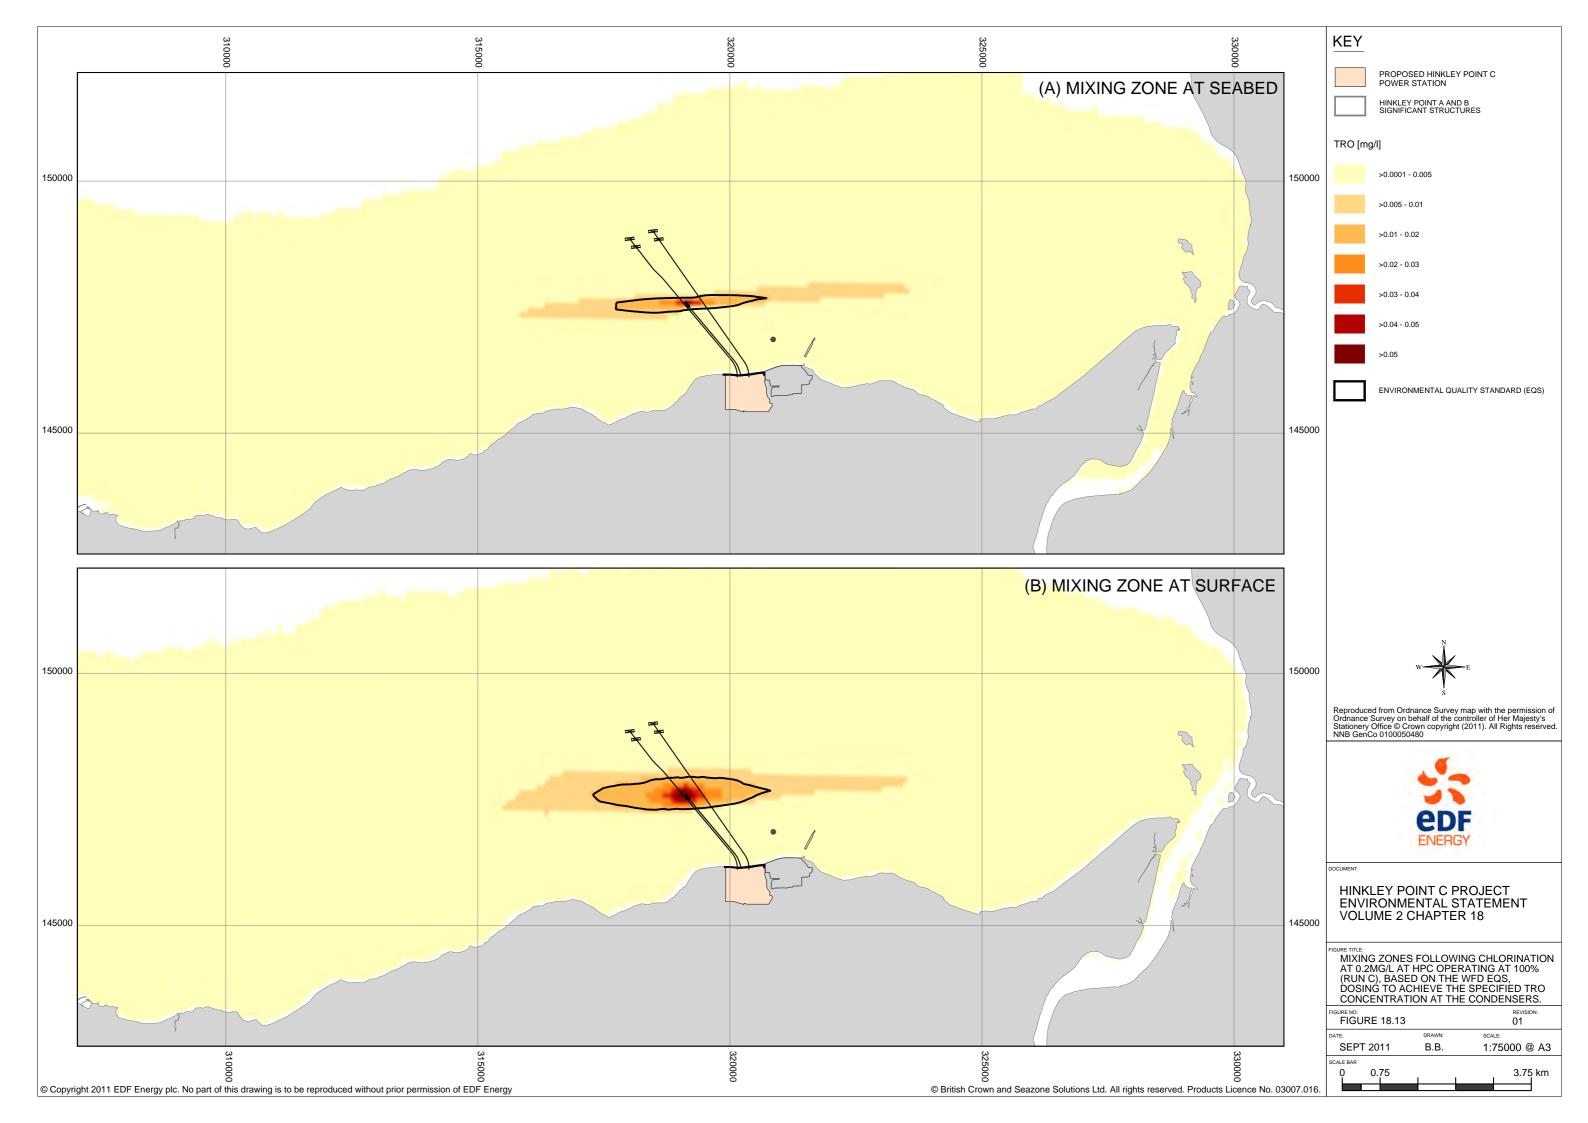


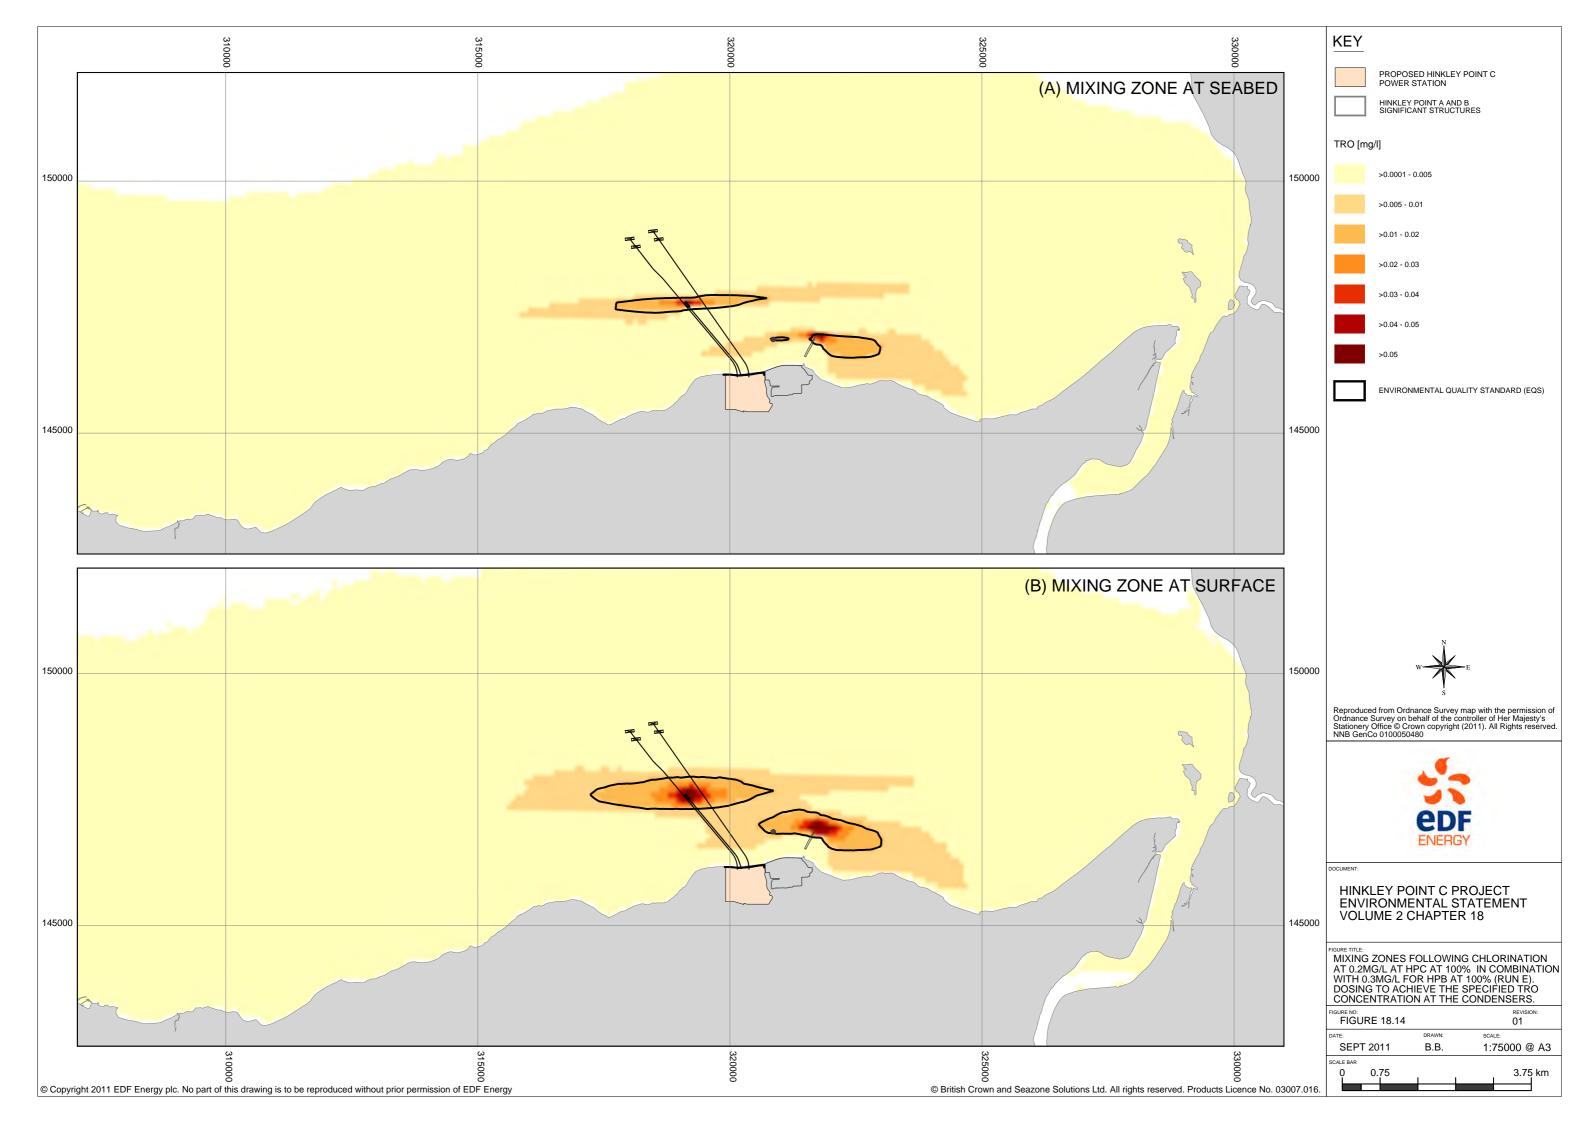


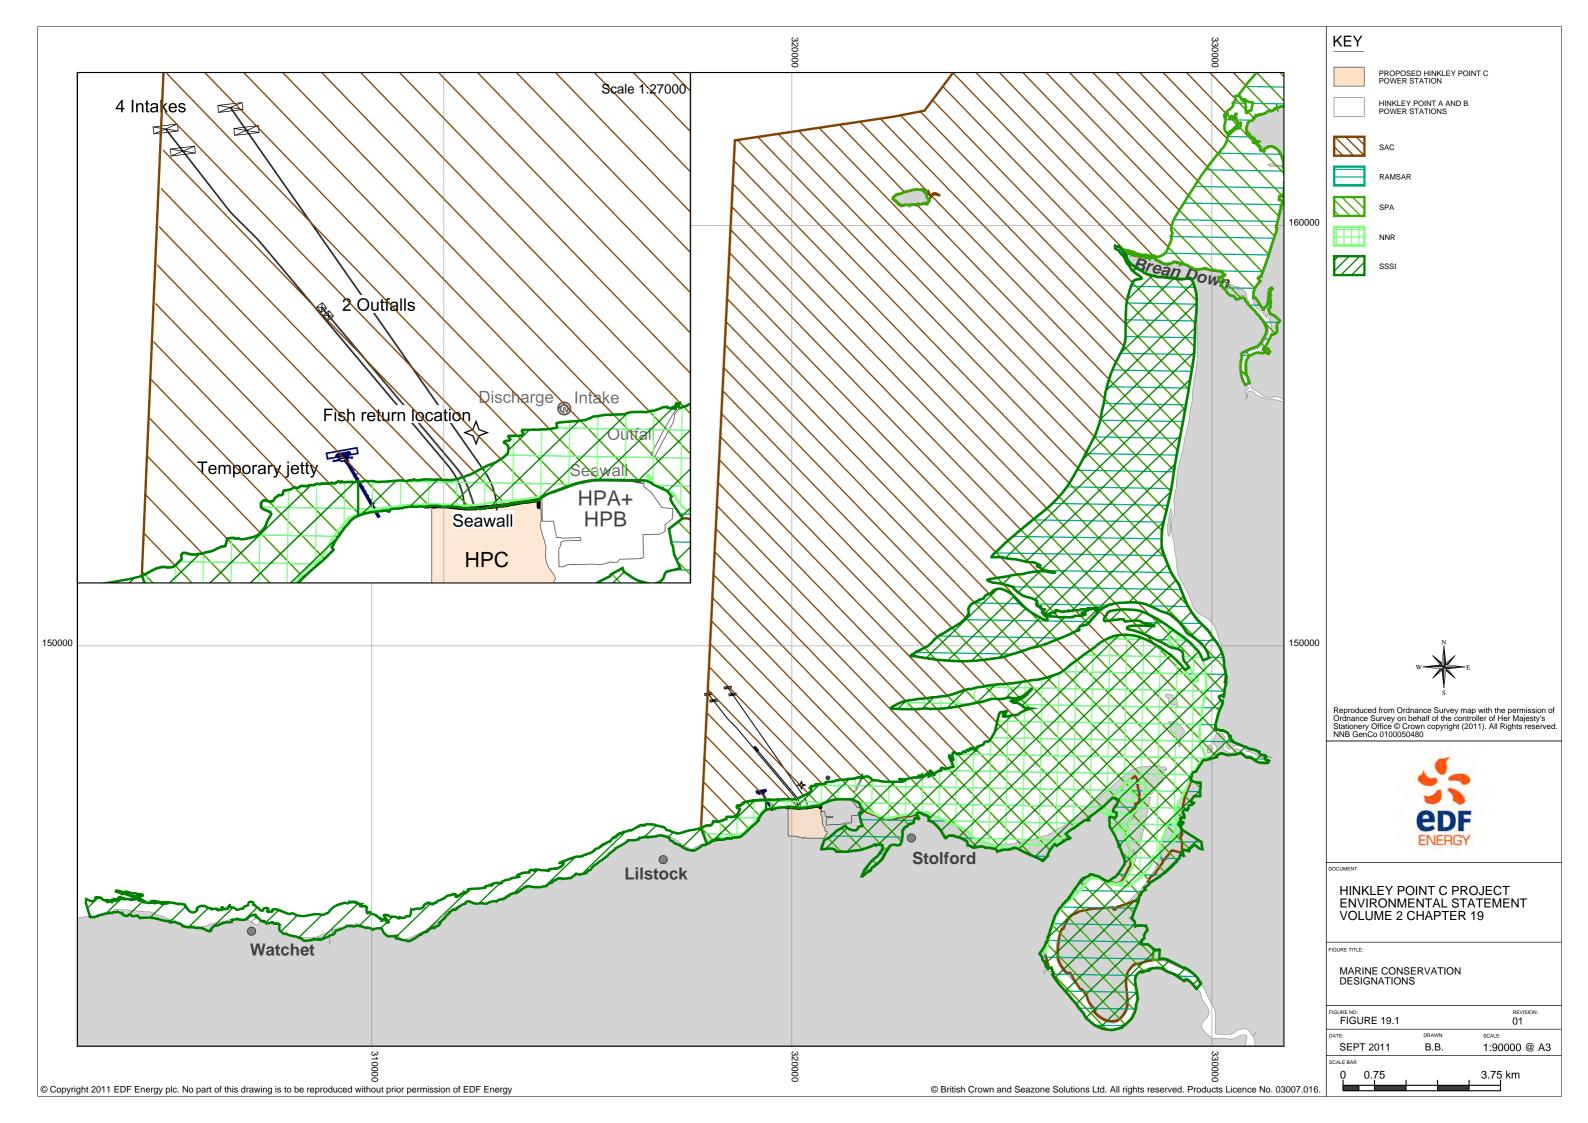


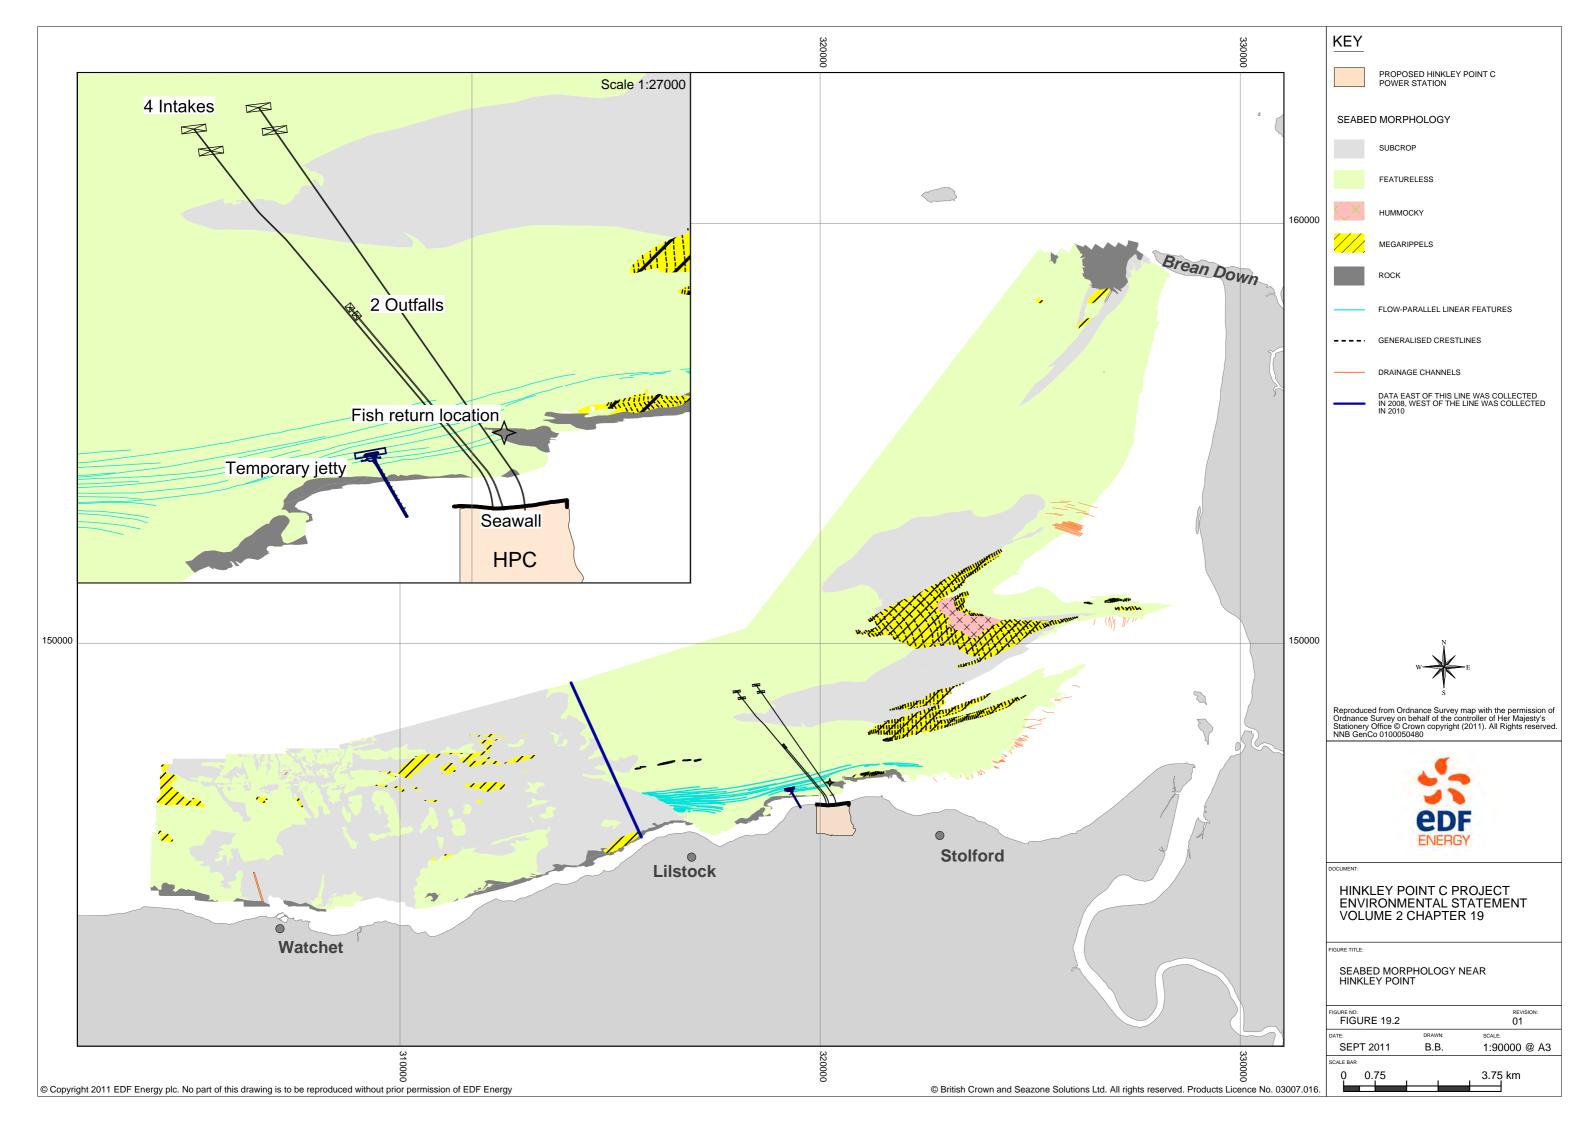


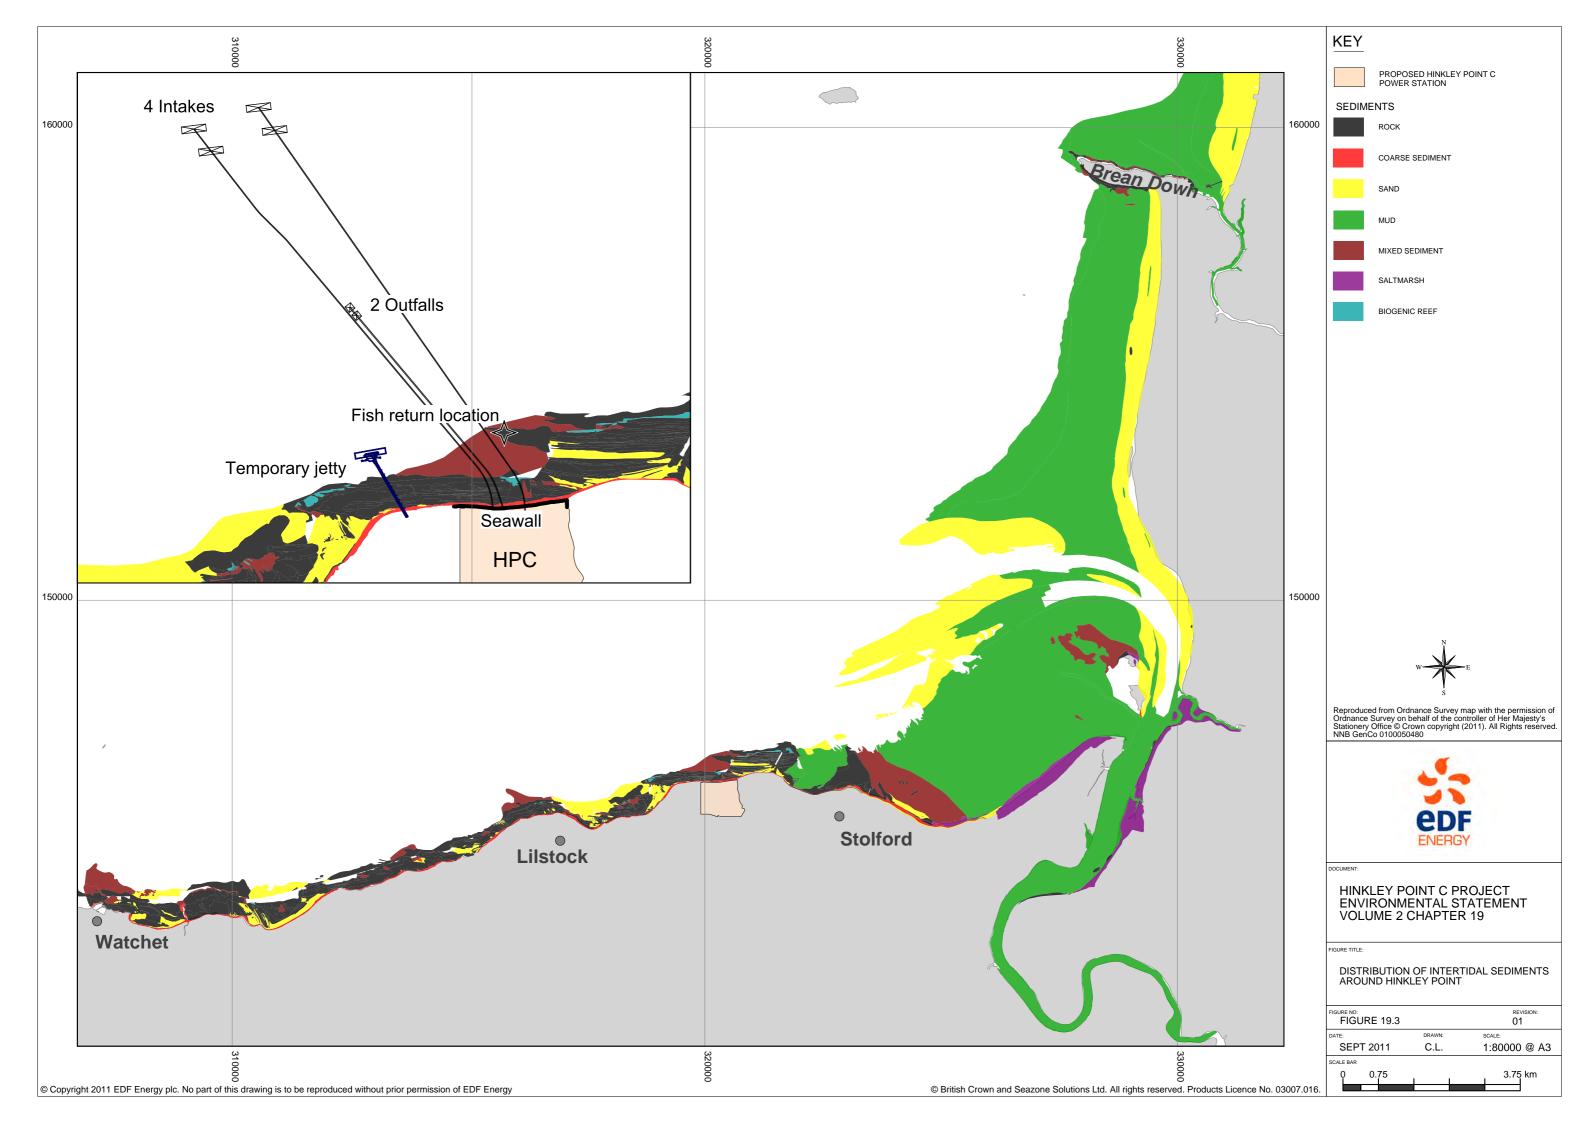


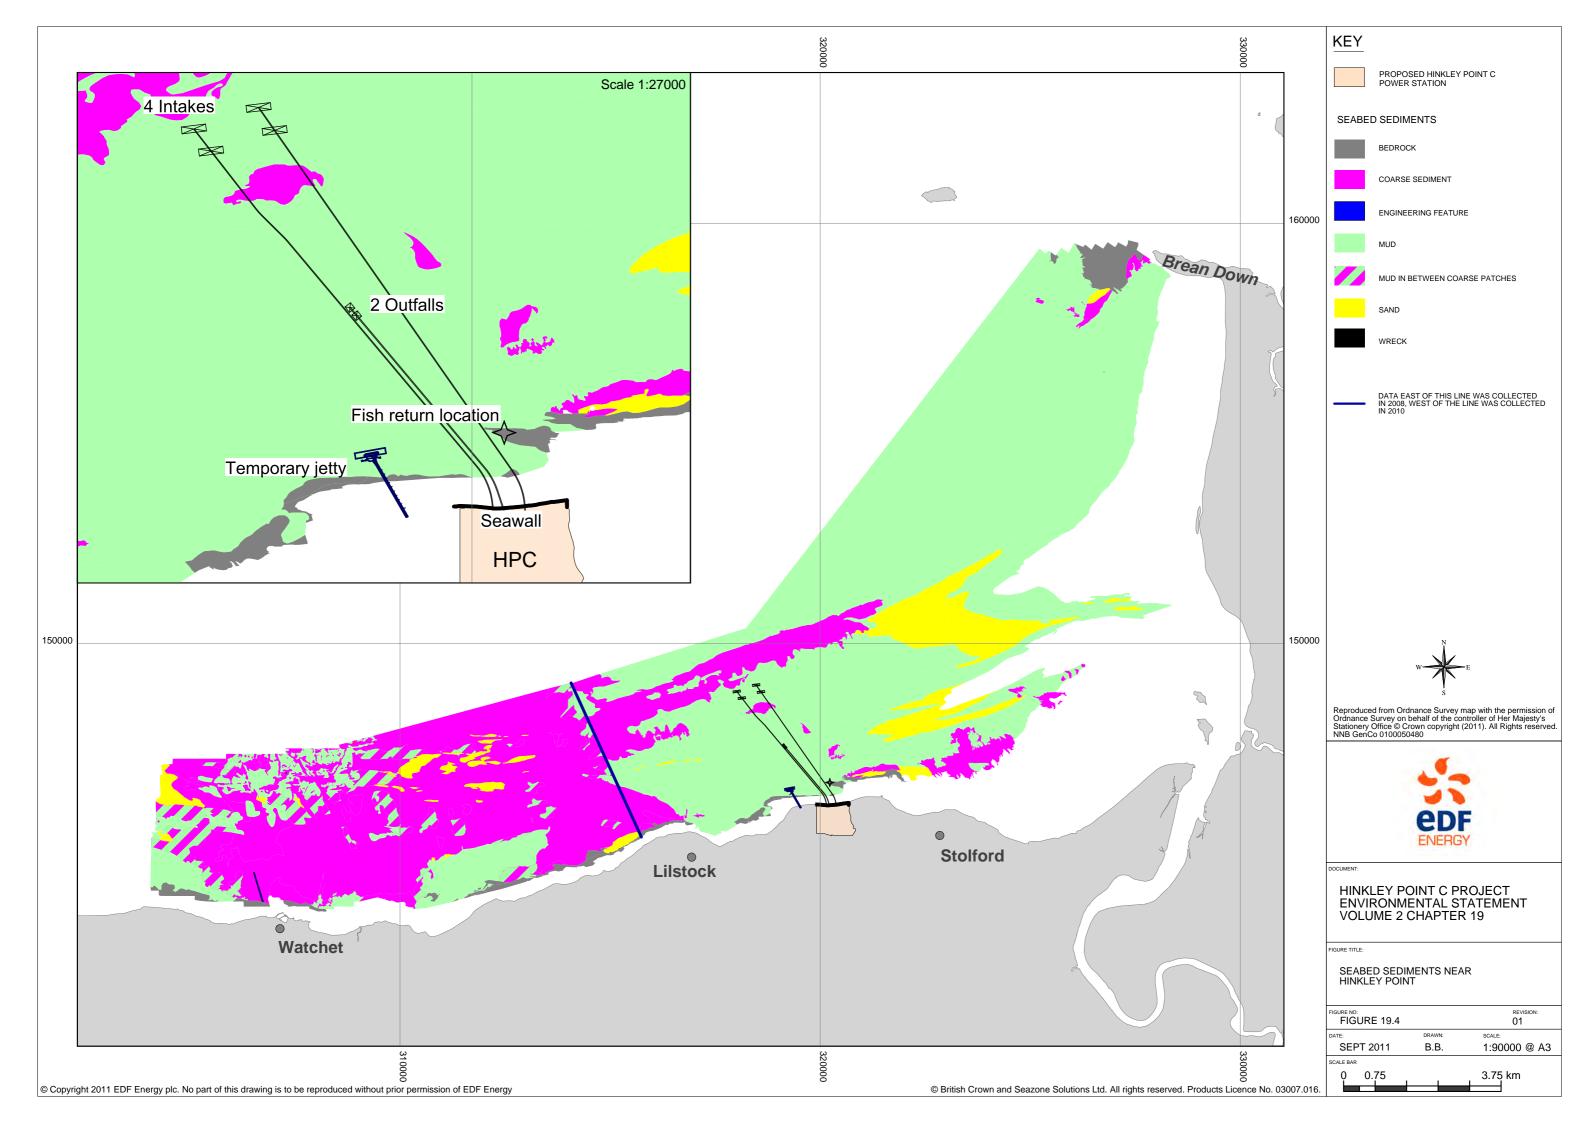


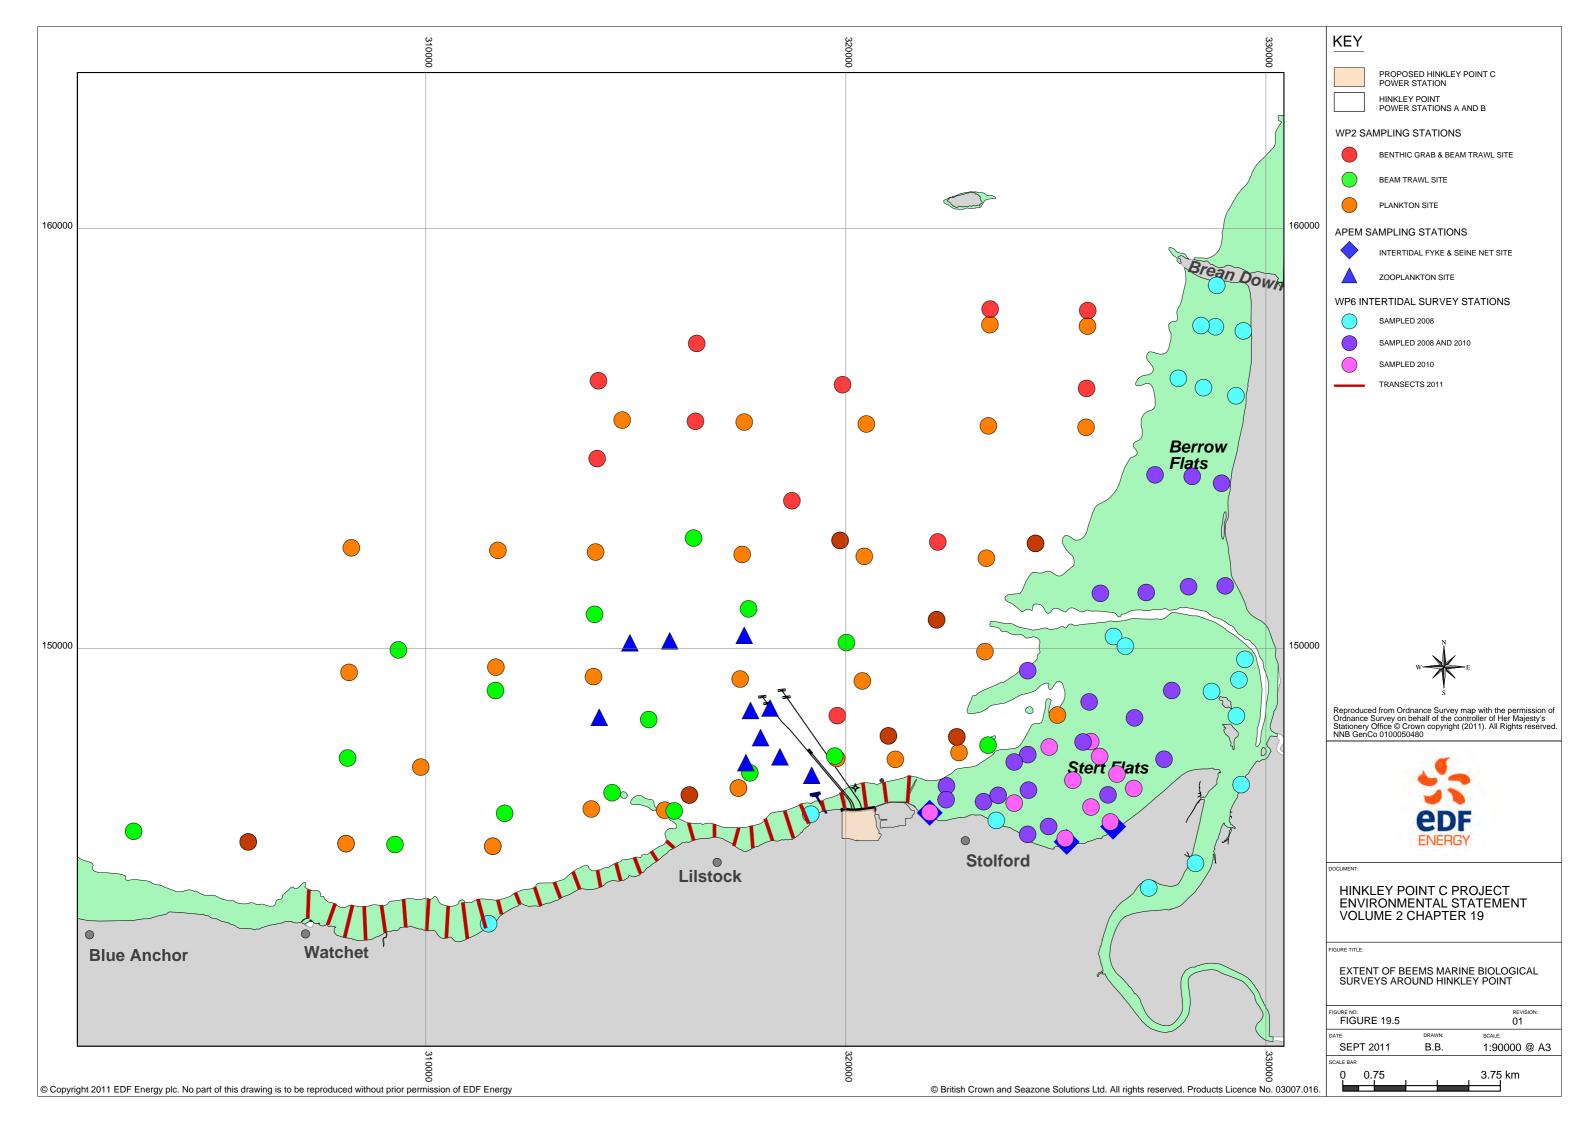


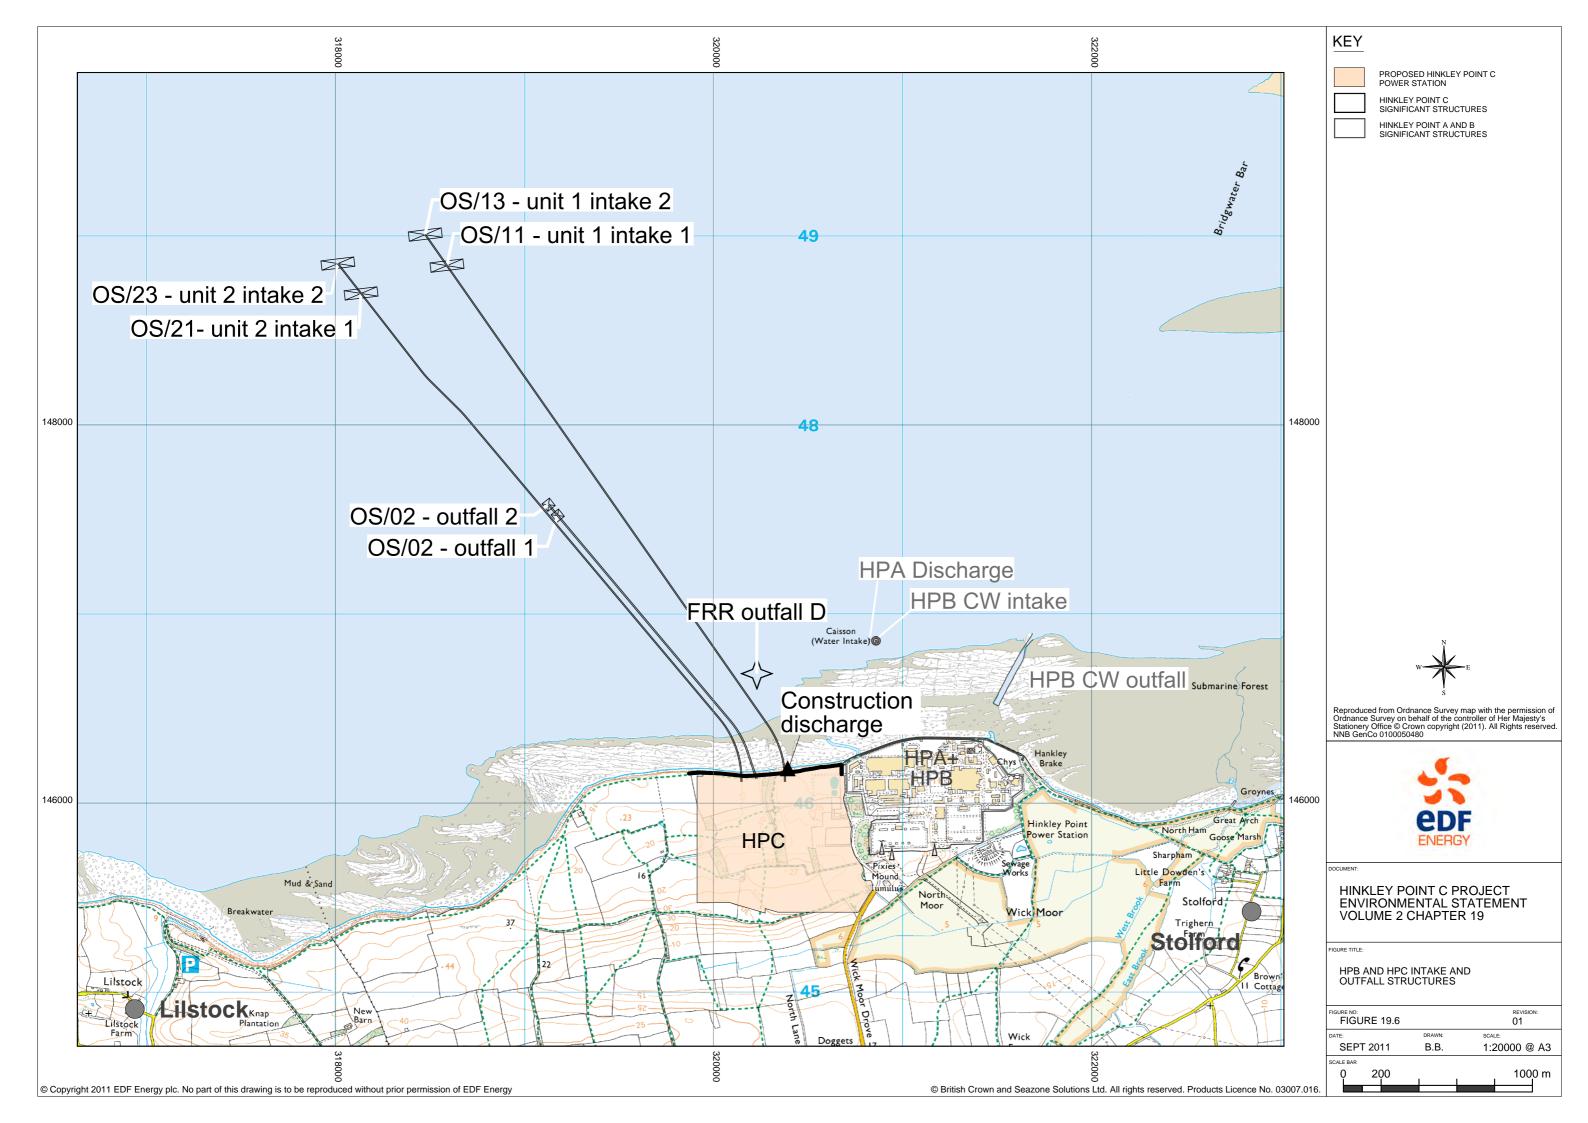


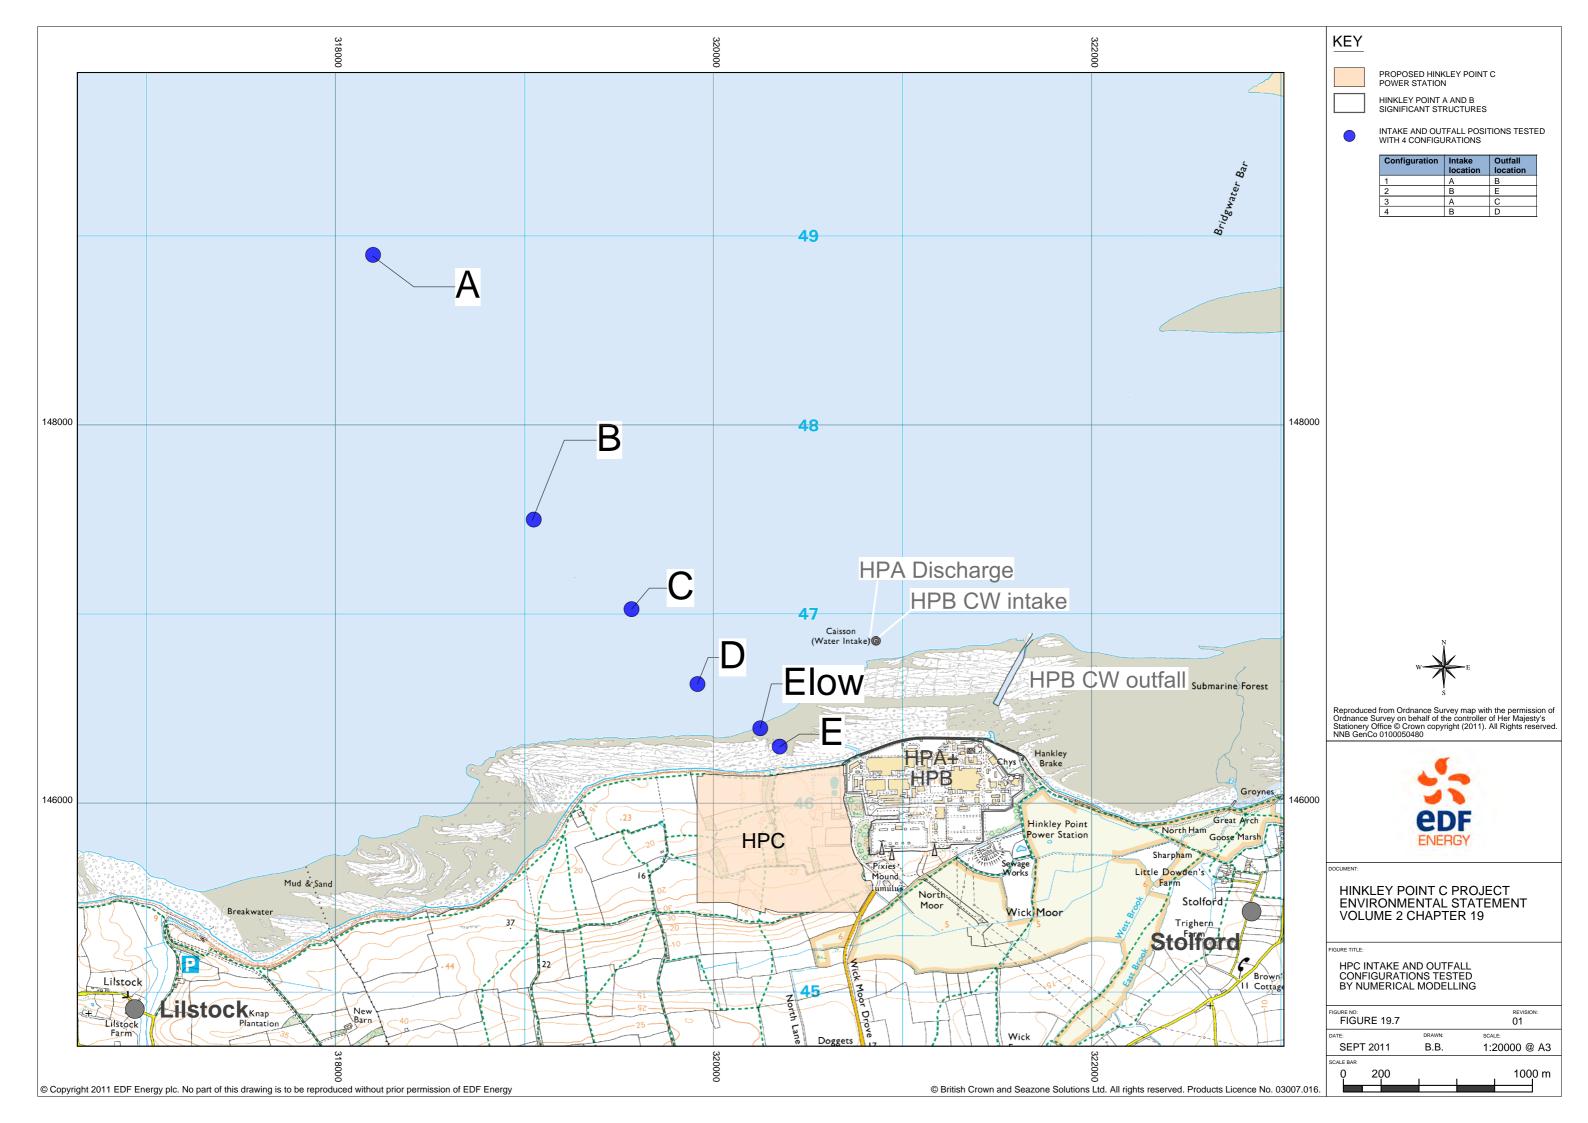


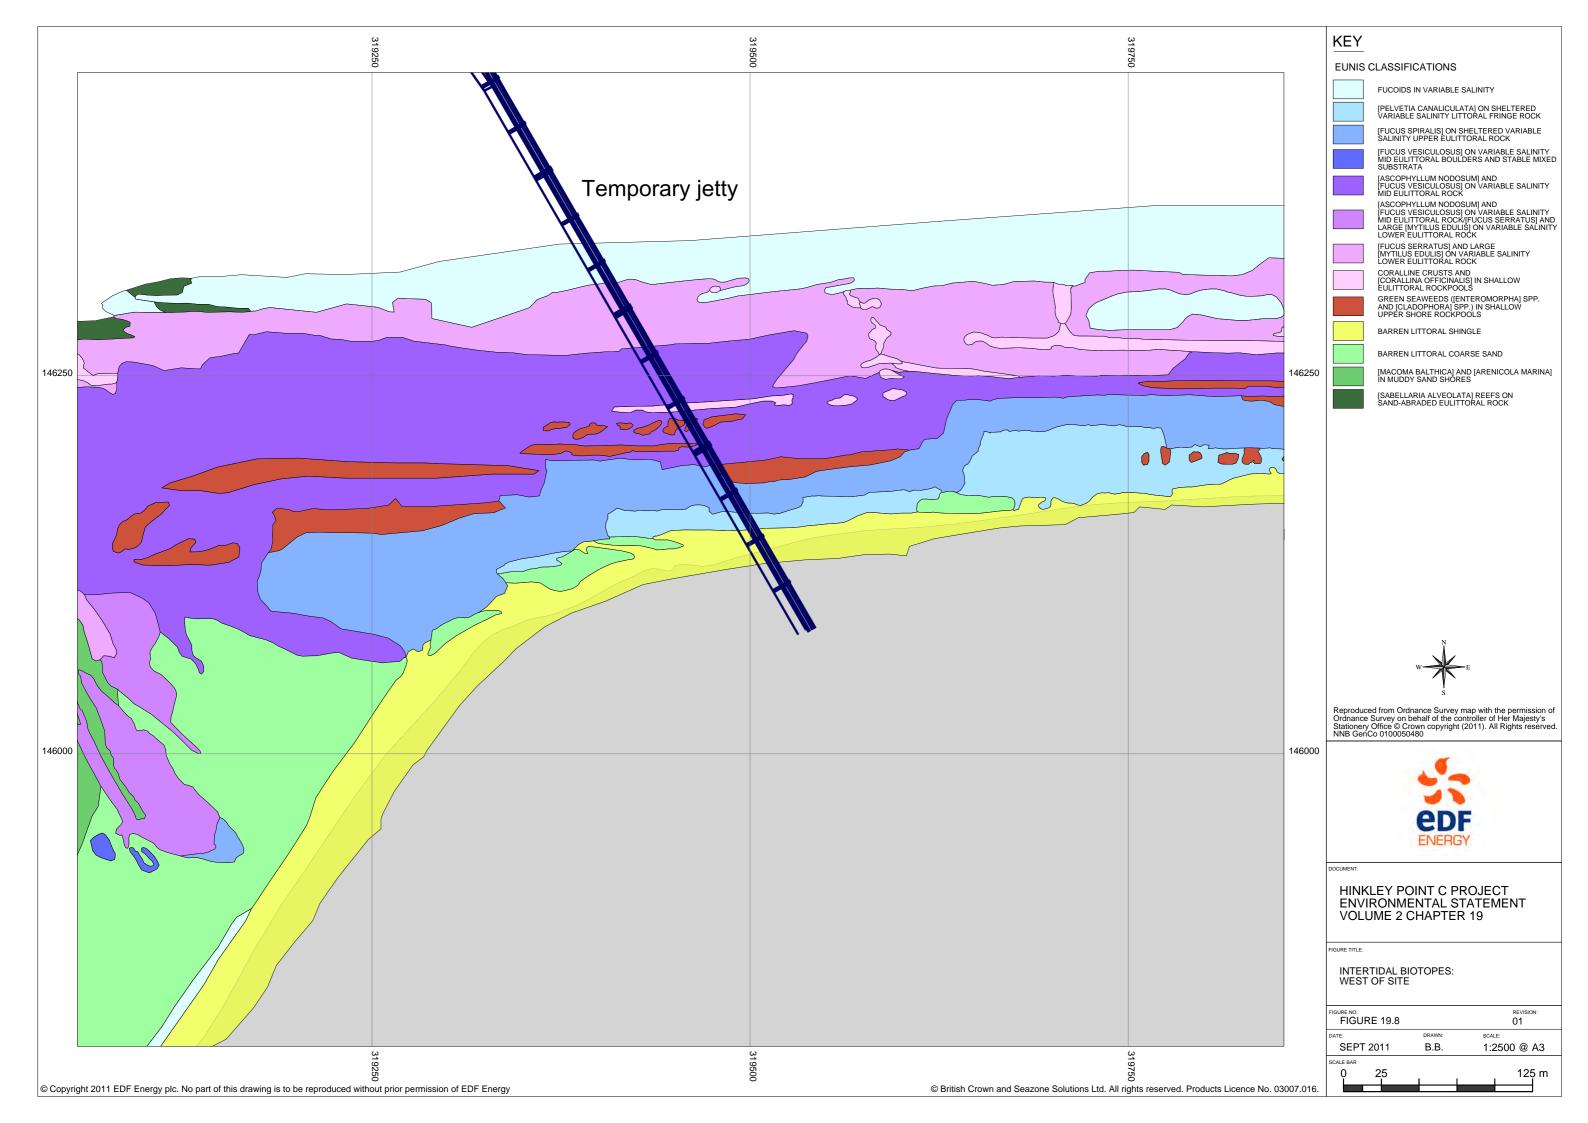


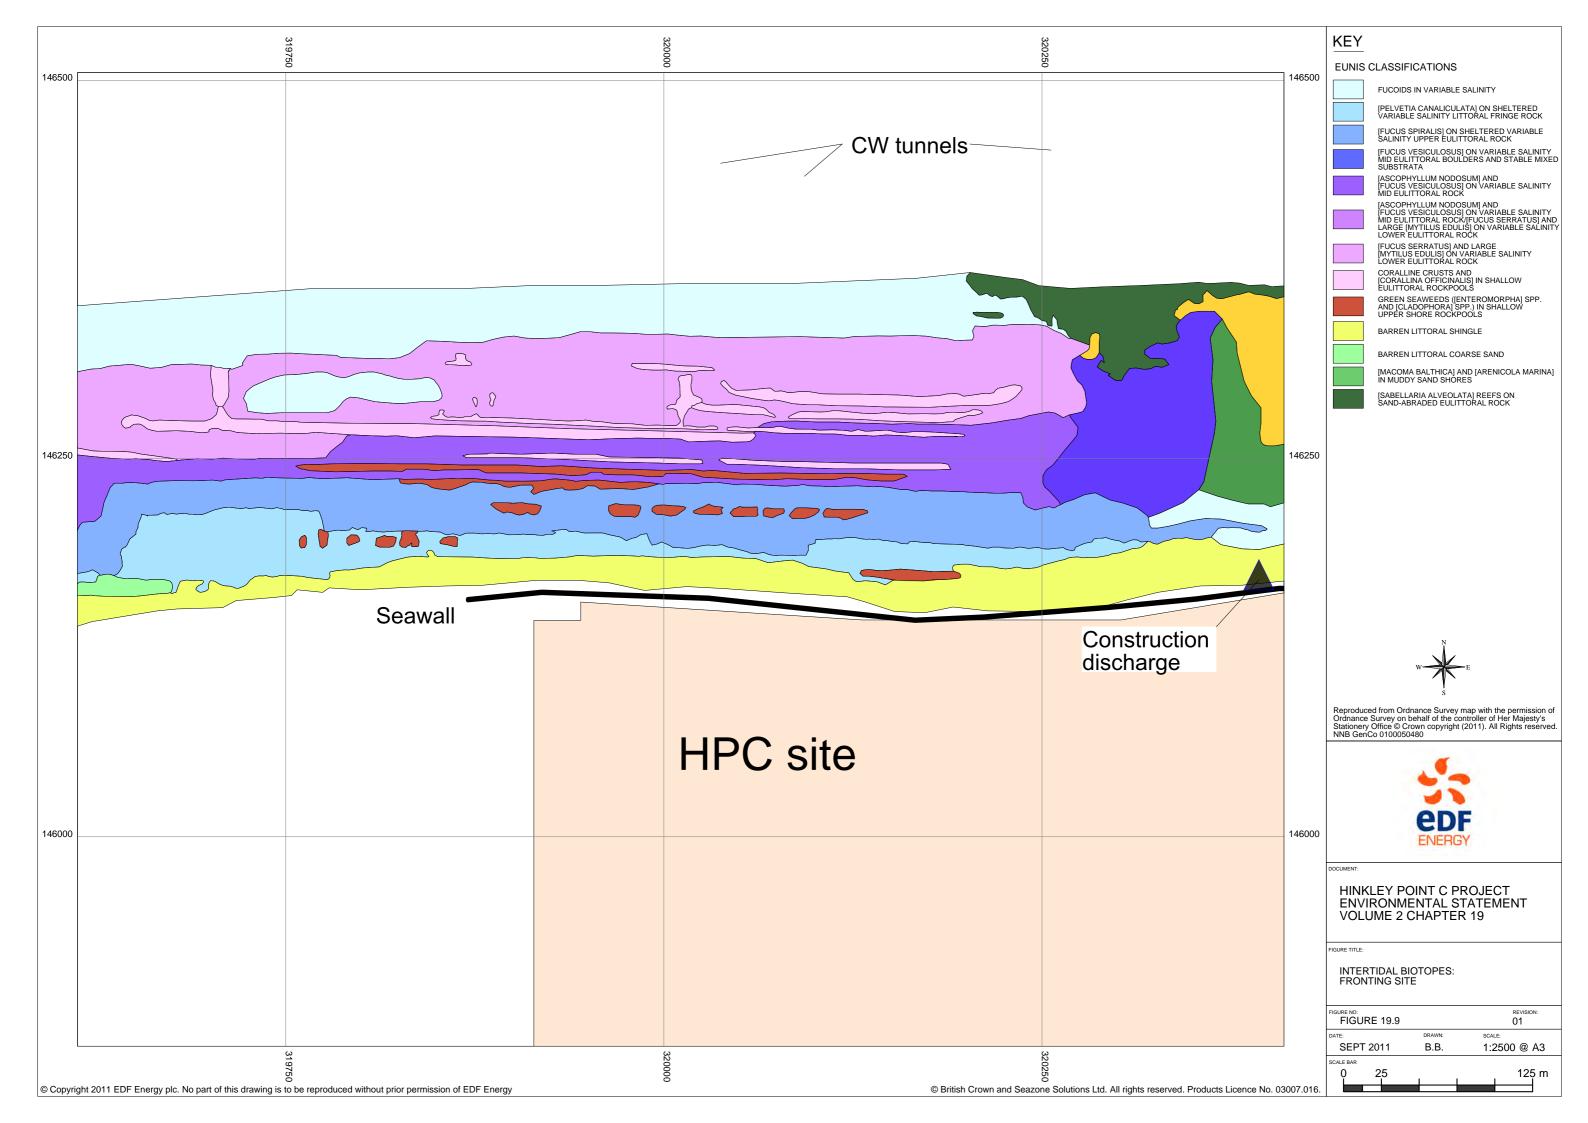


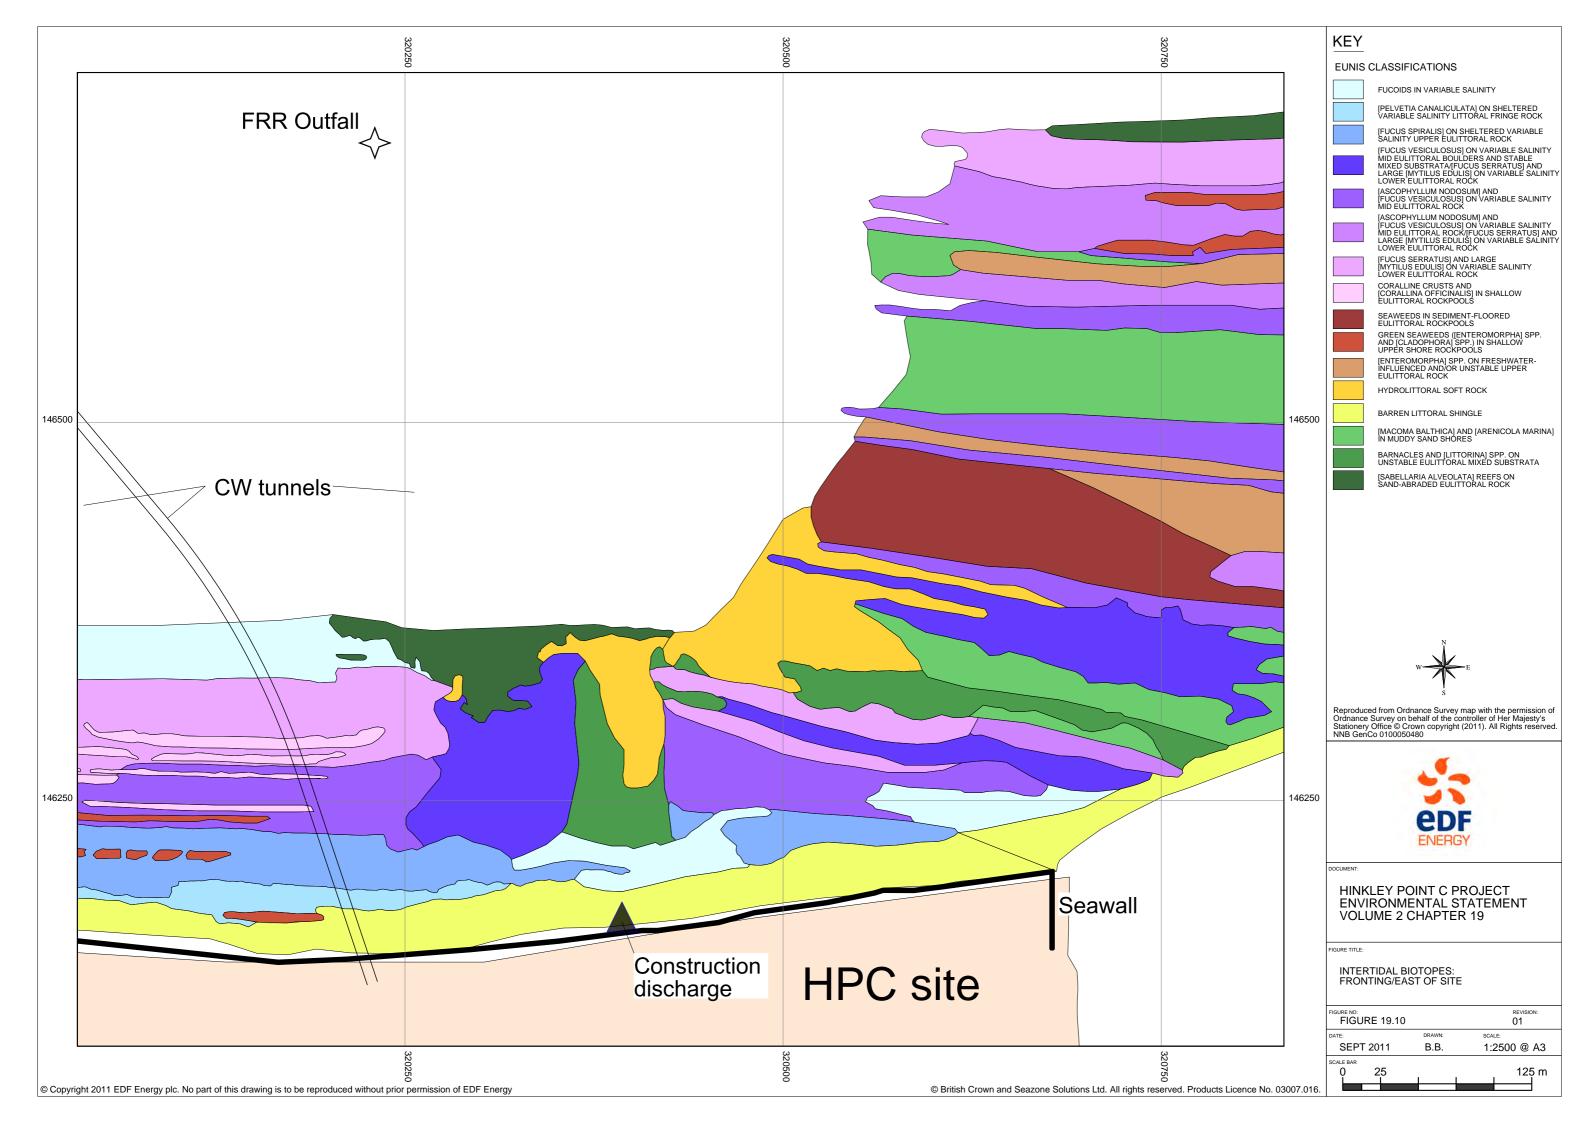


















DOCUMENT

HINKLEY POINT C PROJECT ENVIRONMENTAL STATEMENT VOLUME 2 CHAPTER 19

FIGURE TIT


PICTURES OF HINKLEY CORALLINA RUN-OFF (TOP) AND SABELLARIA REEF (BOTTOM) PHOTOS: C. TAYLOR


FIGURE 19.11 REVISION: 01


DATE: DRAWN: SCALE:


SEPT 2011 B.B.

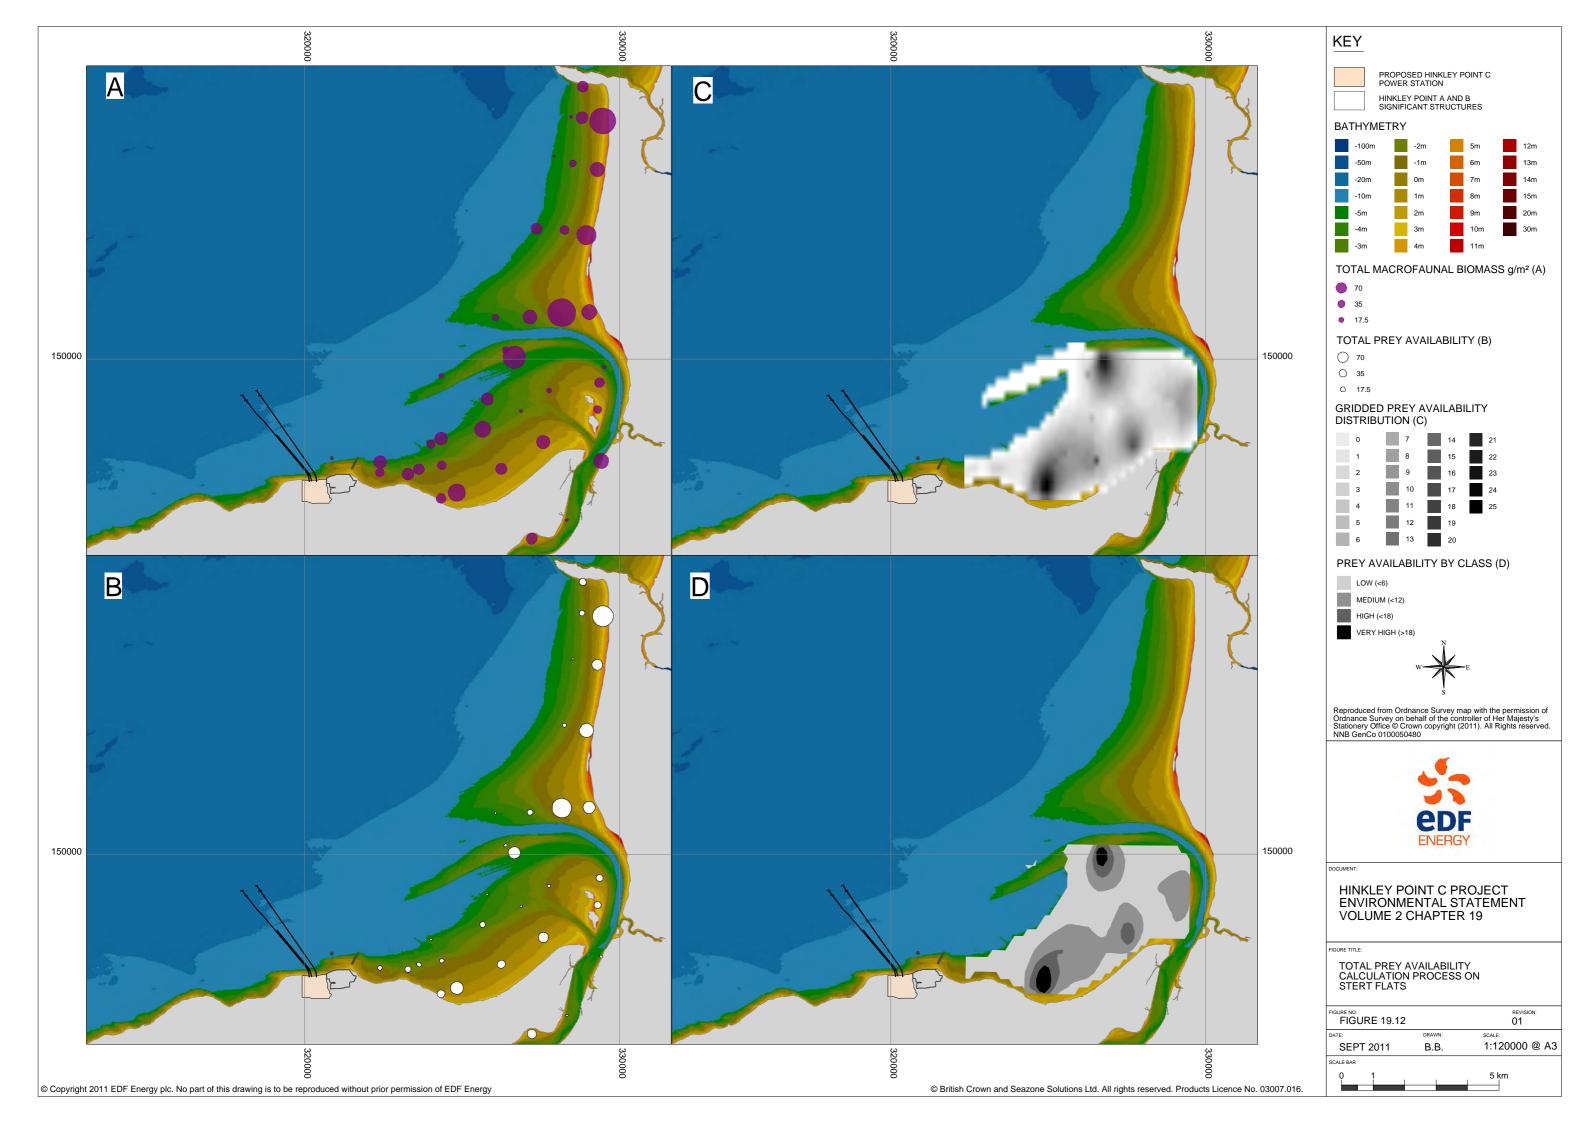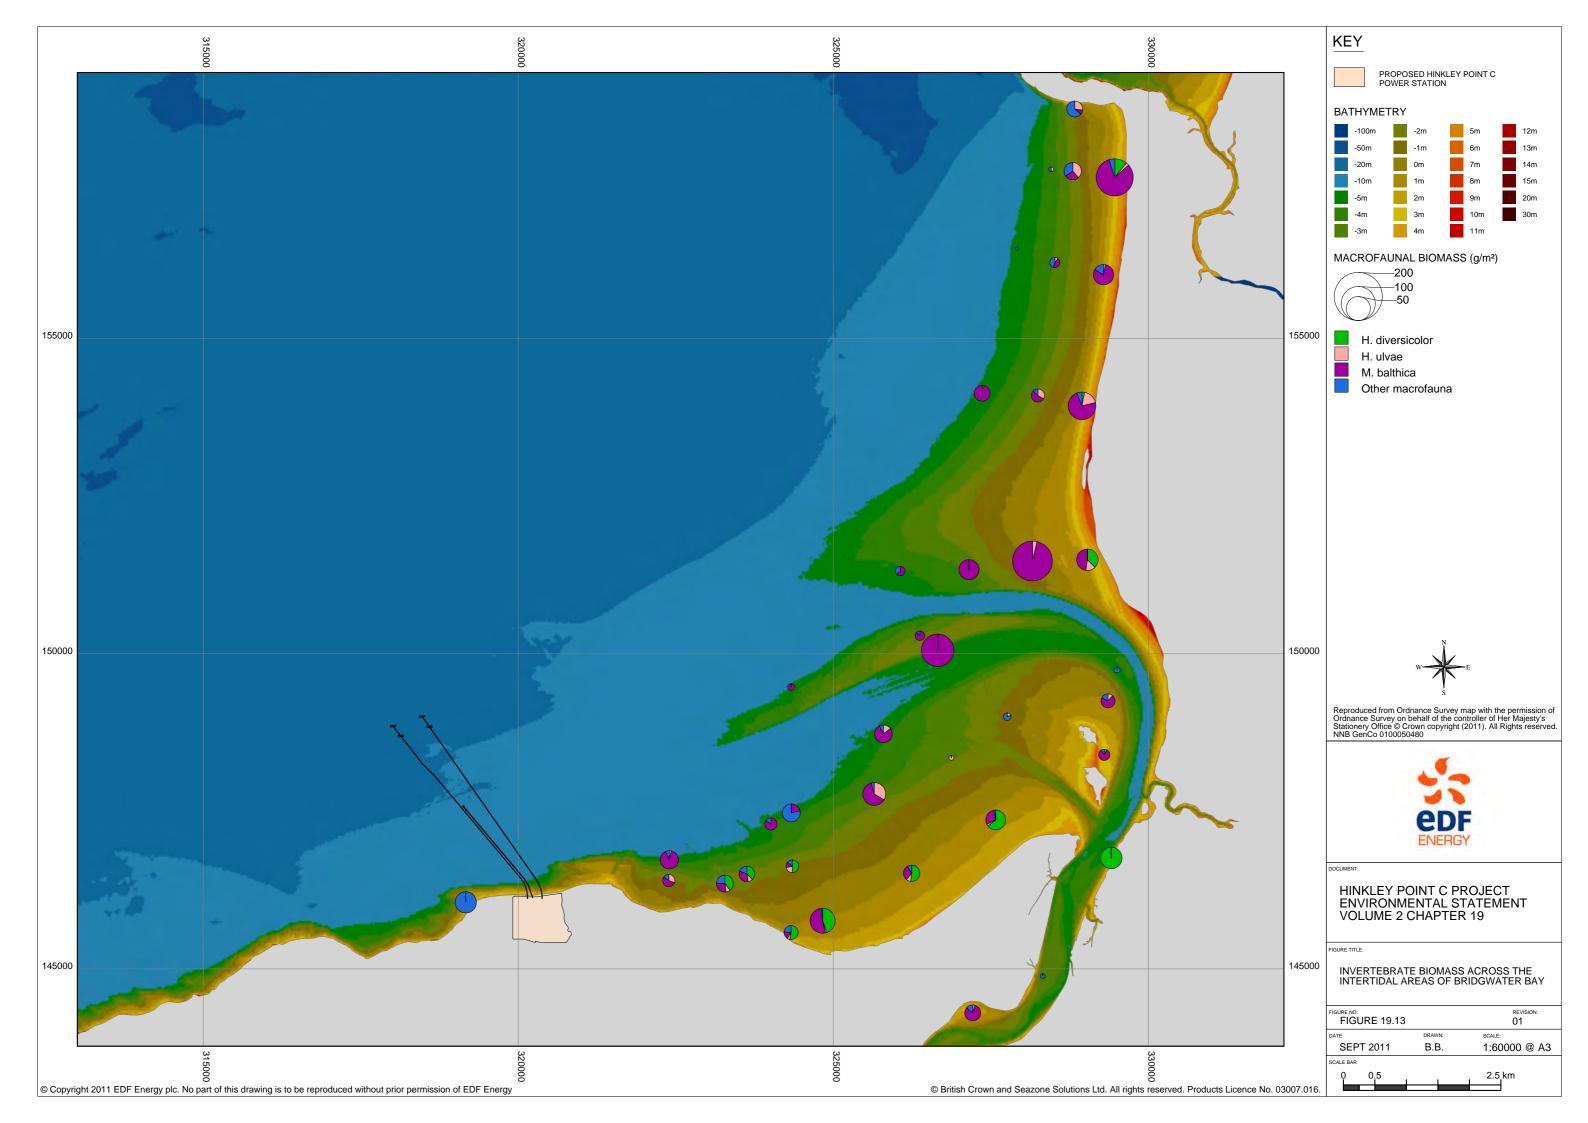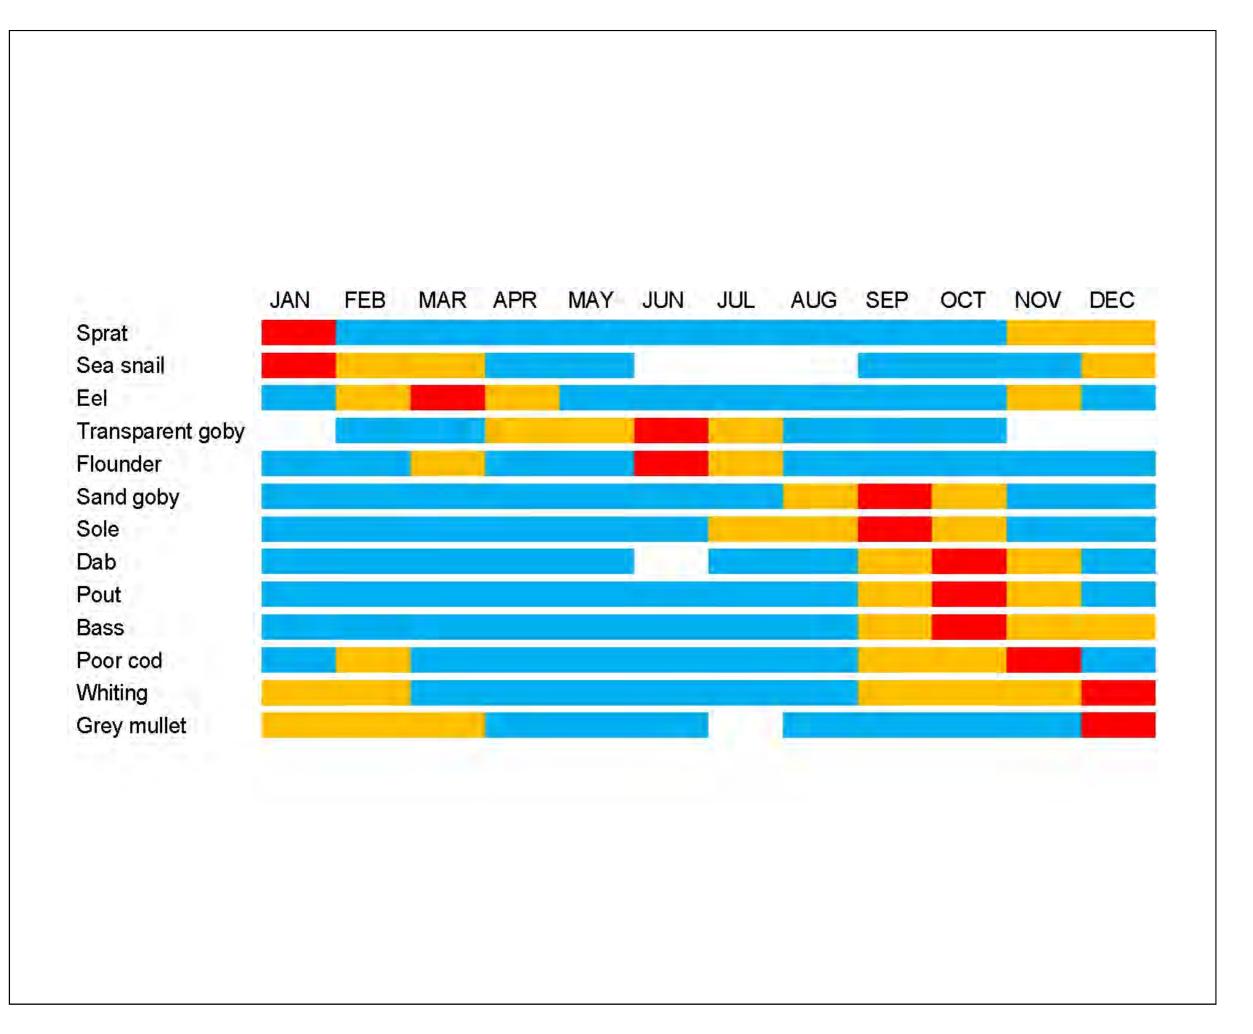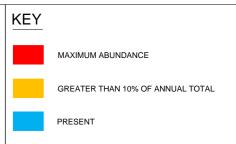SCALE BAR











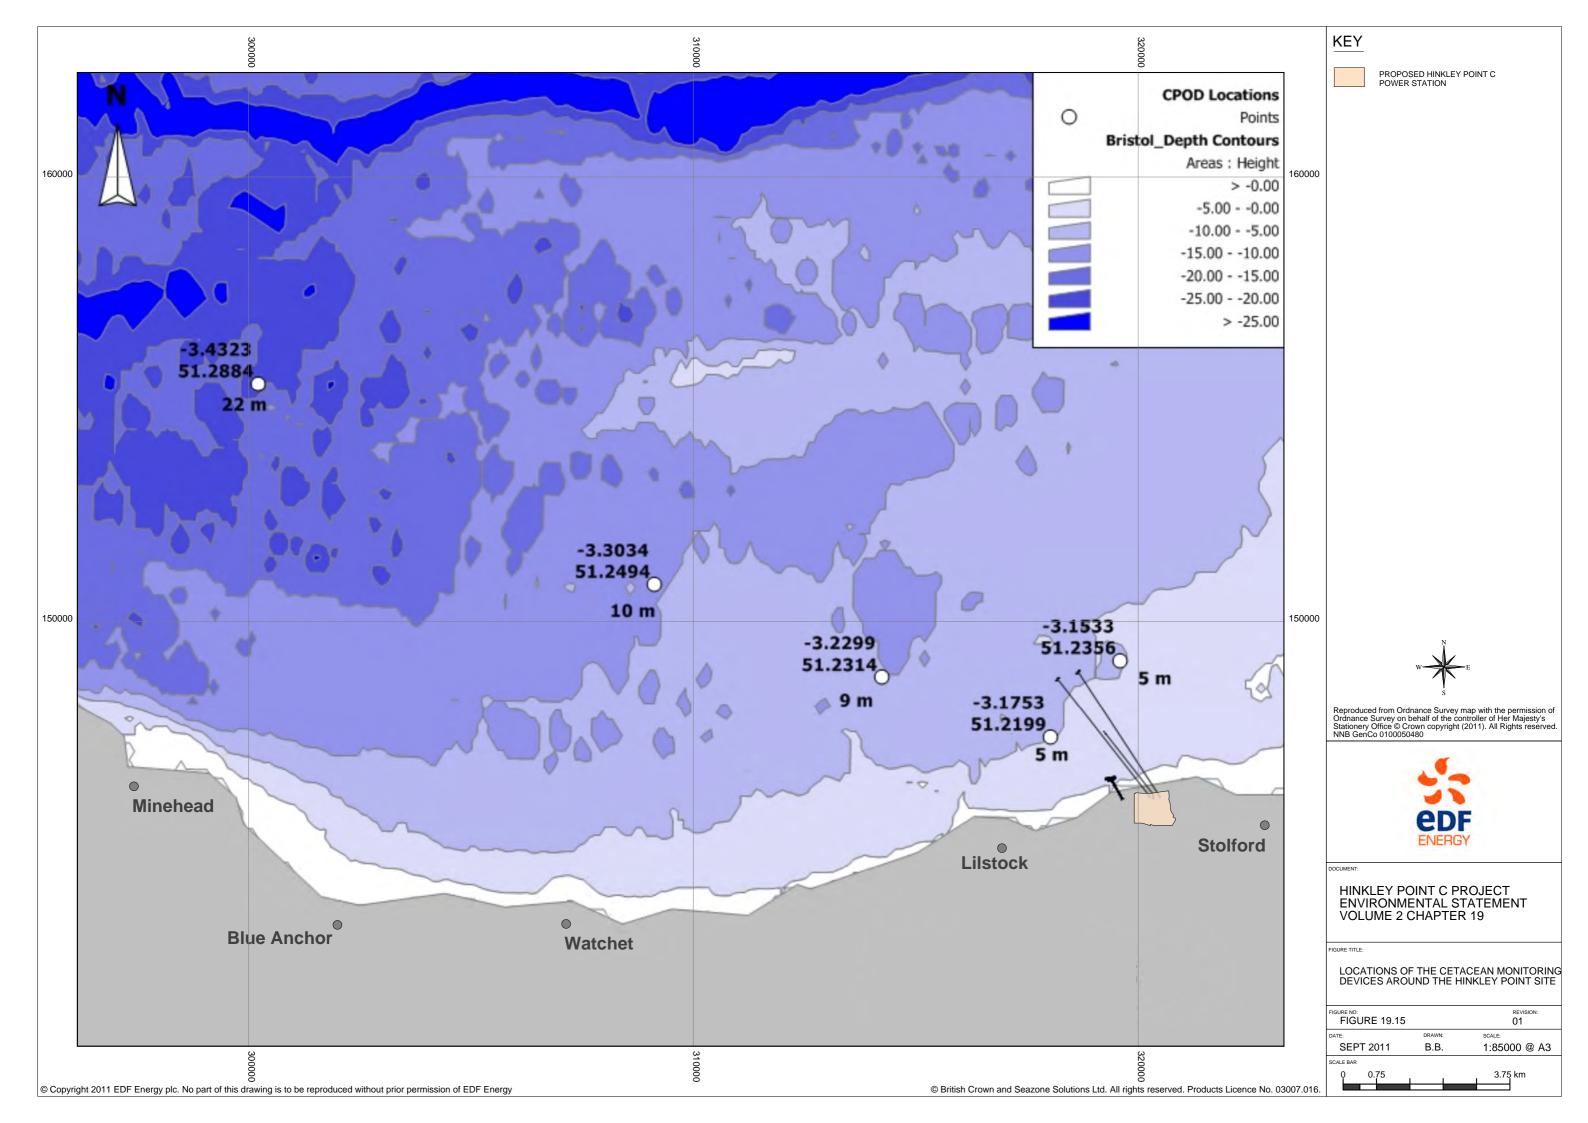
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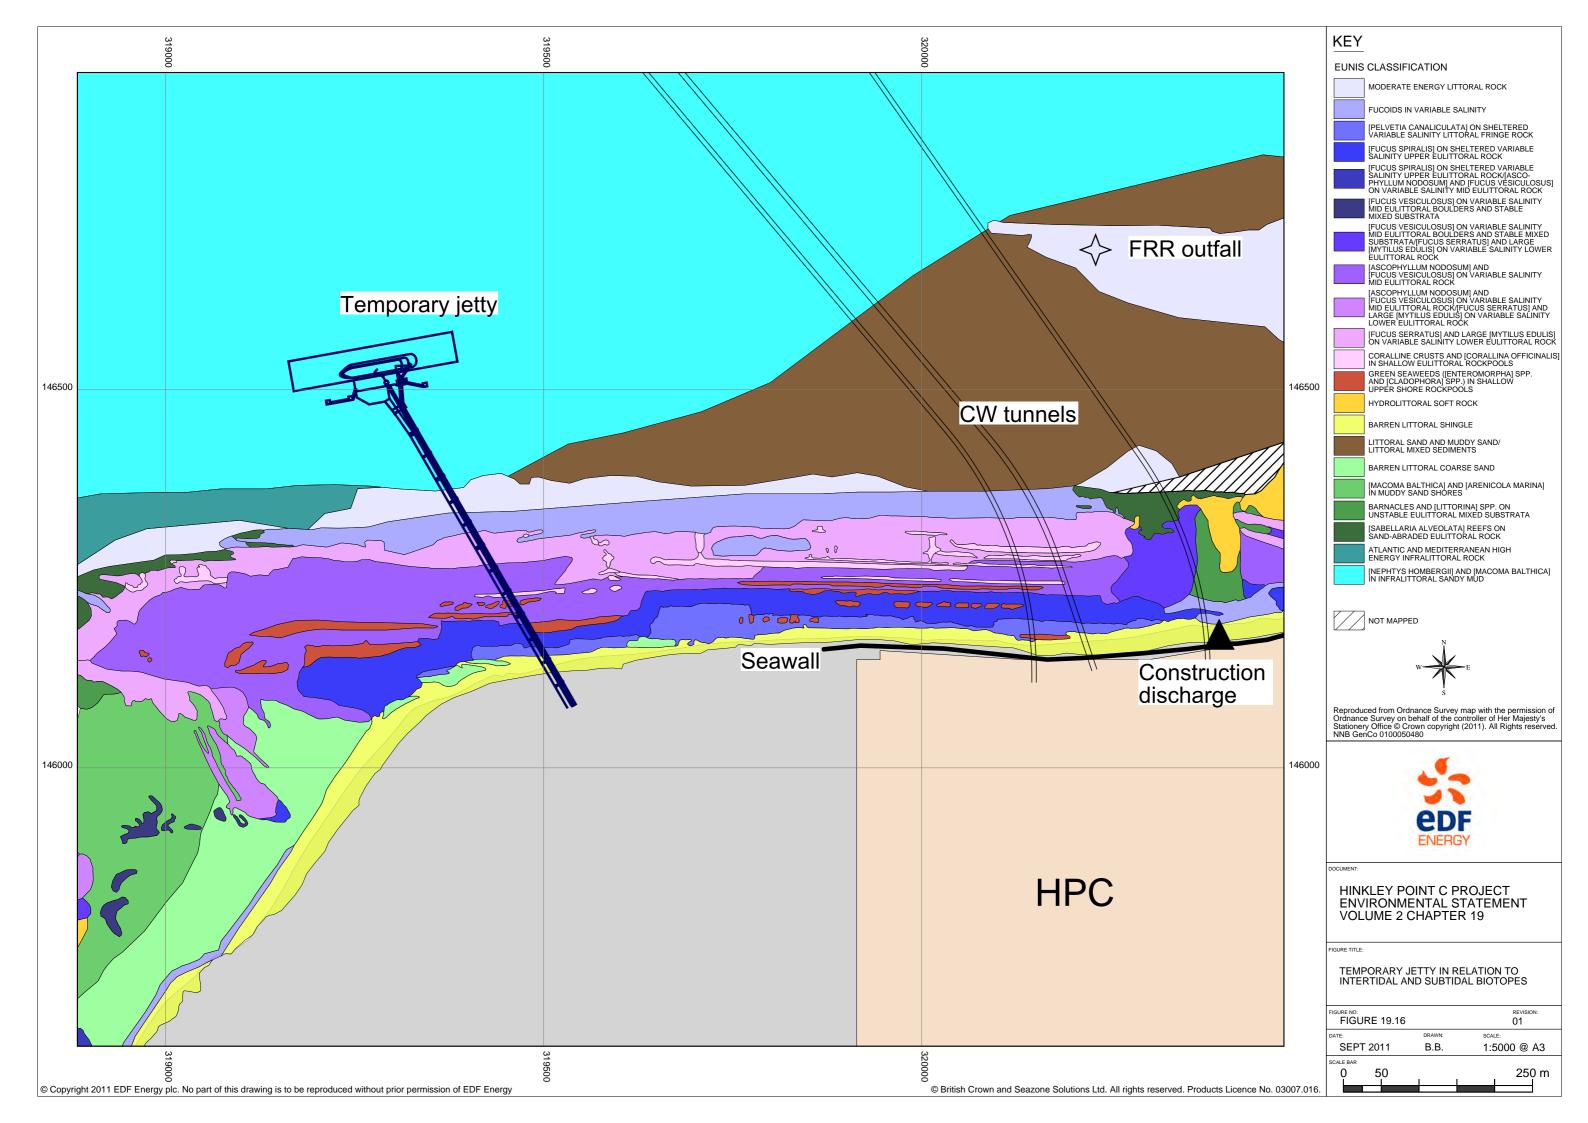
HINKLEY POINT C PROJECT ENVIRONMENTAL STATEMENT VOLUME 2 CHAPTER 19


FIGURE TITL


PEAK ABUNDANCES FOR 13 MOST COMMON FISH SPECIES


FIGURE 19.14			REVISION:
DATE:	DRAWN:	SCALE:	
SEPT 2011	B.B.		
SCALE BAR			







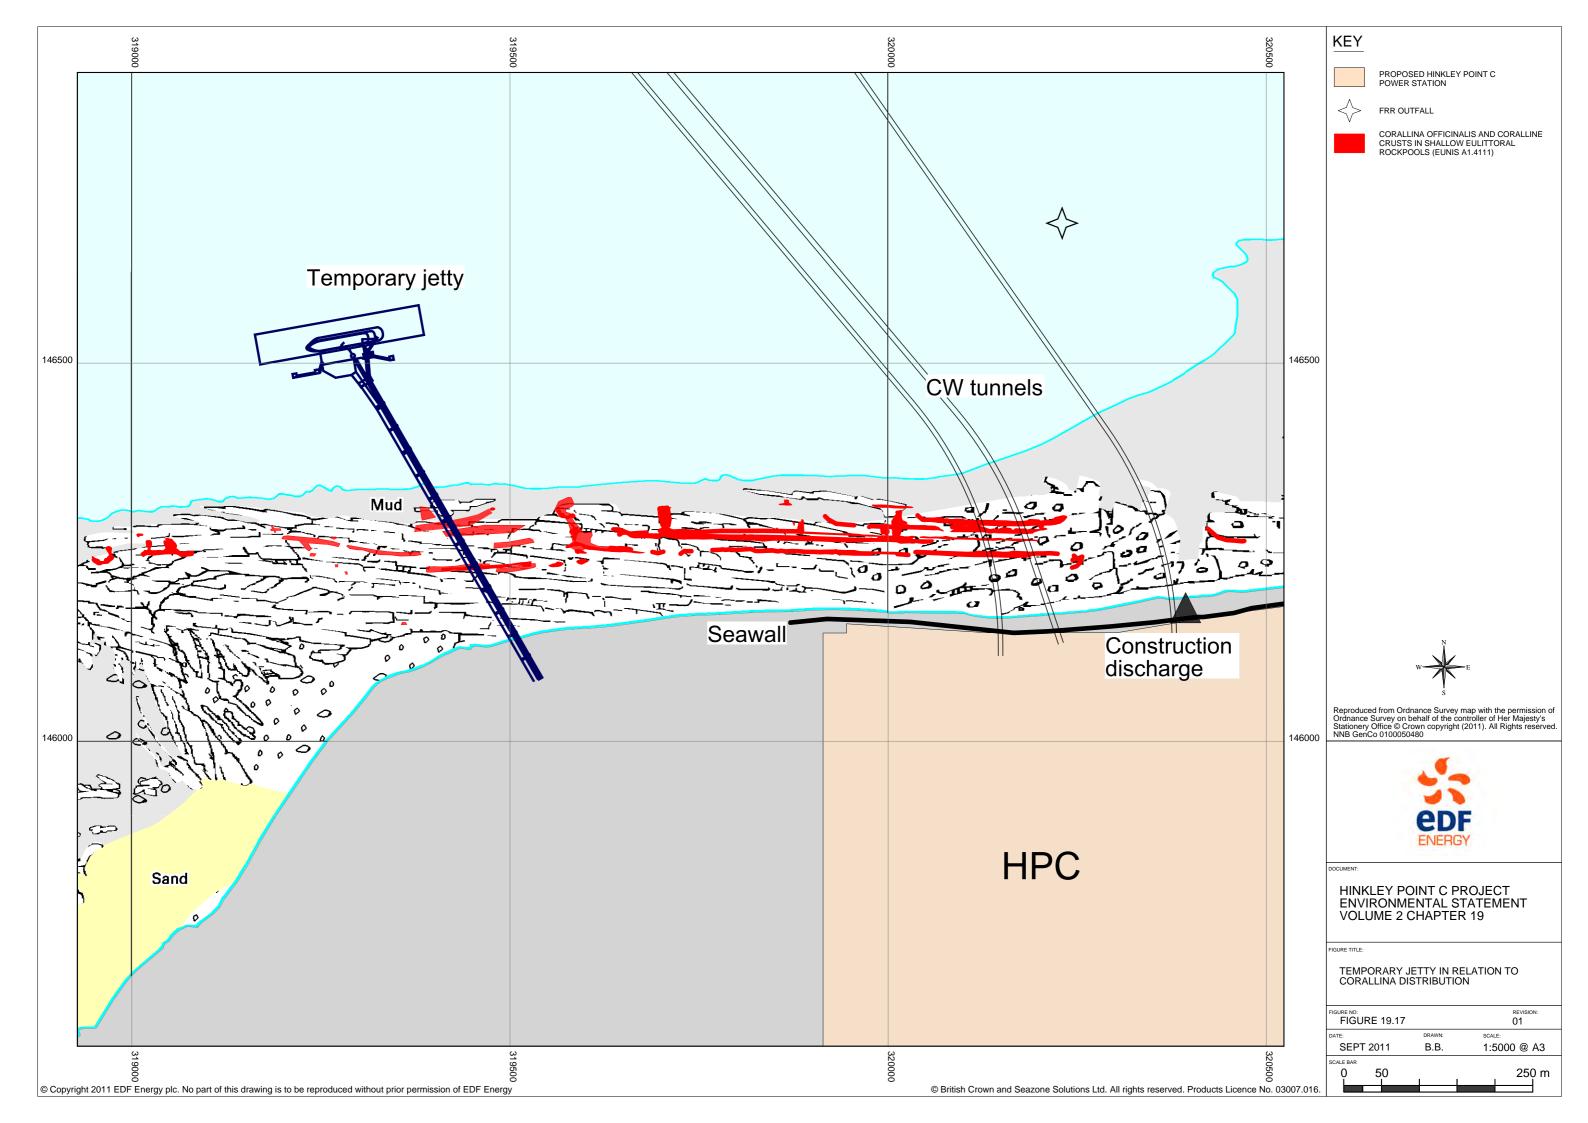


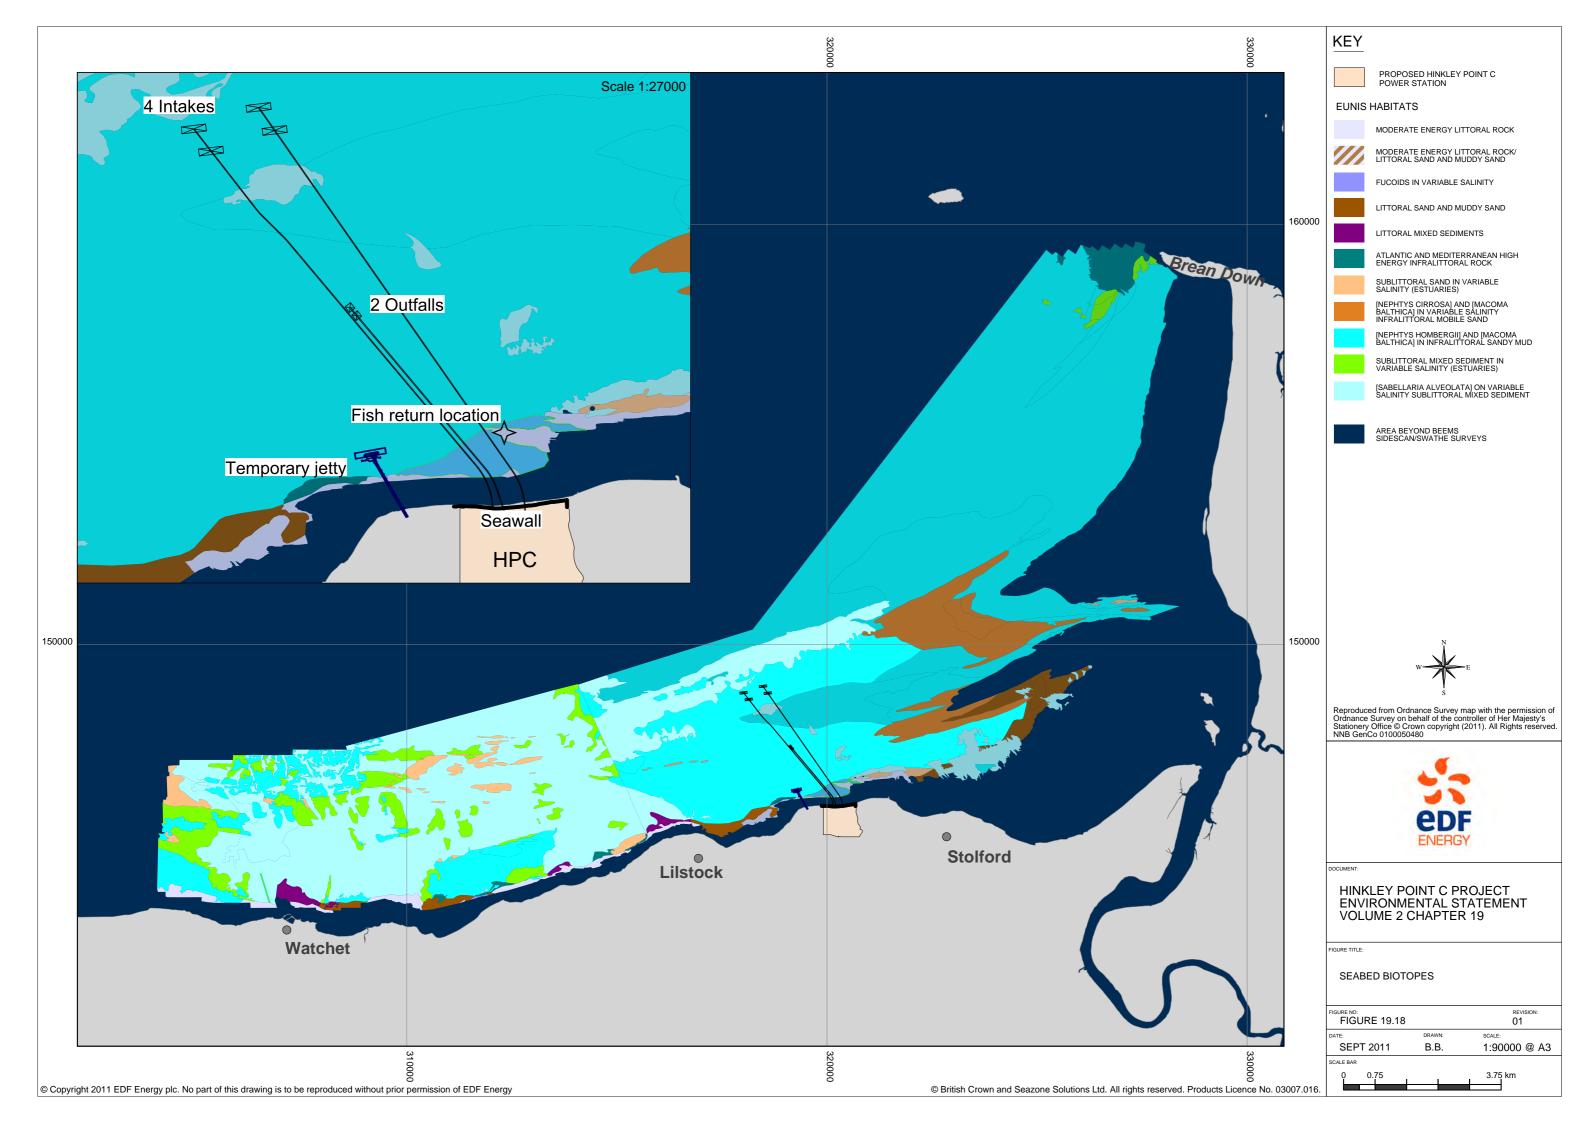


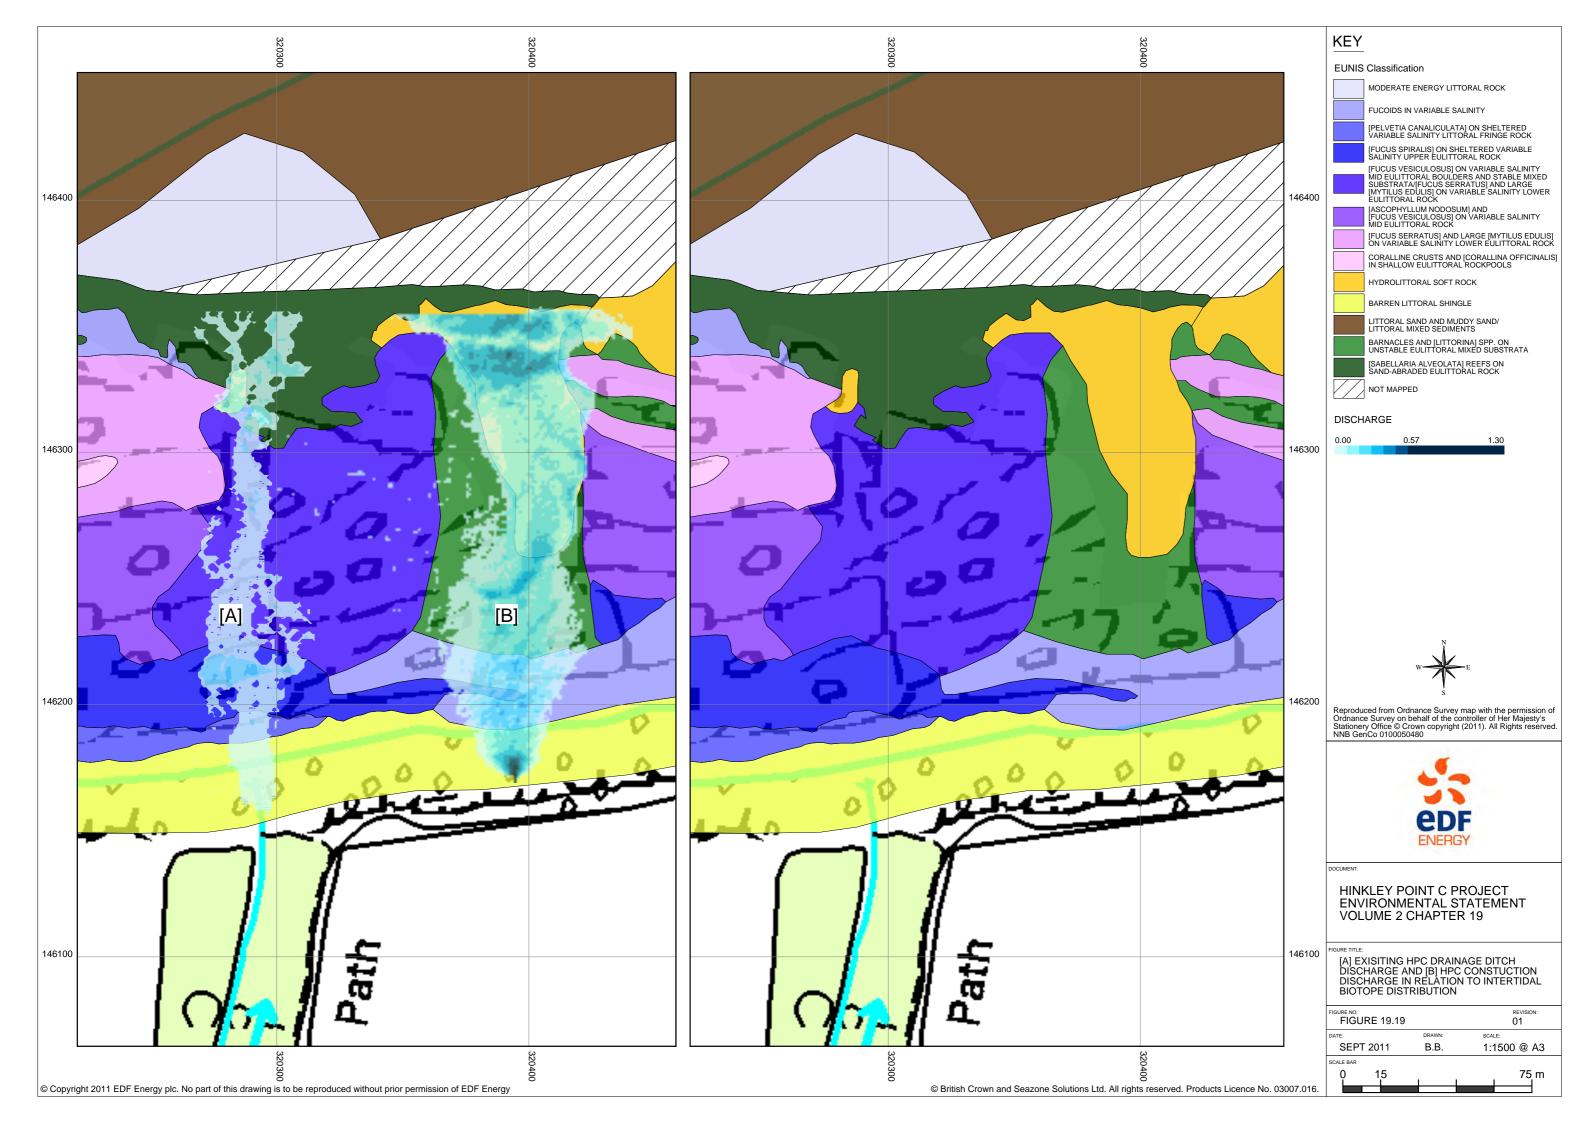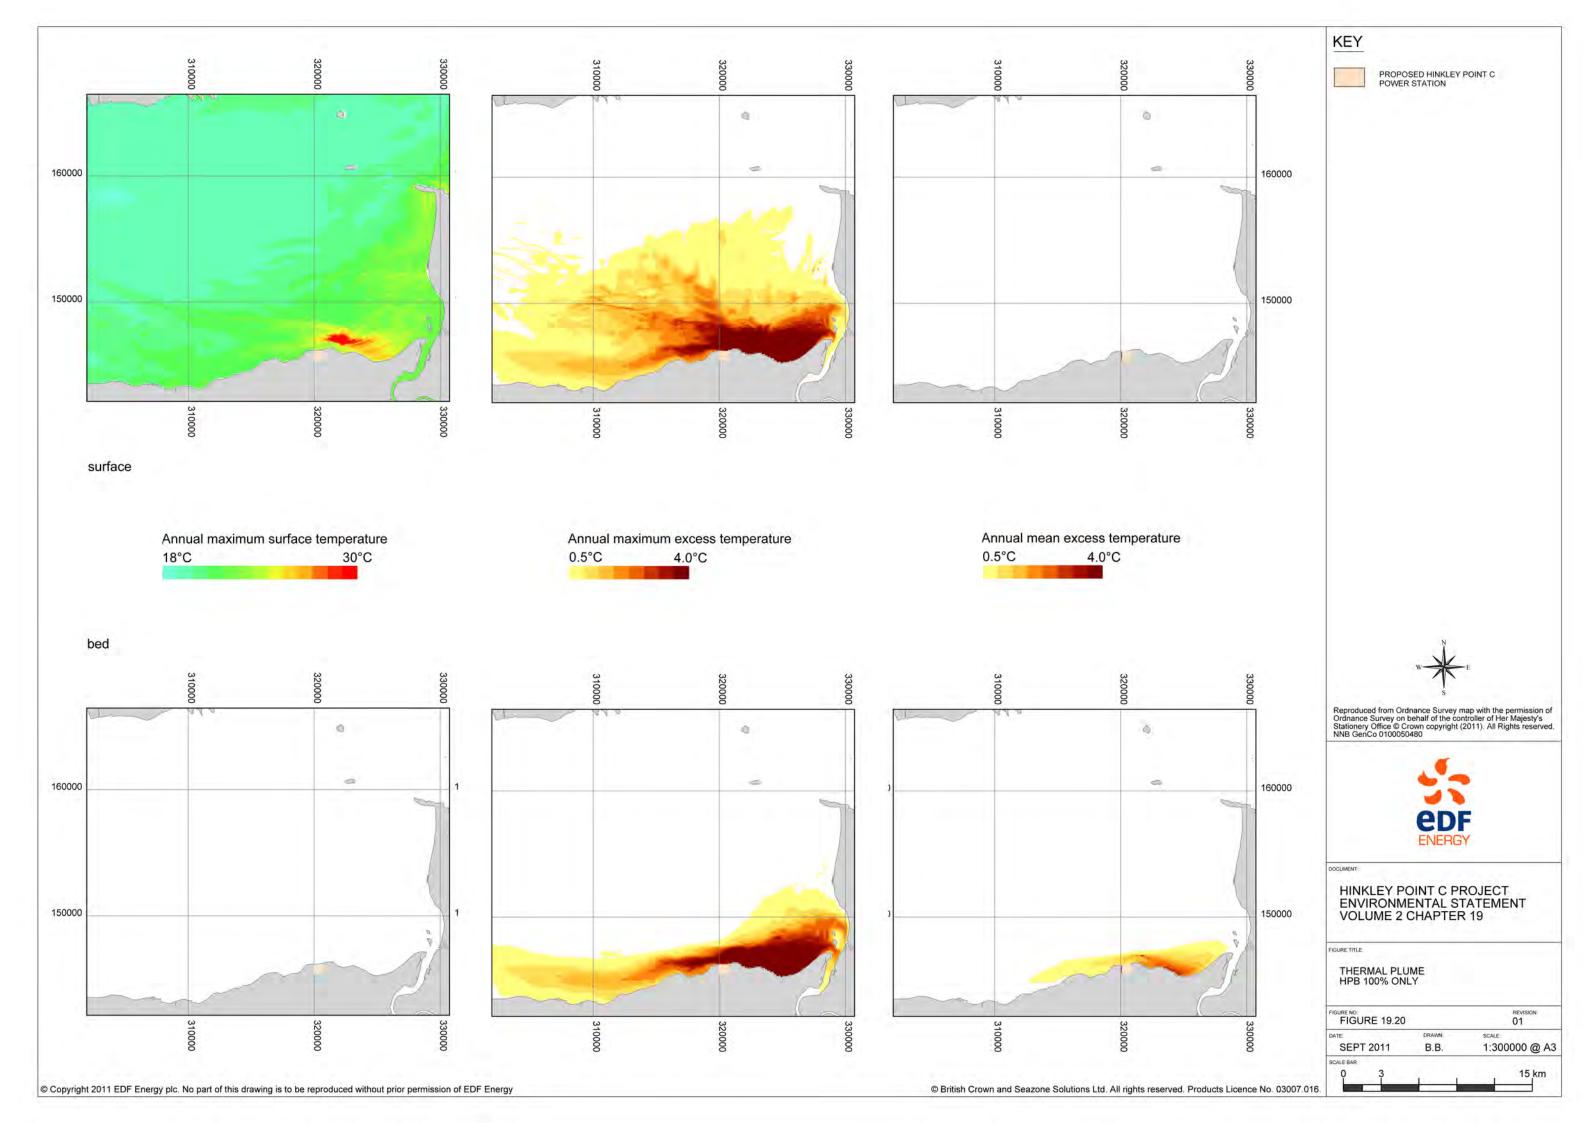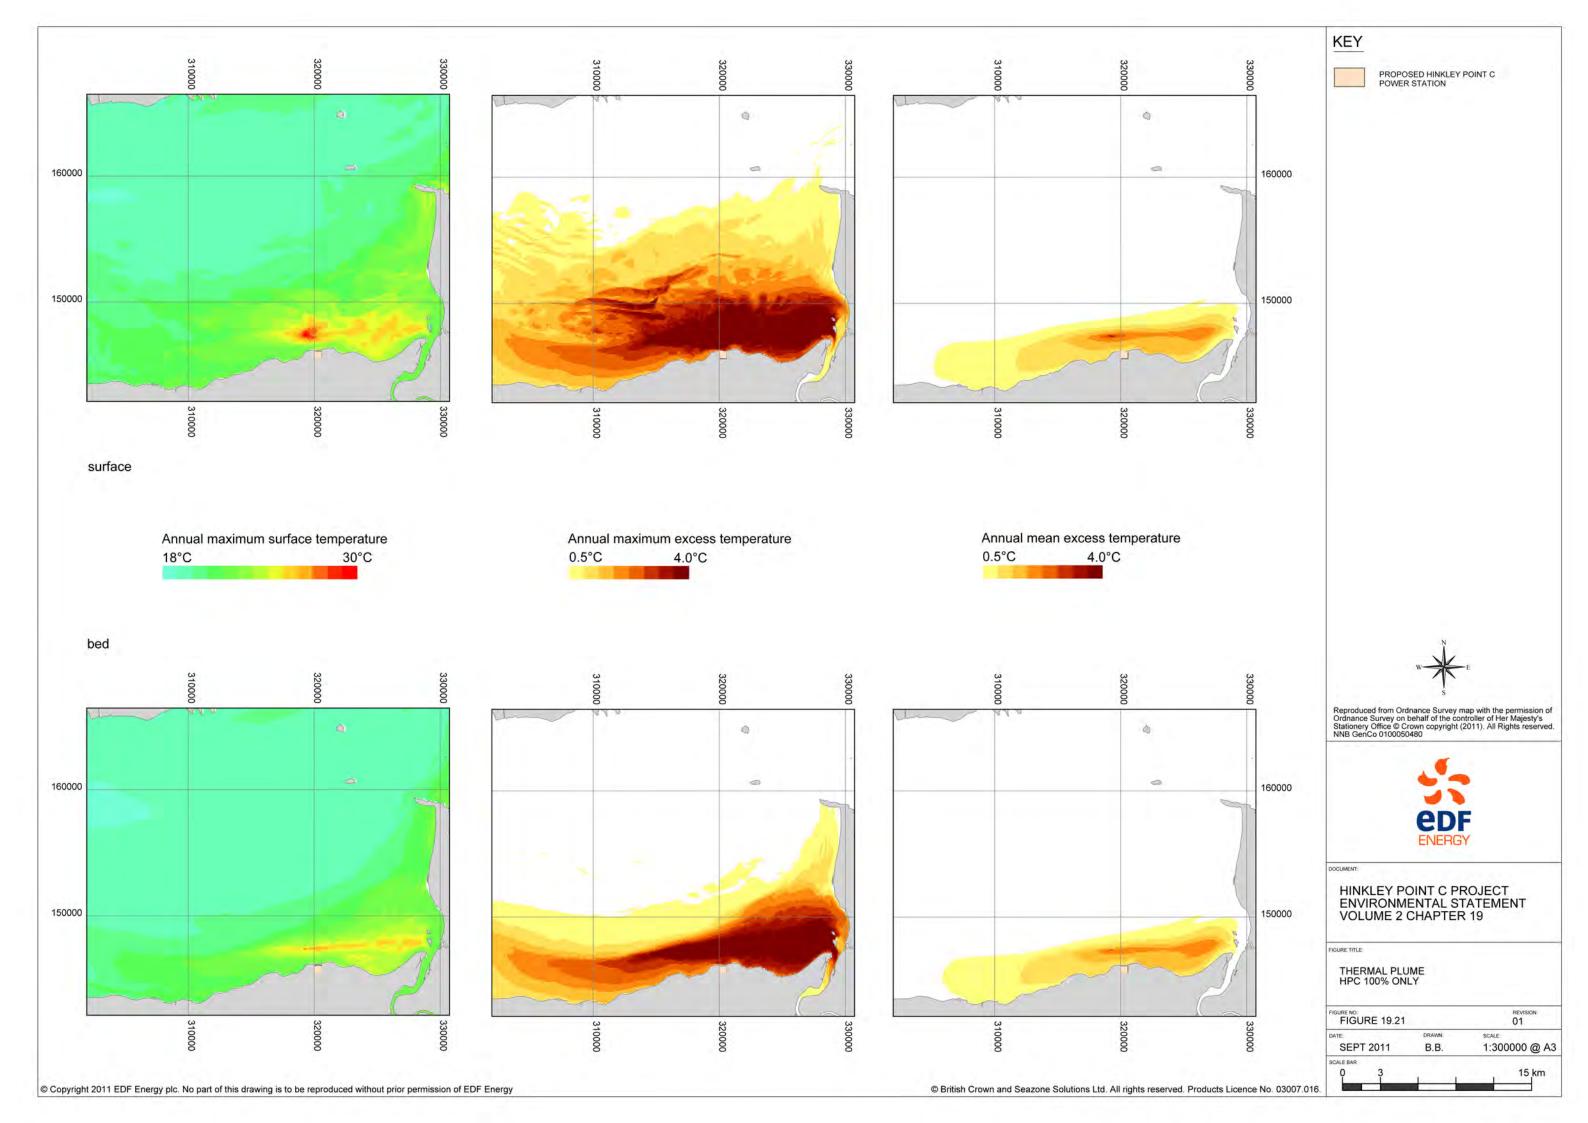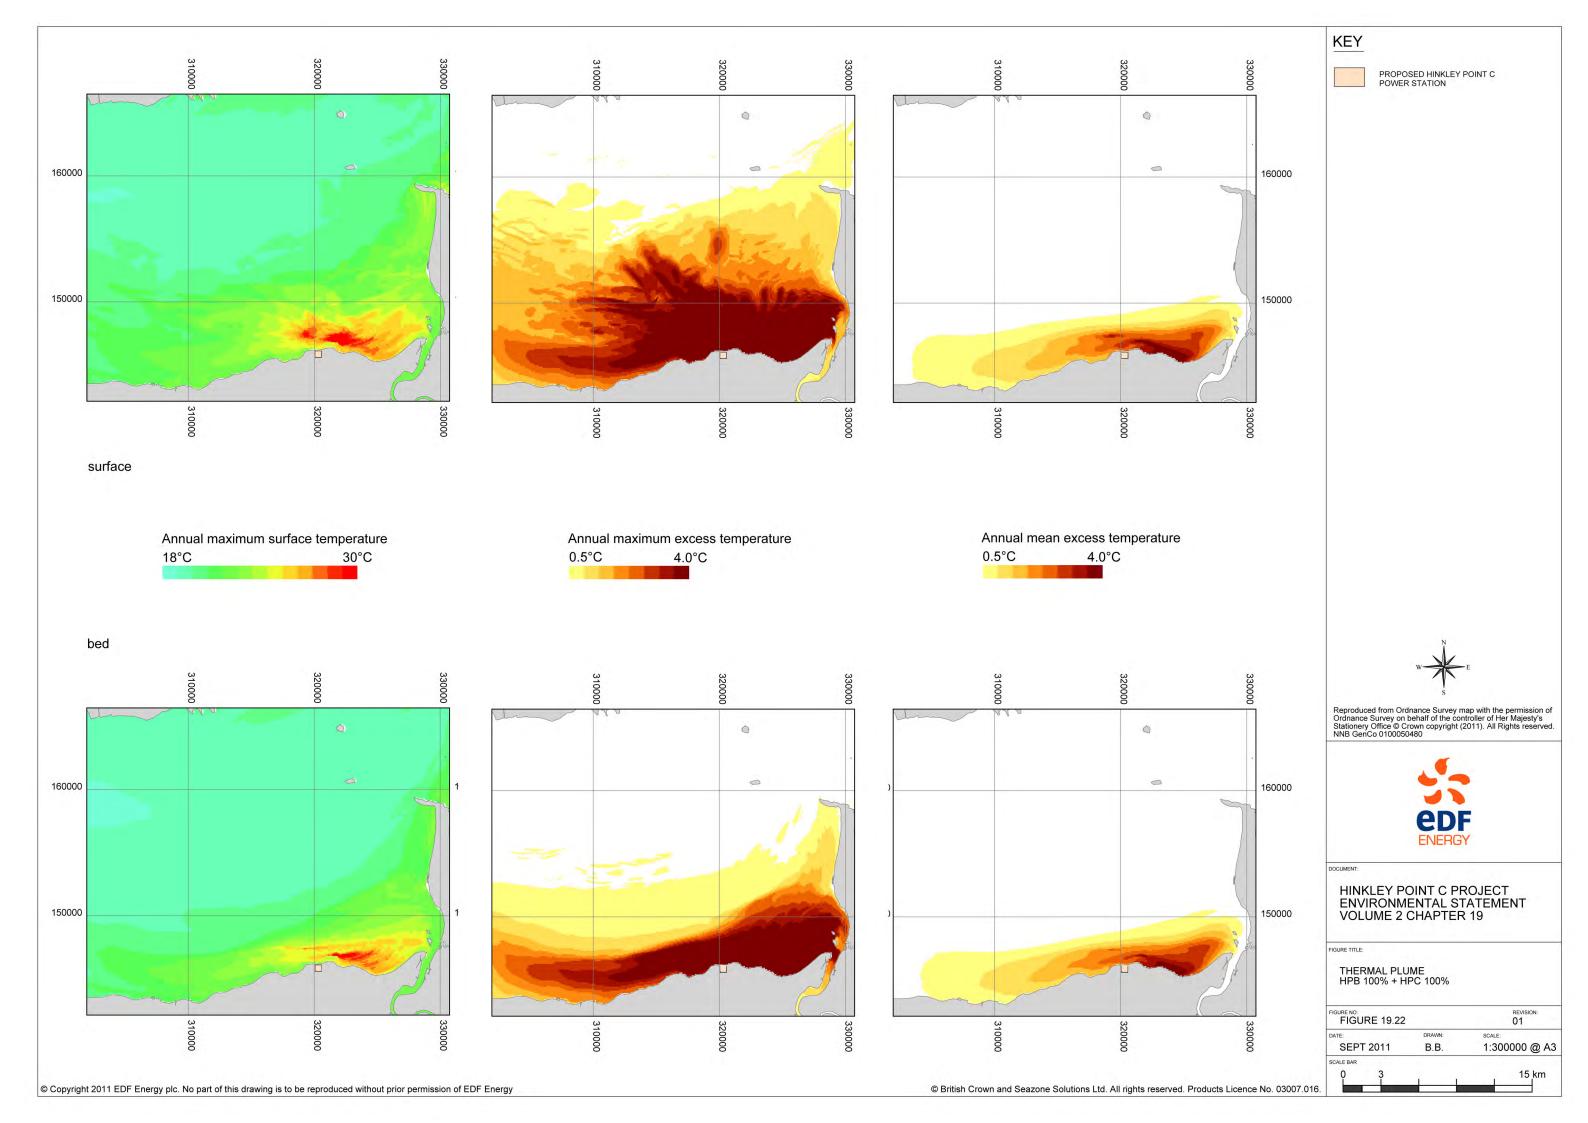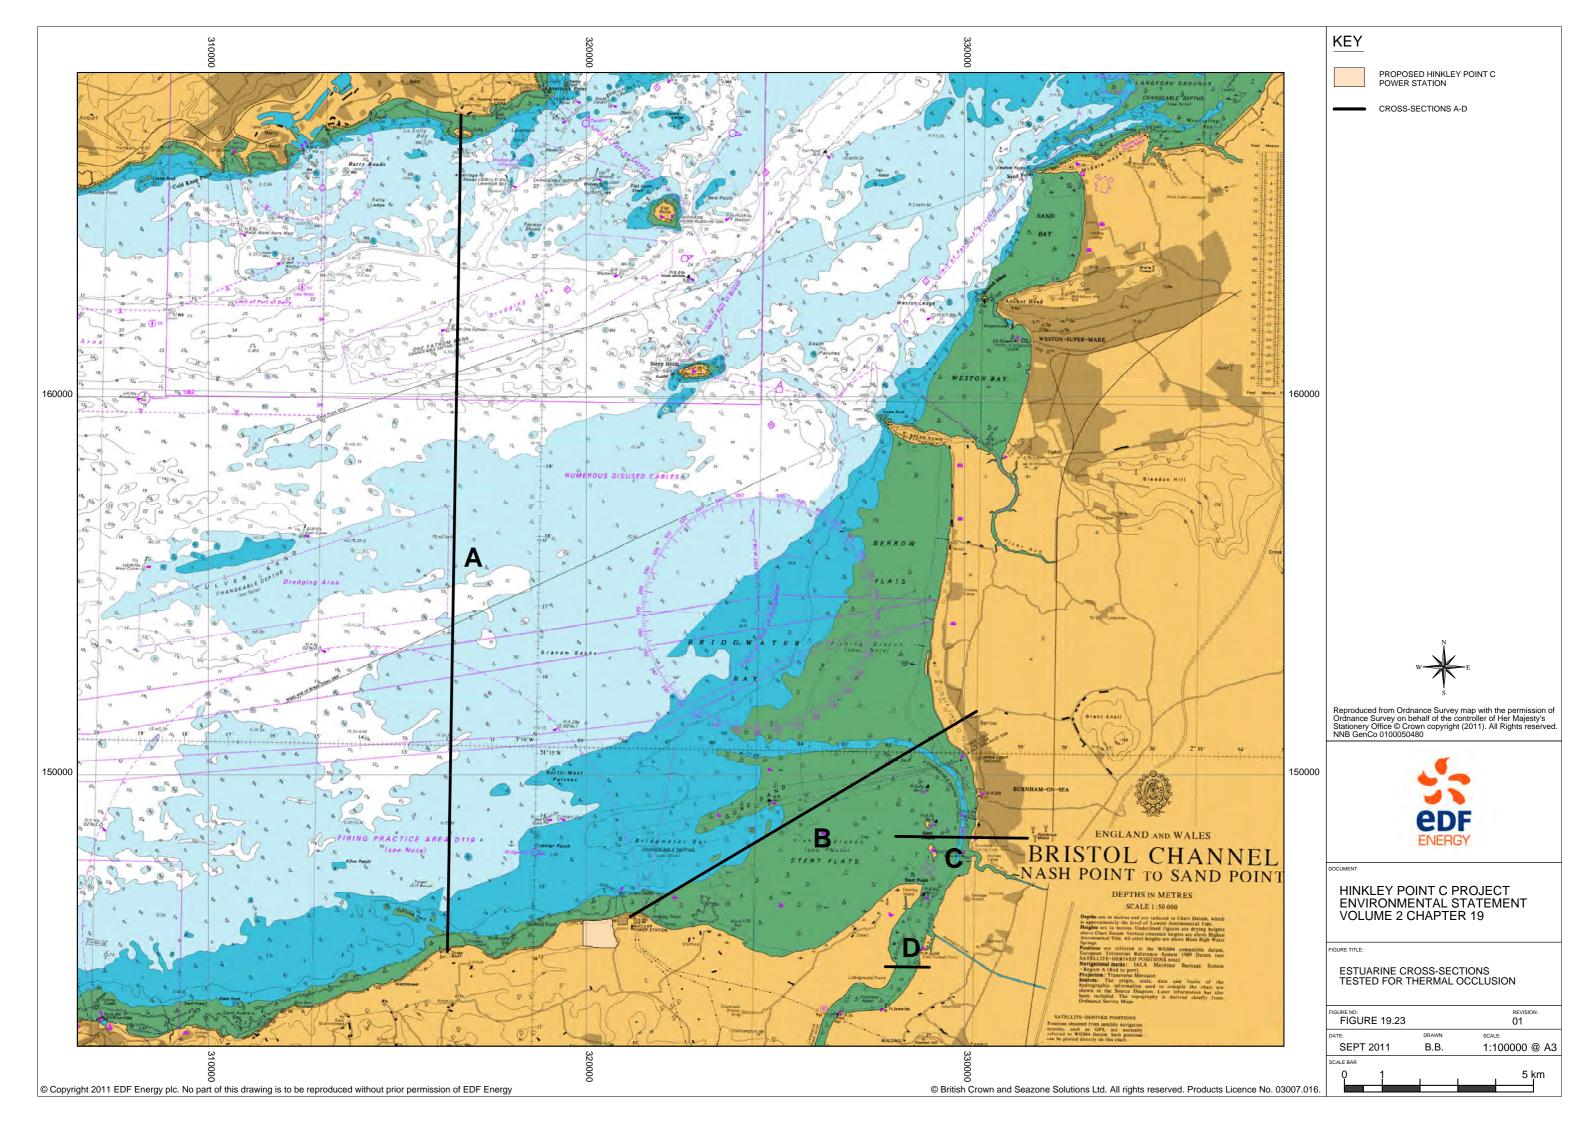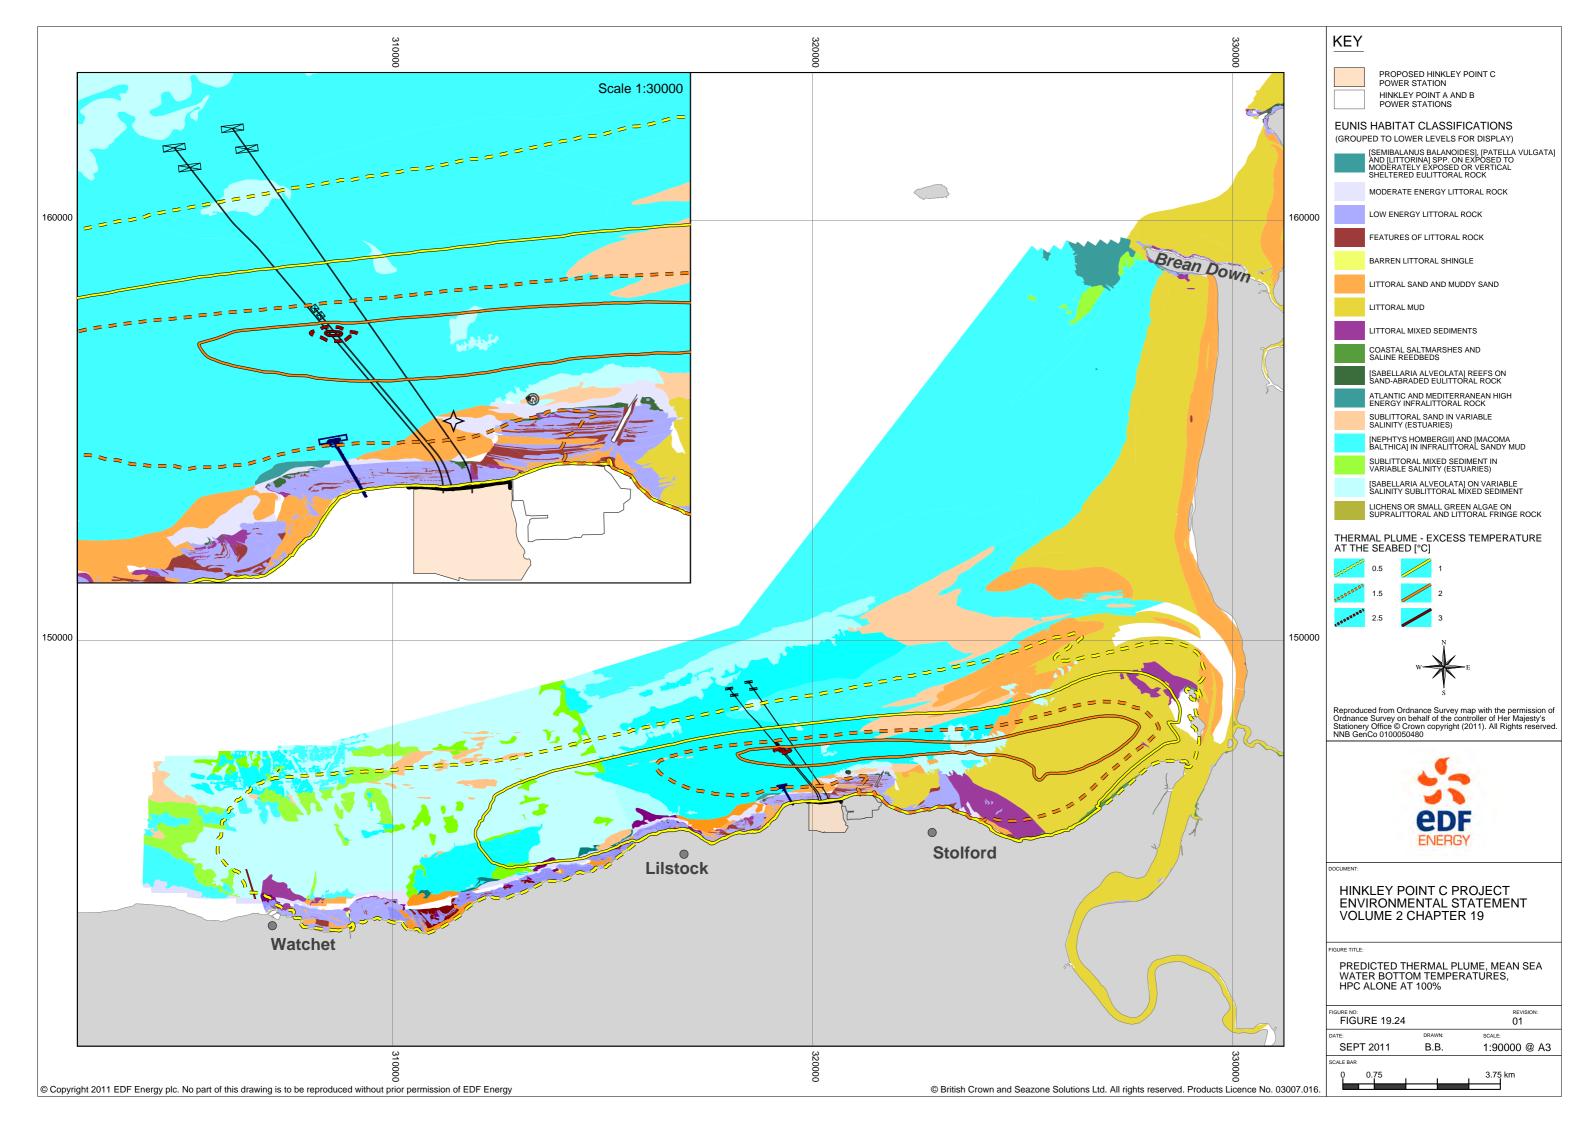


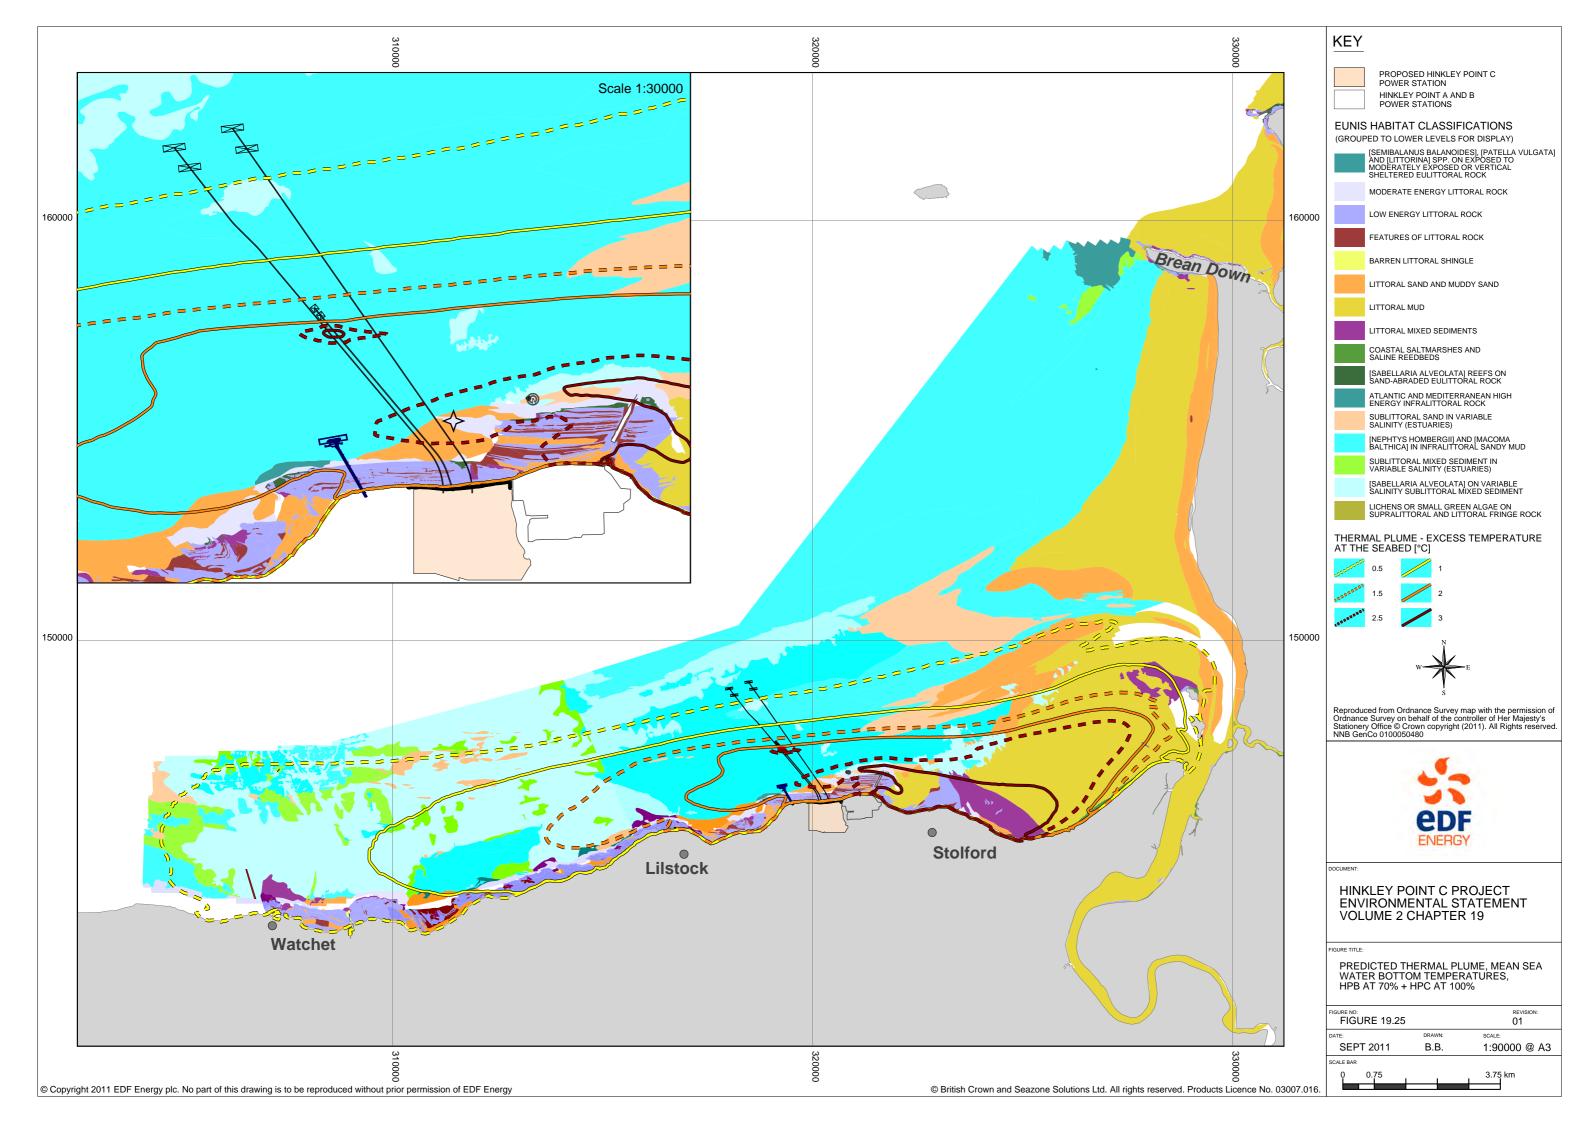


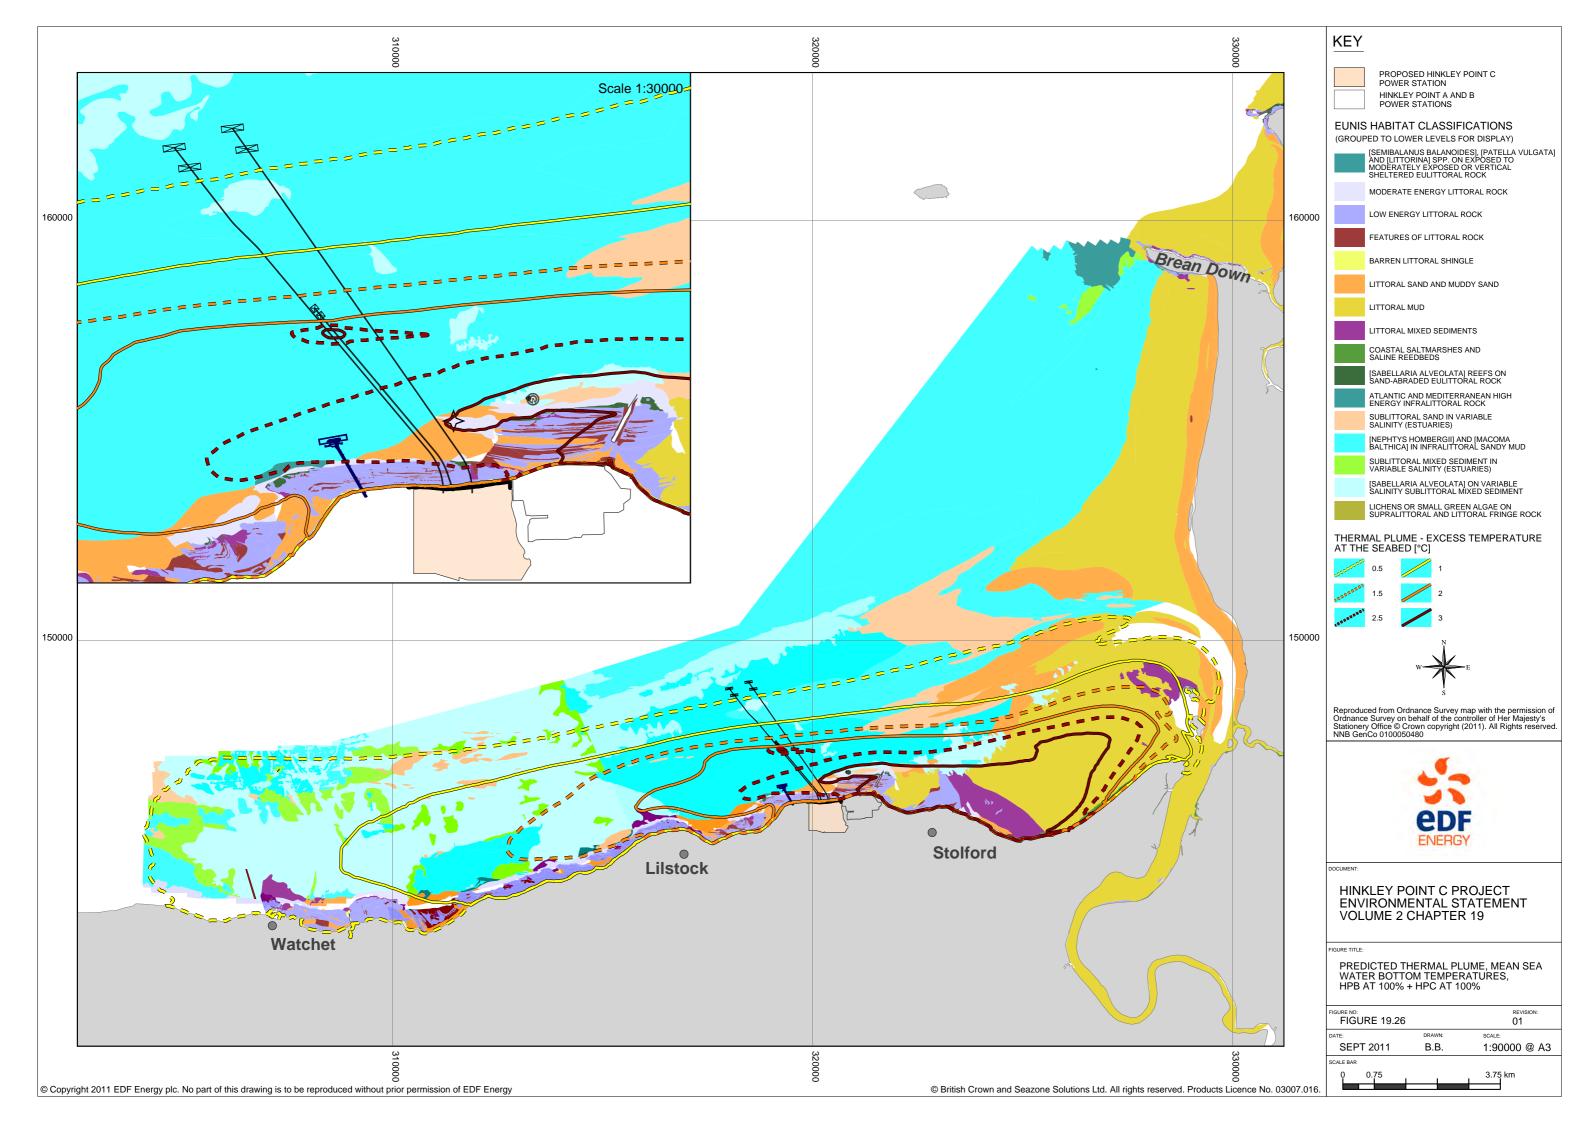


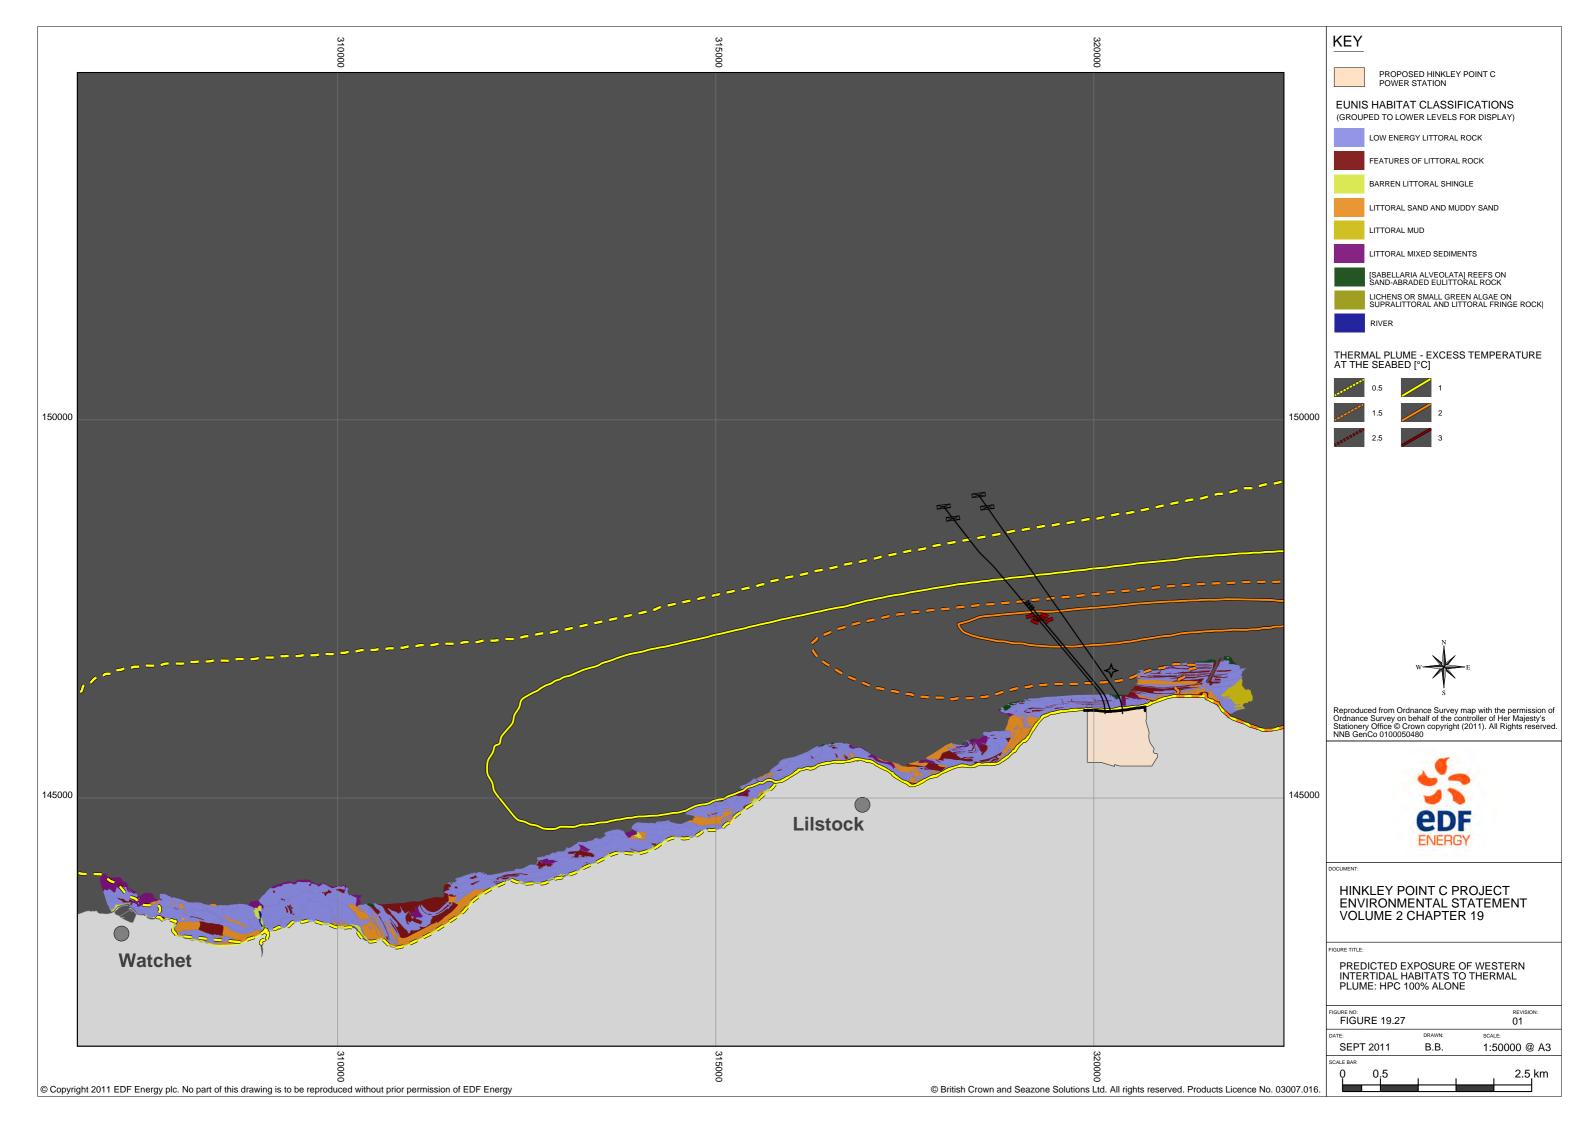


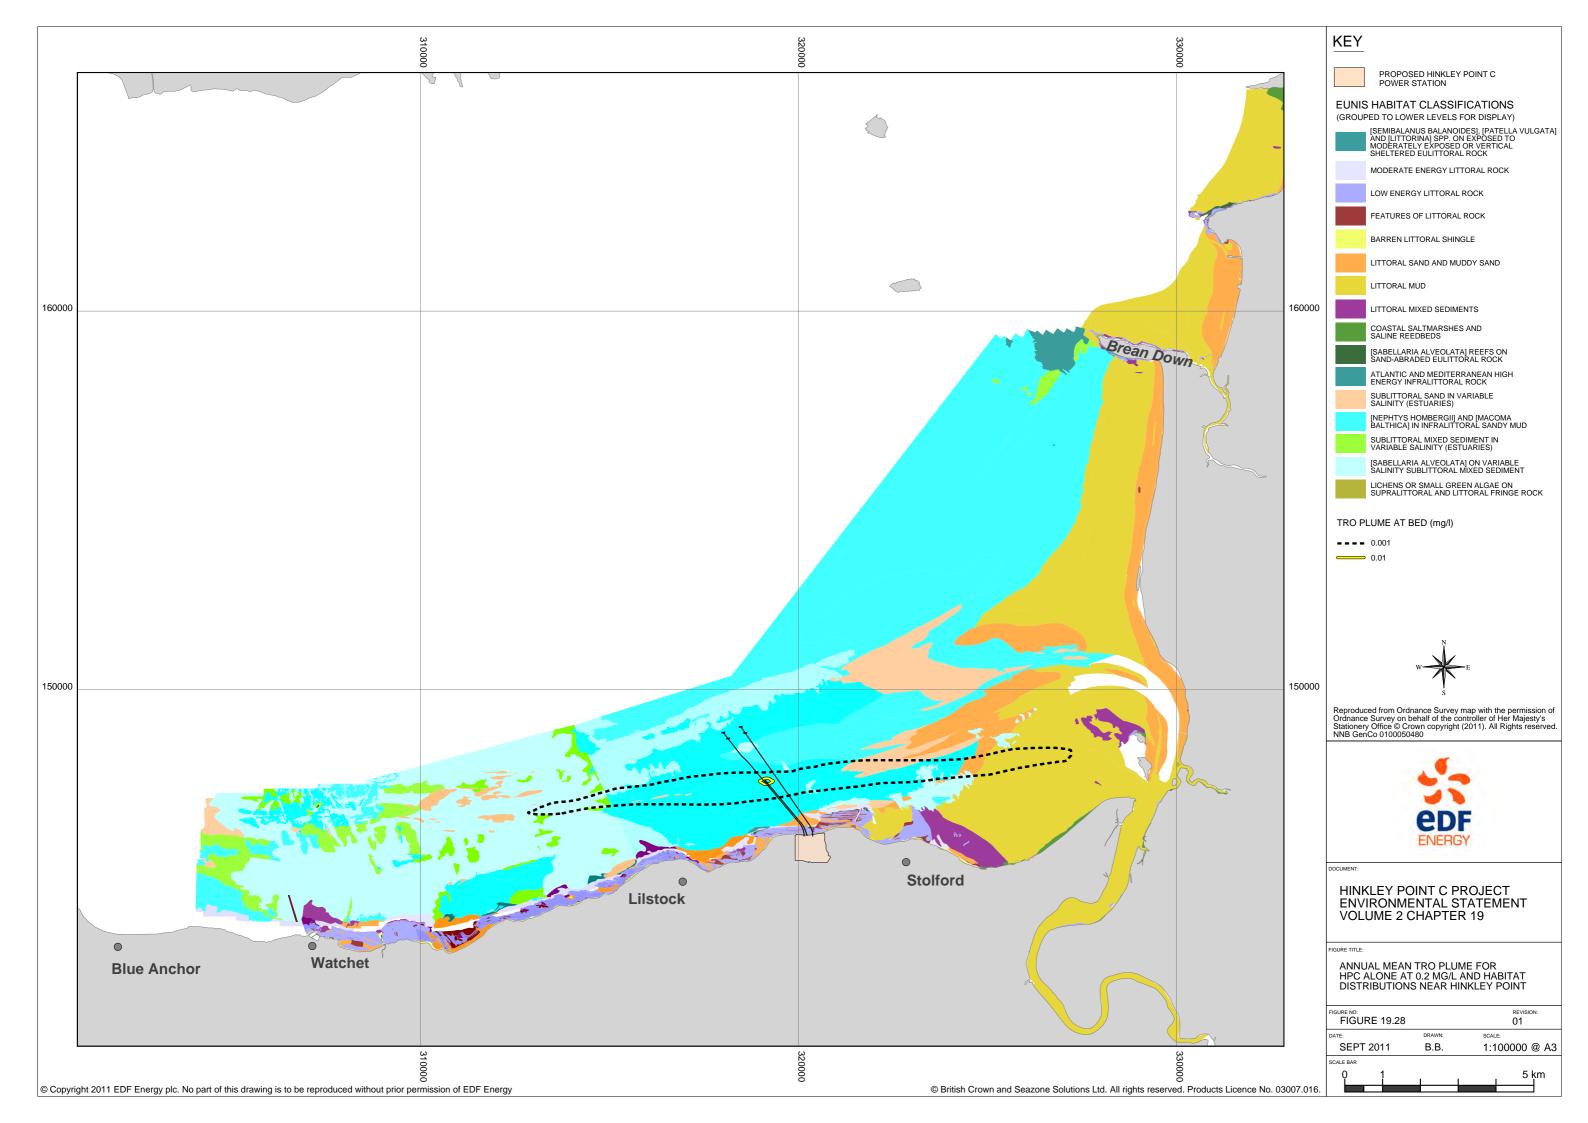


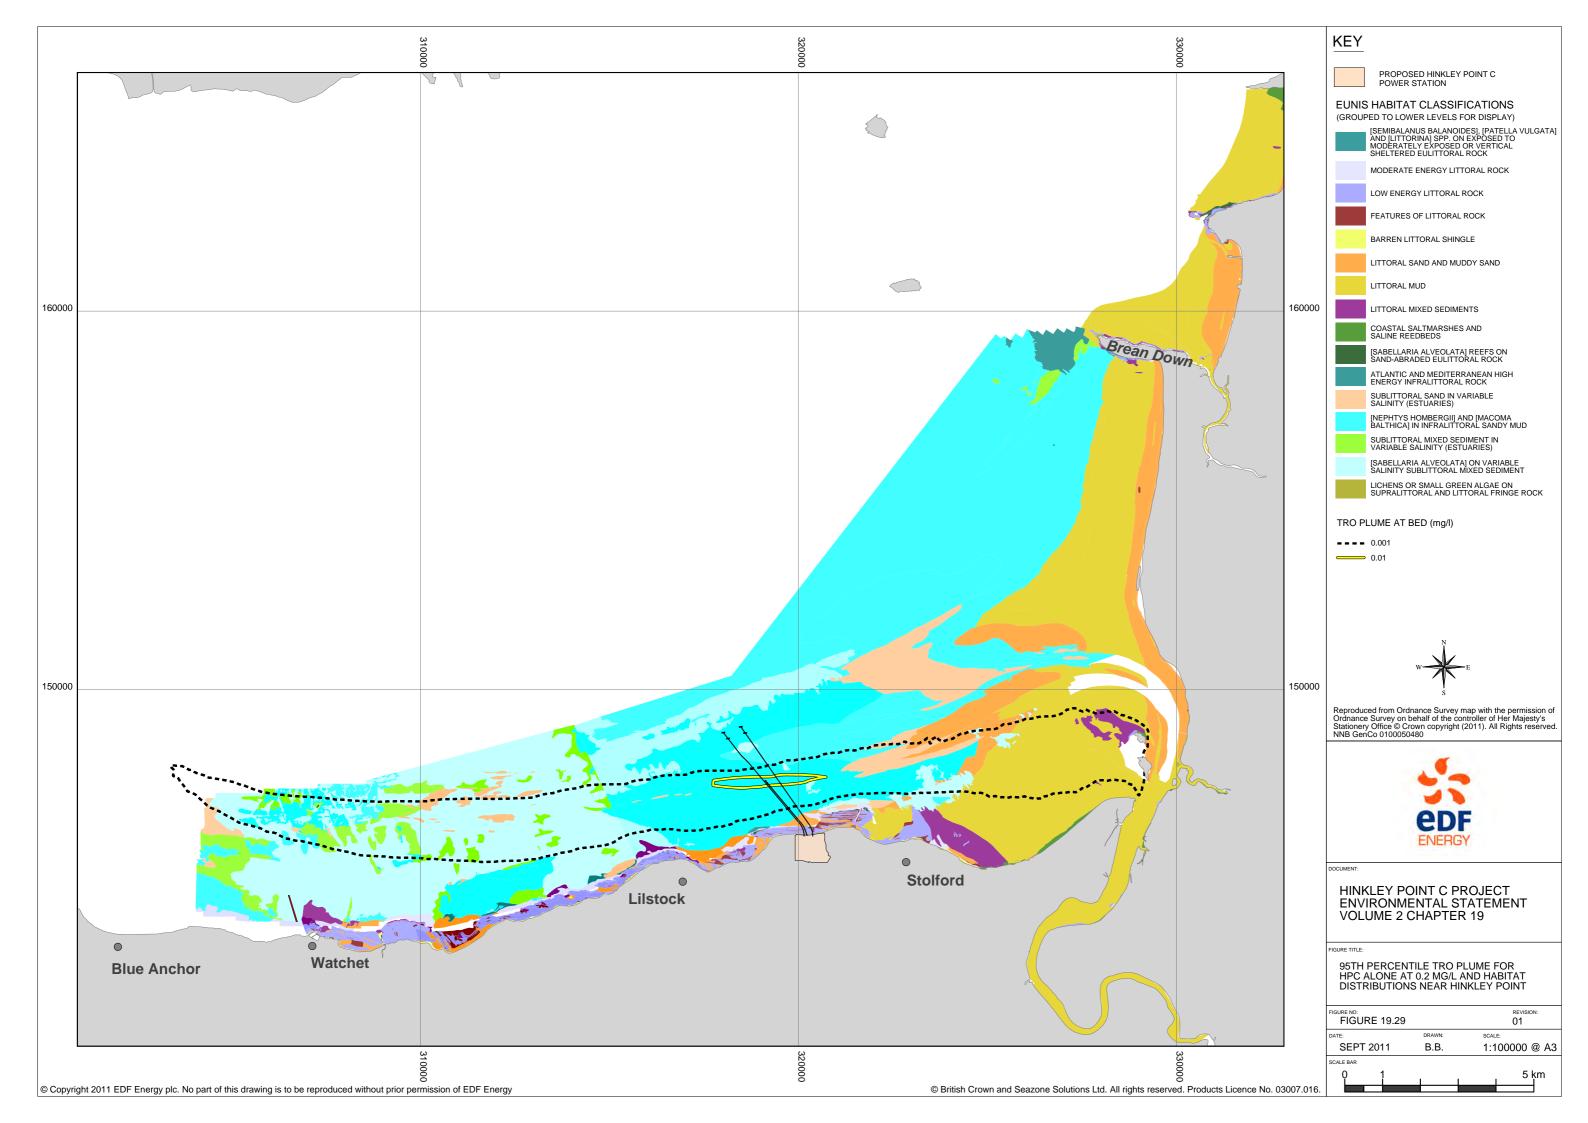


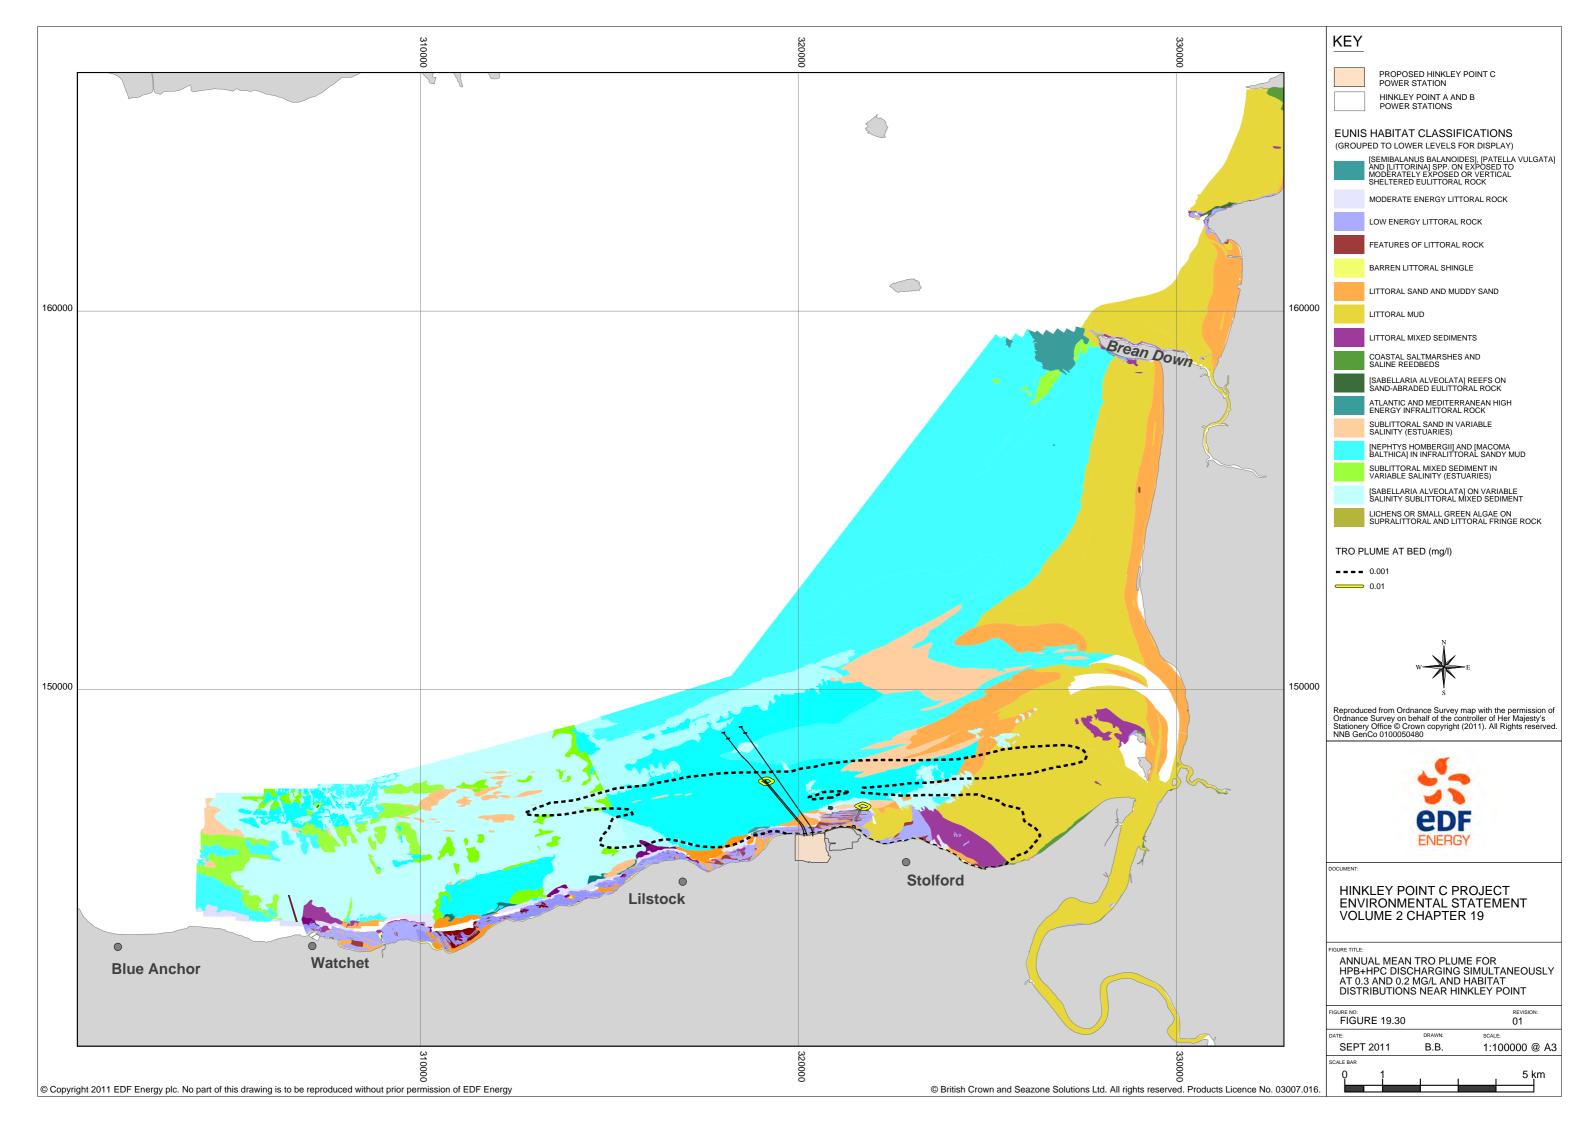


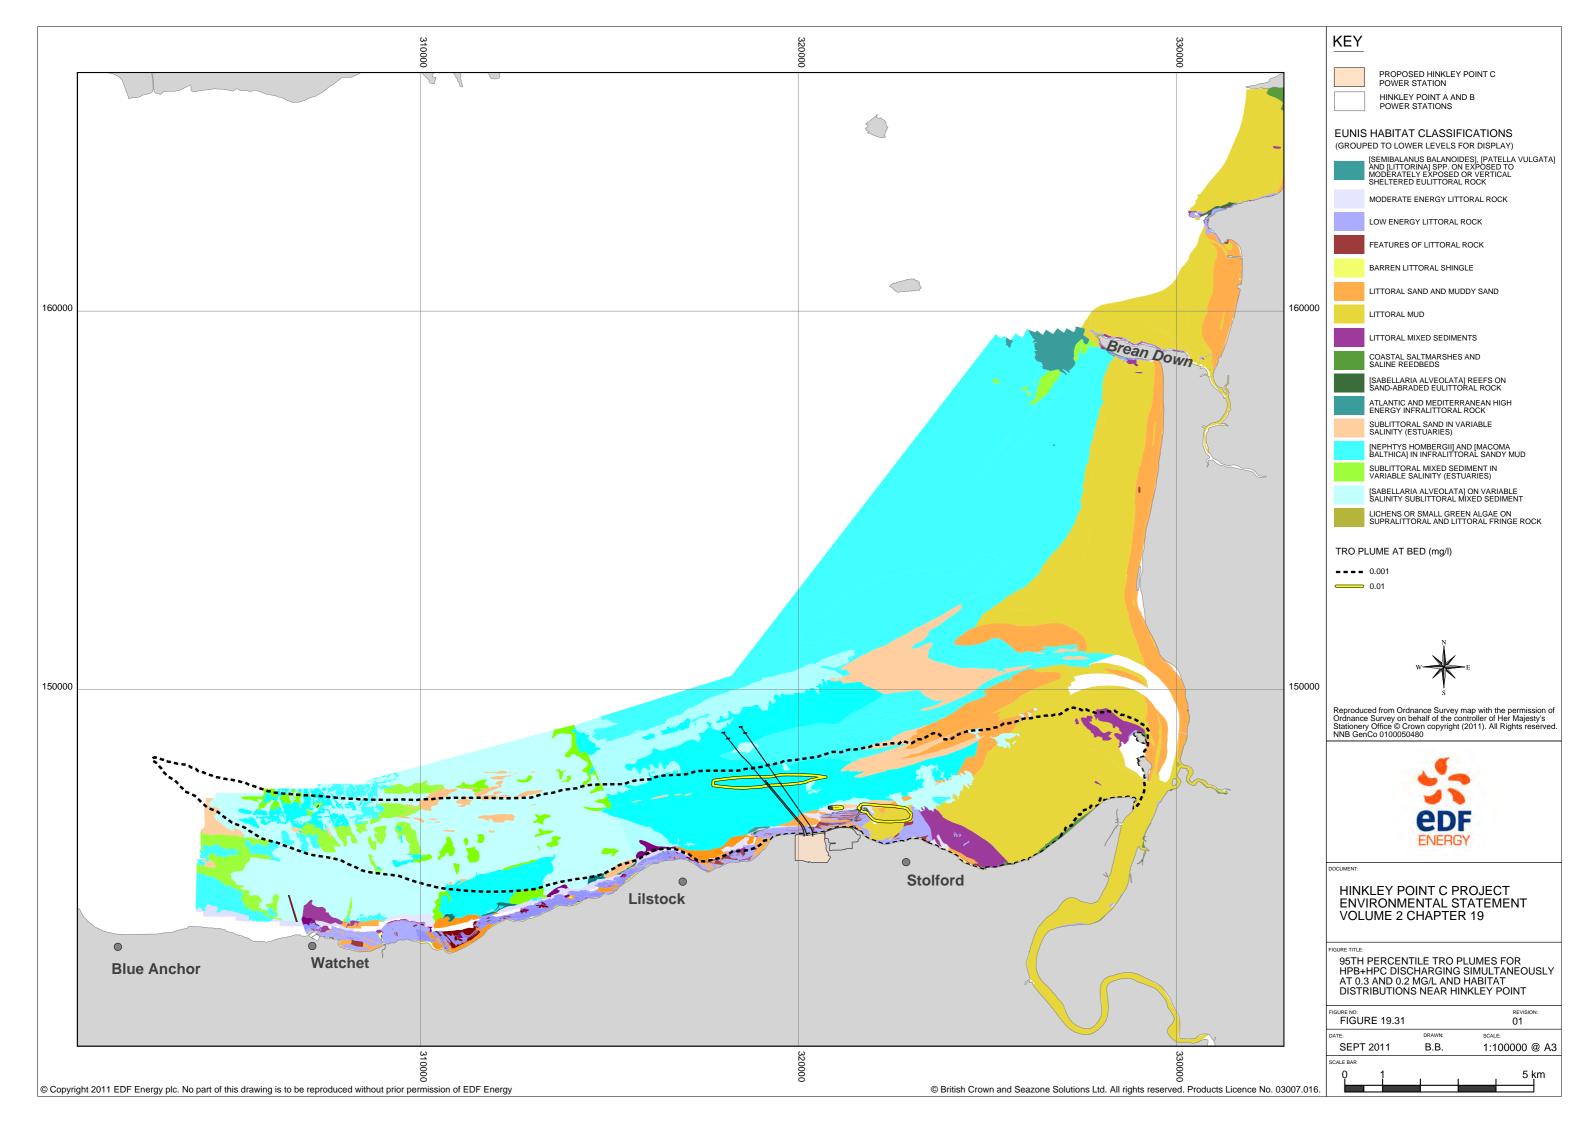


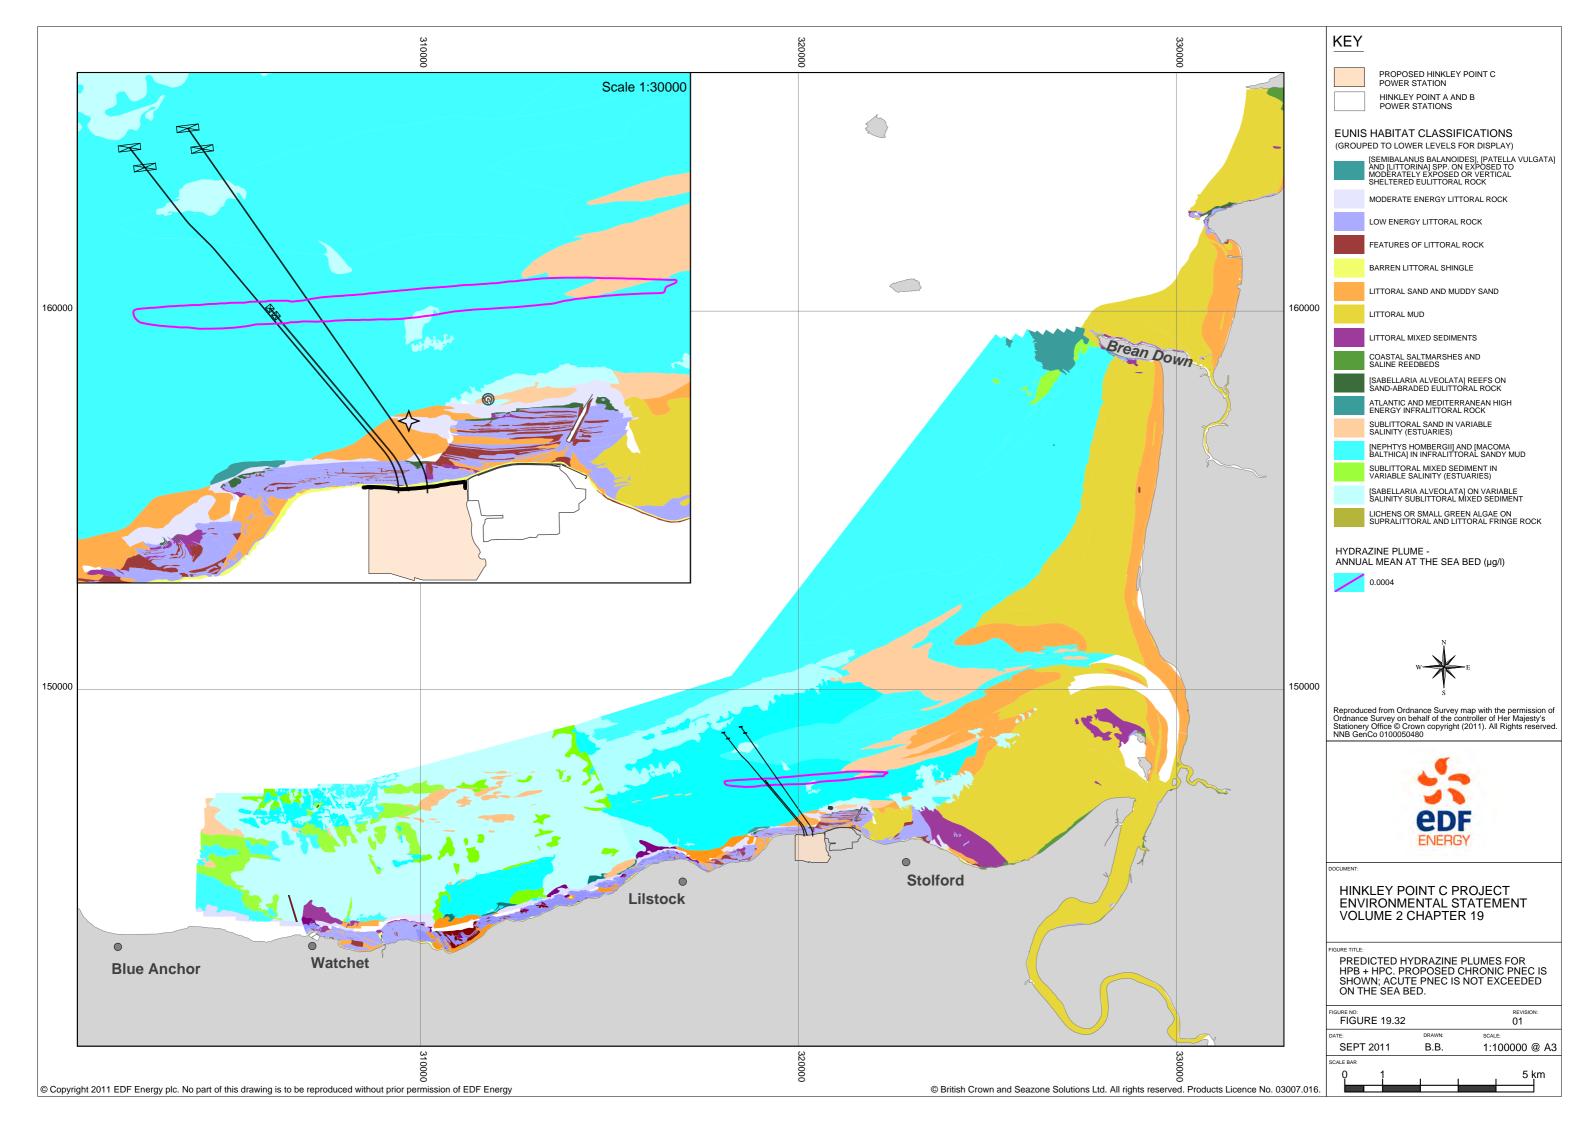


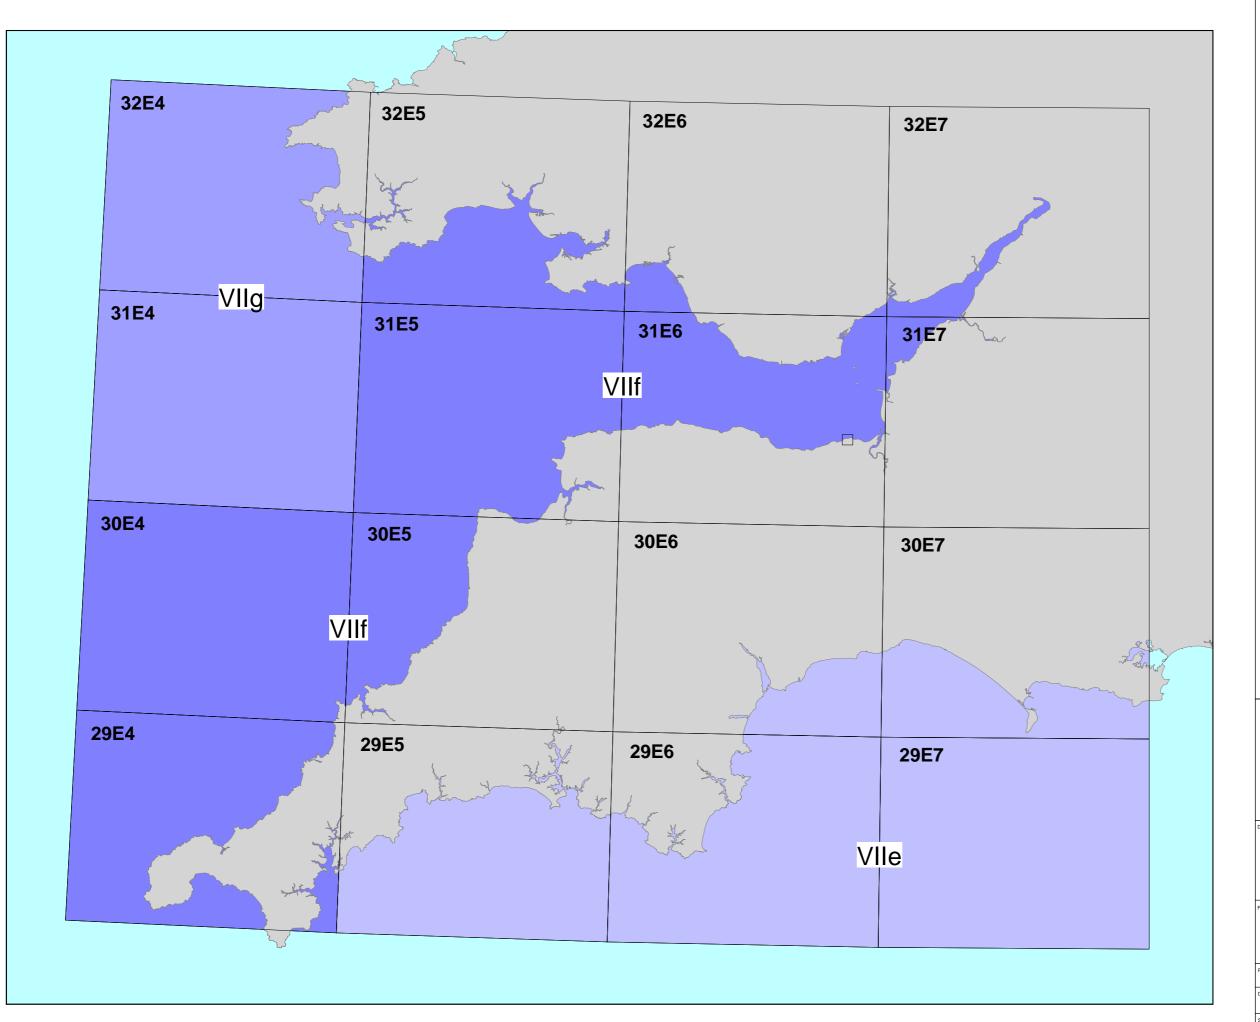


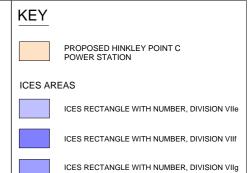














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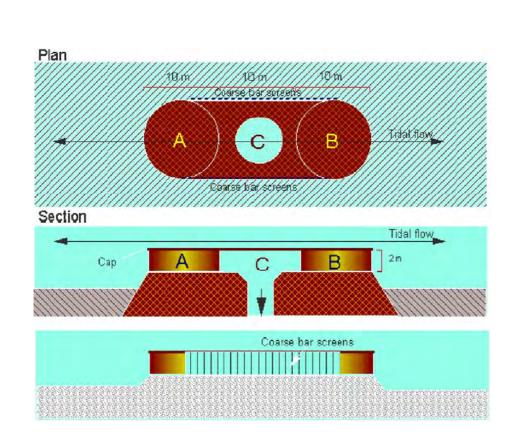
DOCUMENT


HINKLEY POINT C PROJECT ENVIRONMENTAL STATEMENT VOLUME 2 CHAPTER 19

FIGURE TITL

ICES STATISTICAL RECTANGLES FOR THE BRISTOL CHANNEL & SEVERN ESTUARY

FIGURE NO: FIGURE 19.33		REVISION:	
DATE: SEPT 2011	DRAWN: B.B.	SCALE: 1:1000000 @ A3	
SCALE BAR 0 10	1	50 km	



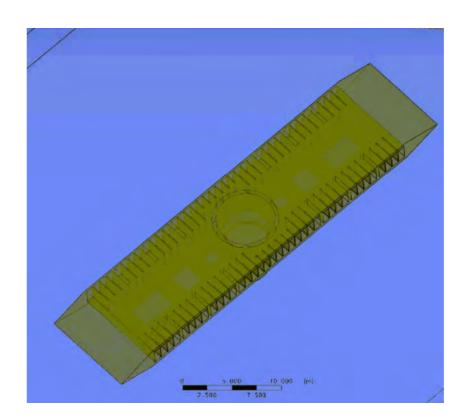



DOCUMENT

HINKLEY POINT C PROJECT ENVIRONMENTAL STATEMENT VOLUME 2 CHAPTER 19

FIGURE TITLE:


ORIGINAL LVSE (LEFT) & EDF HPC LVSE (RIGHT) INTAKE DESIGNS

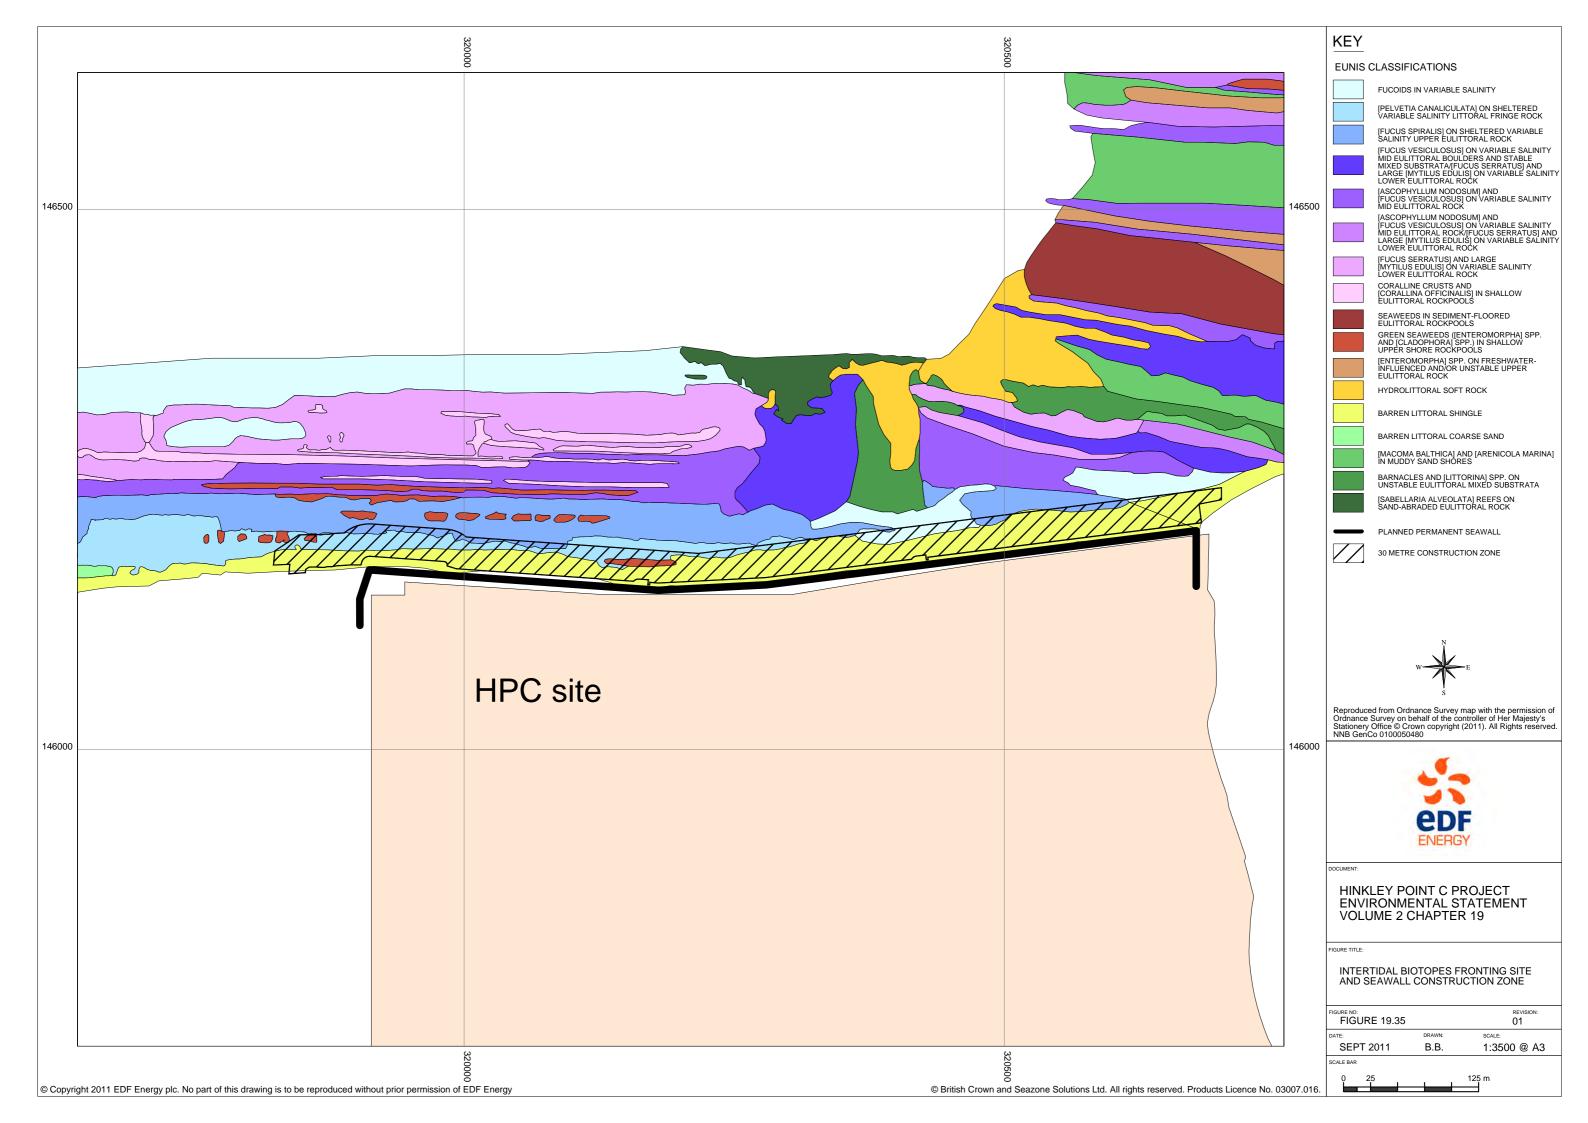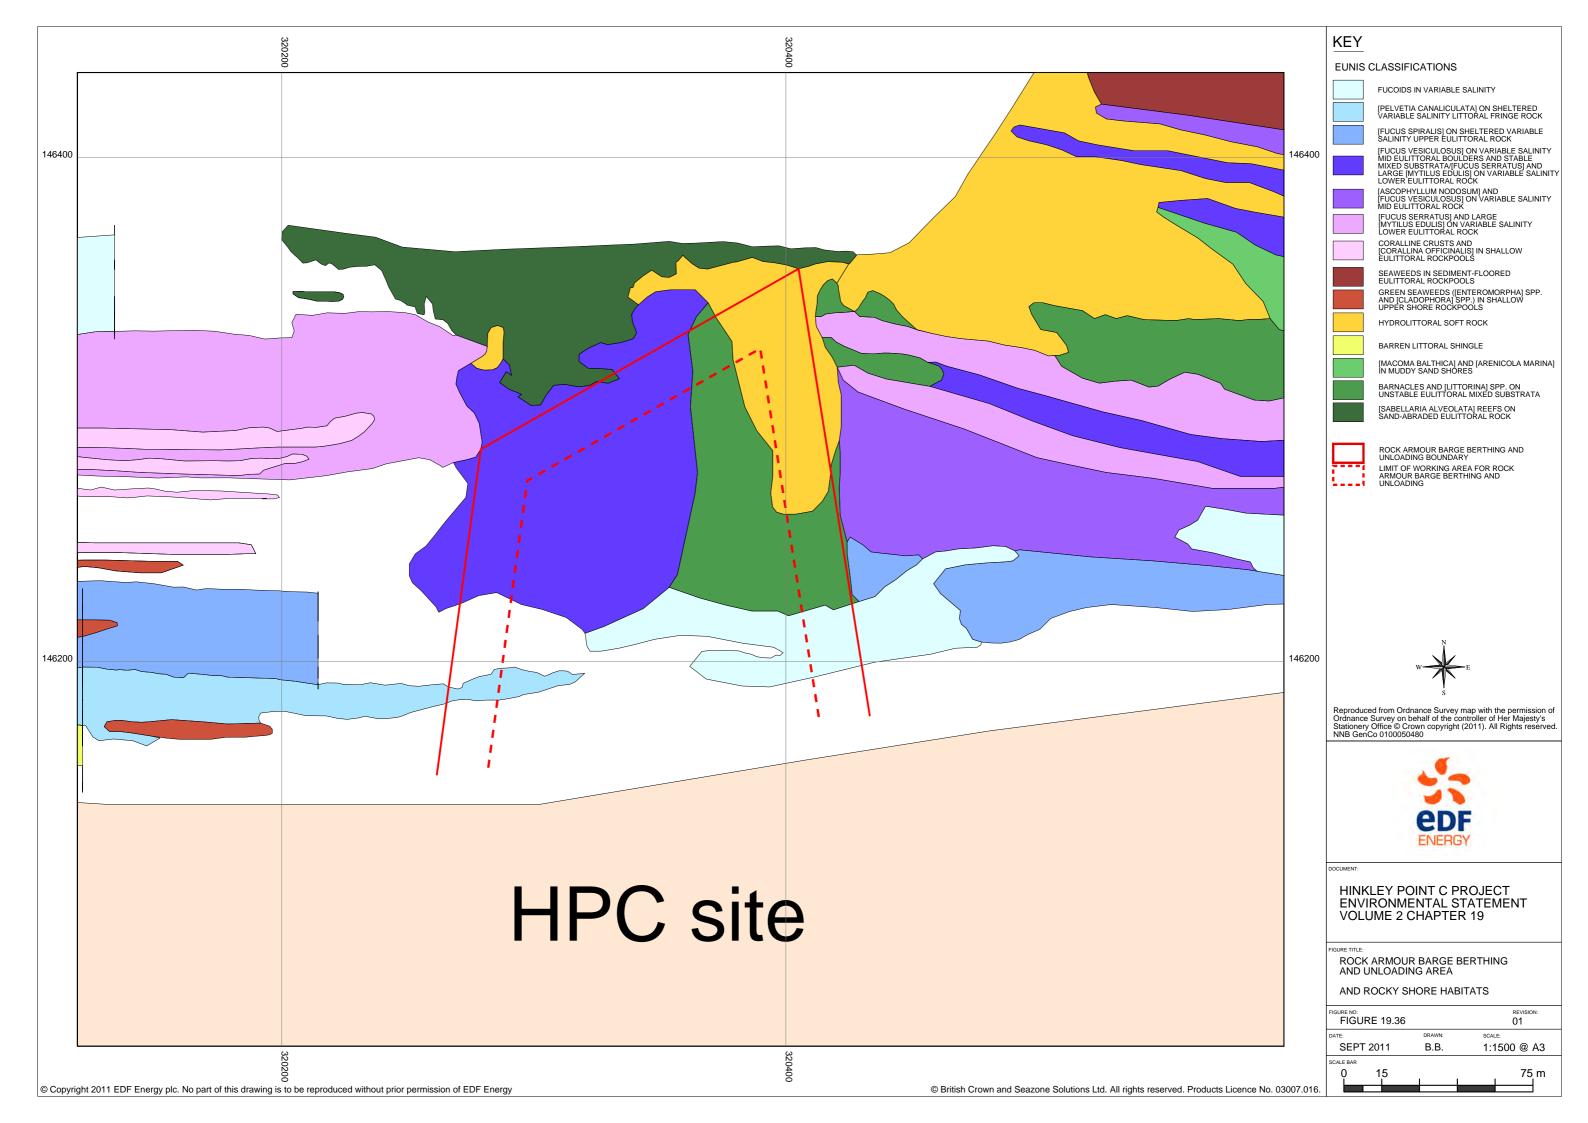
FIGURE NO: REVISION: 01

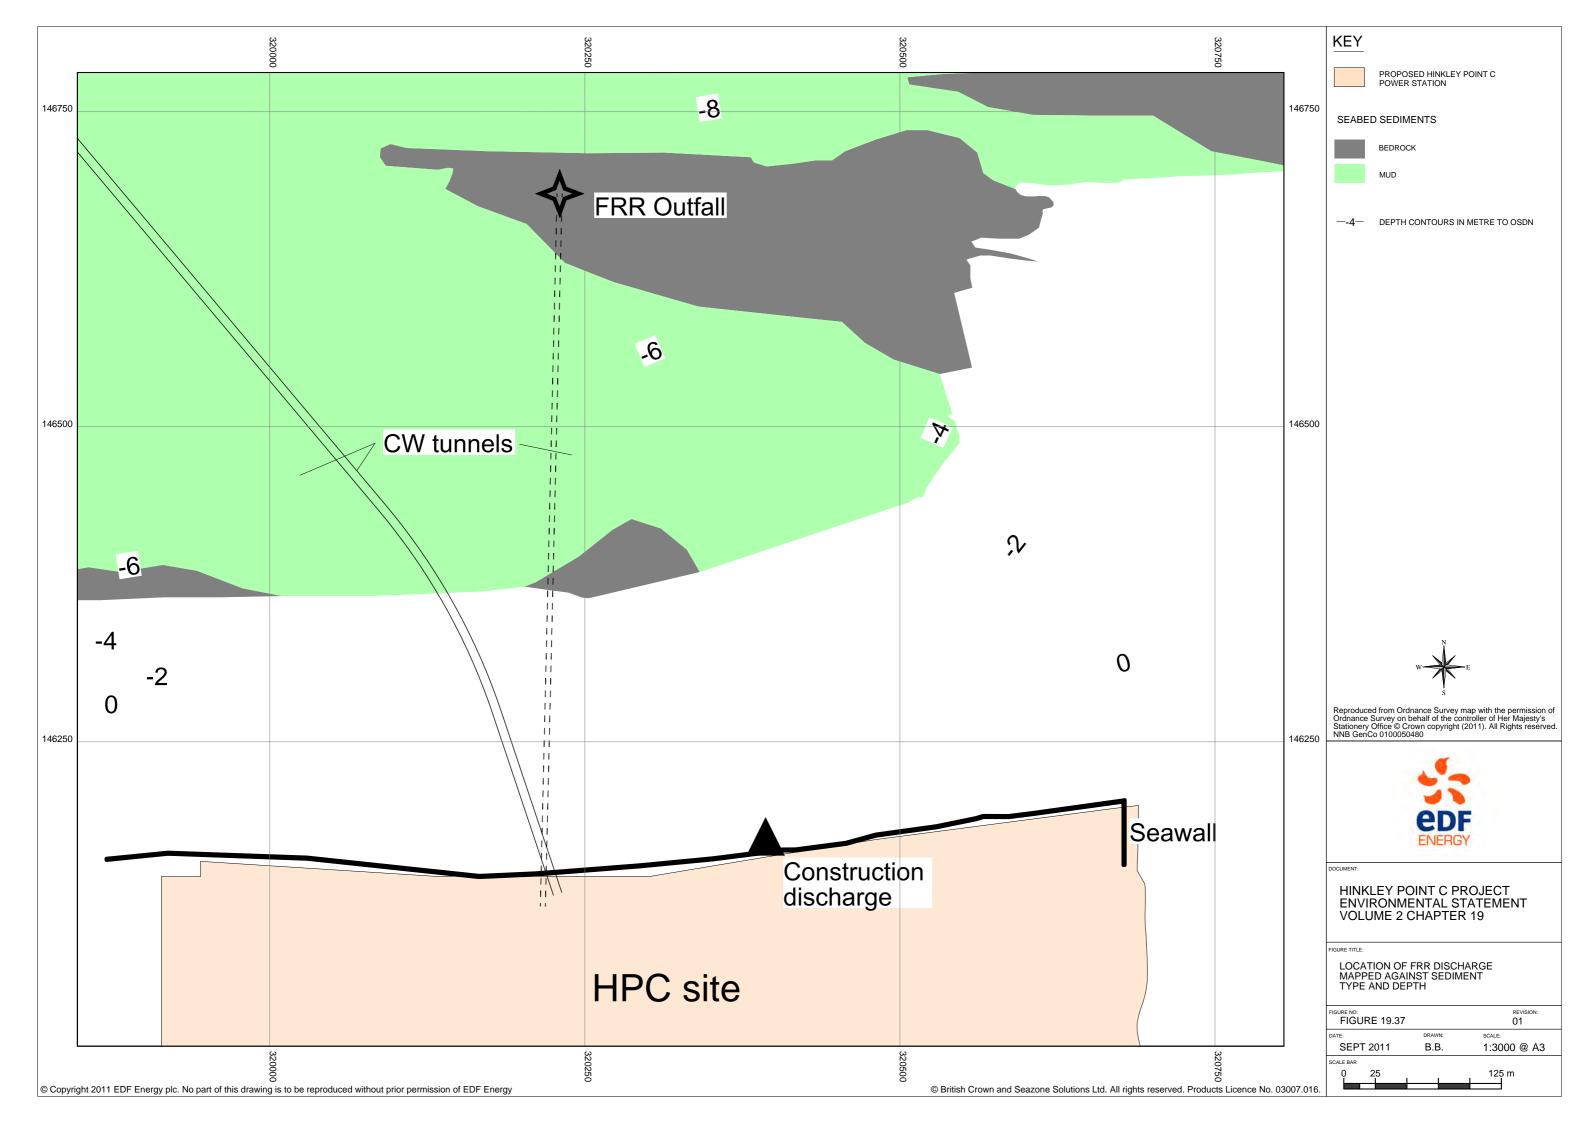
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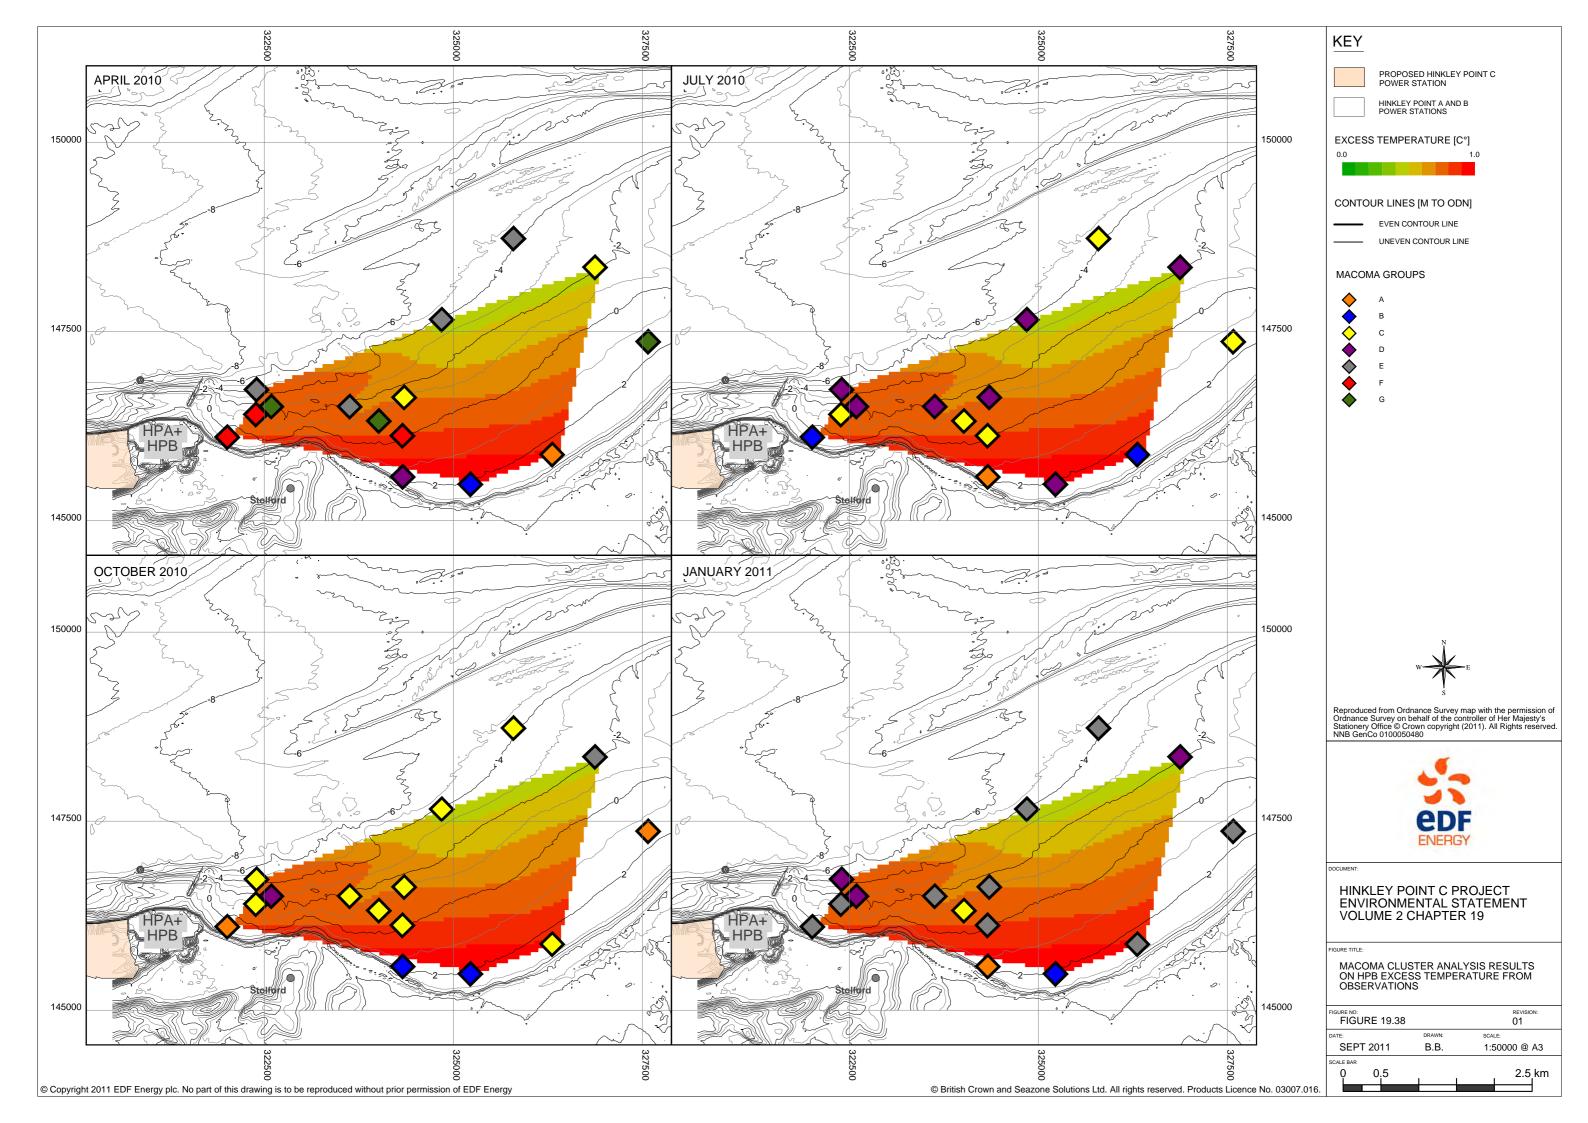
SEPT 2011 B.B.


SCALE BAR













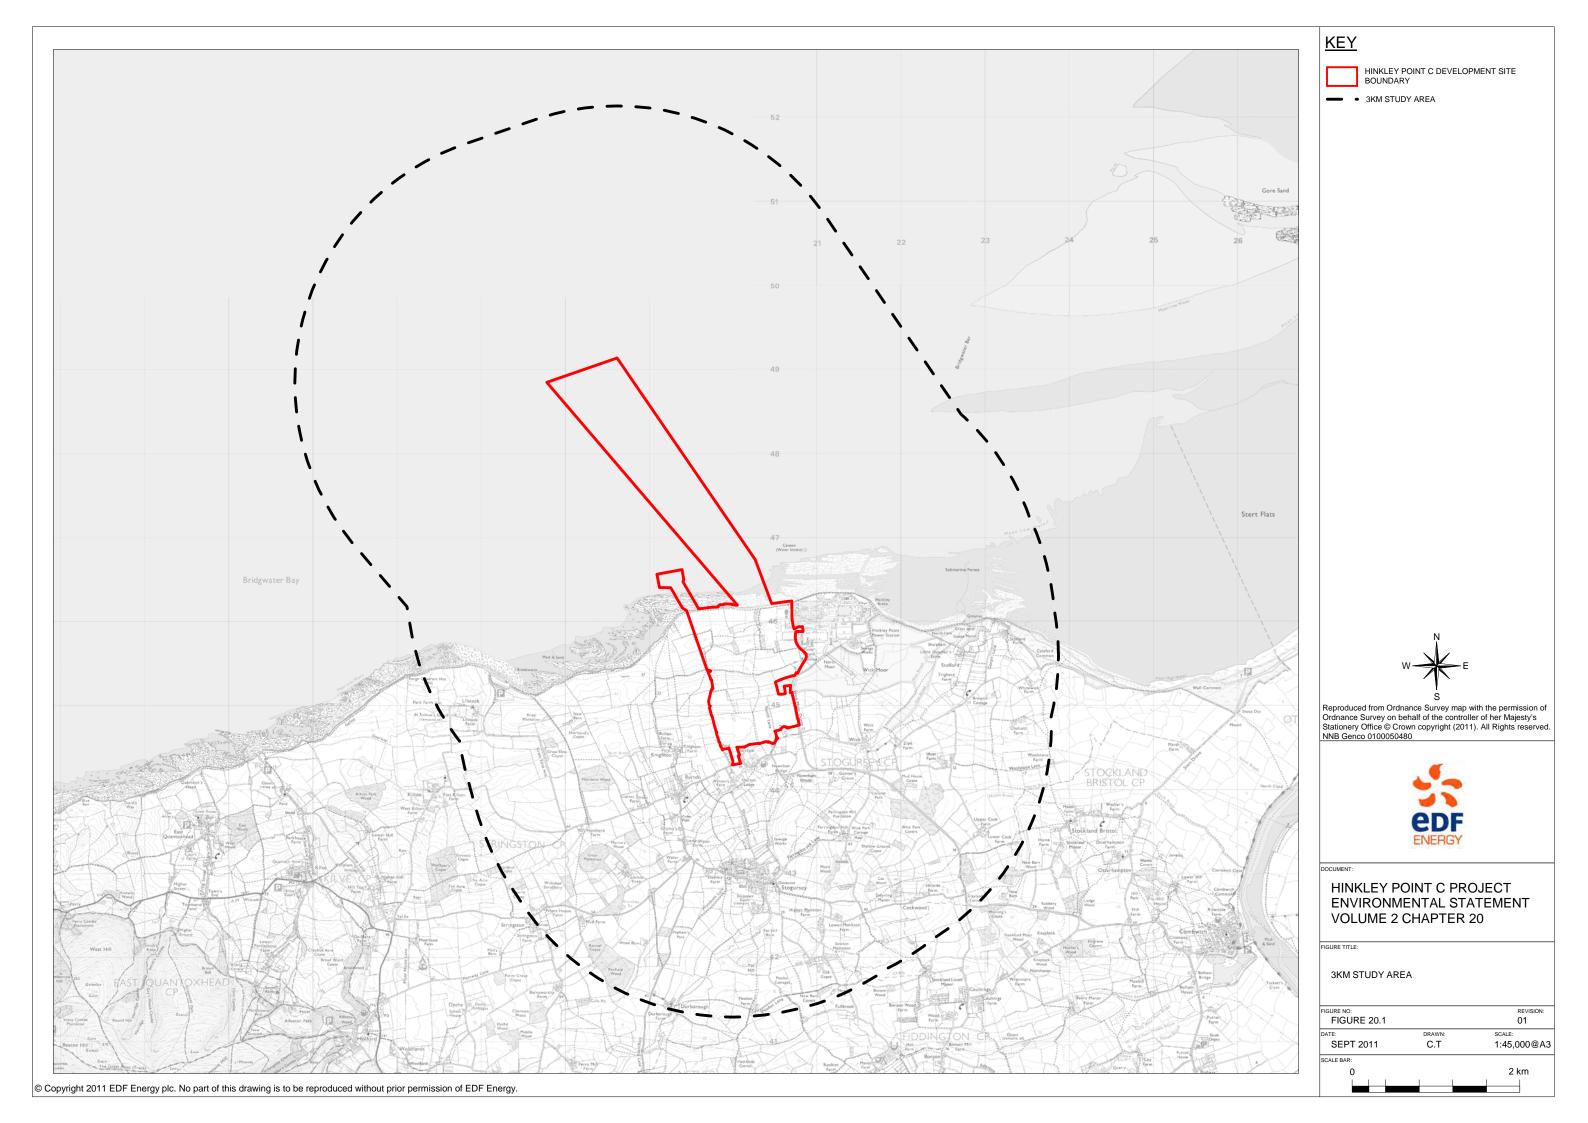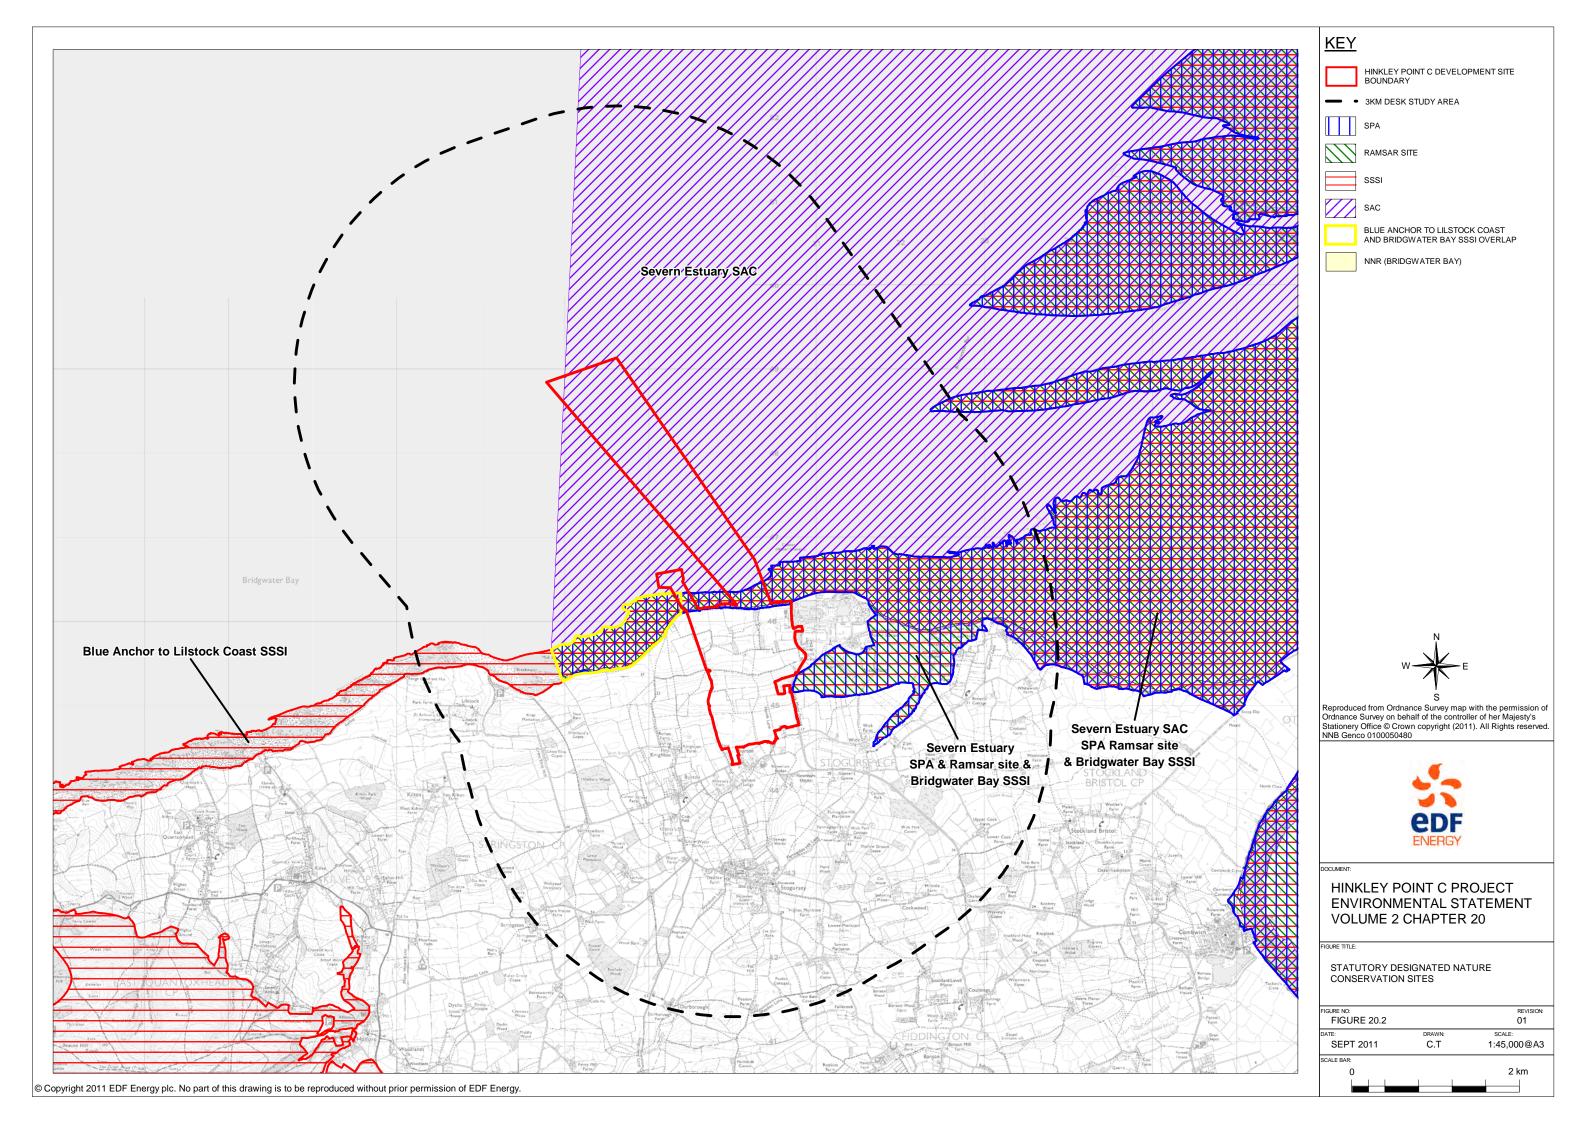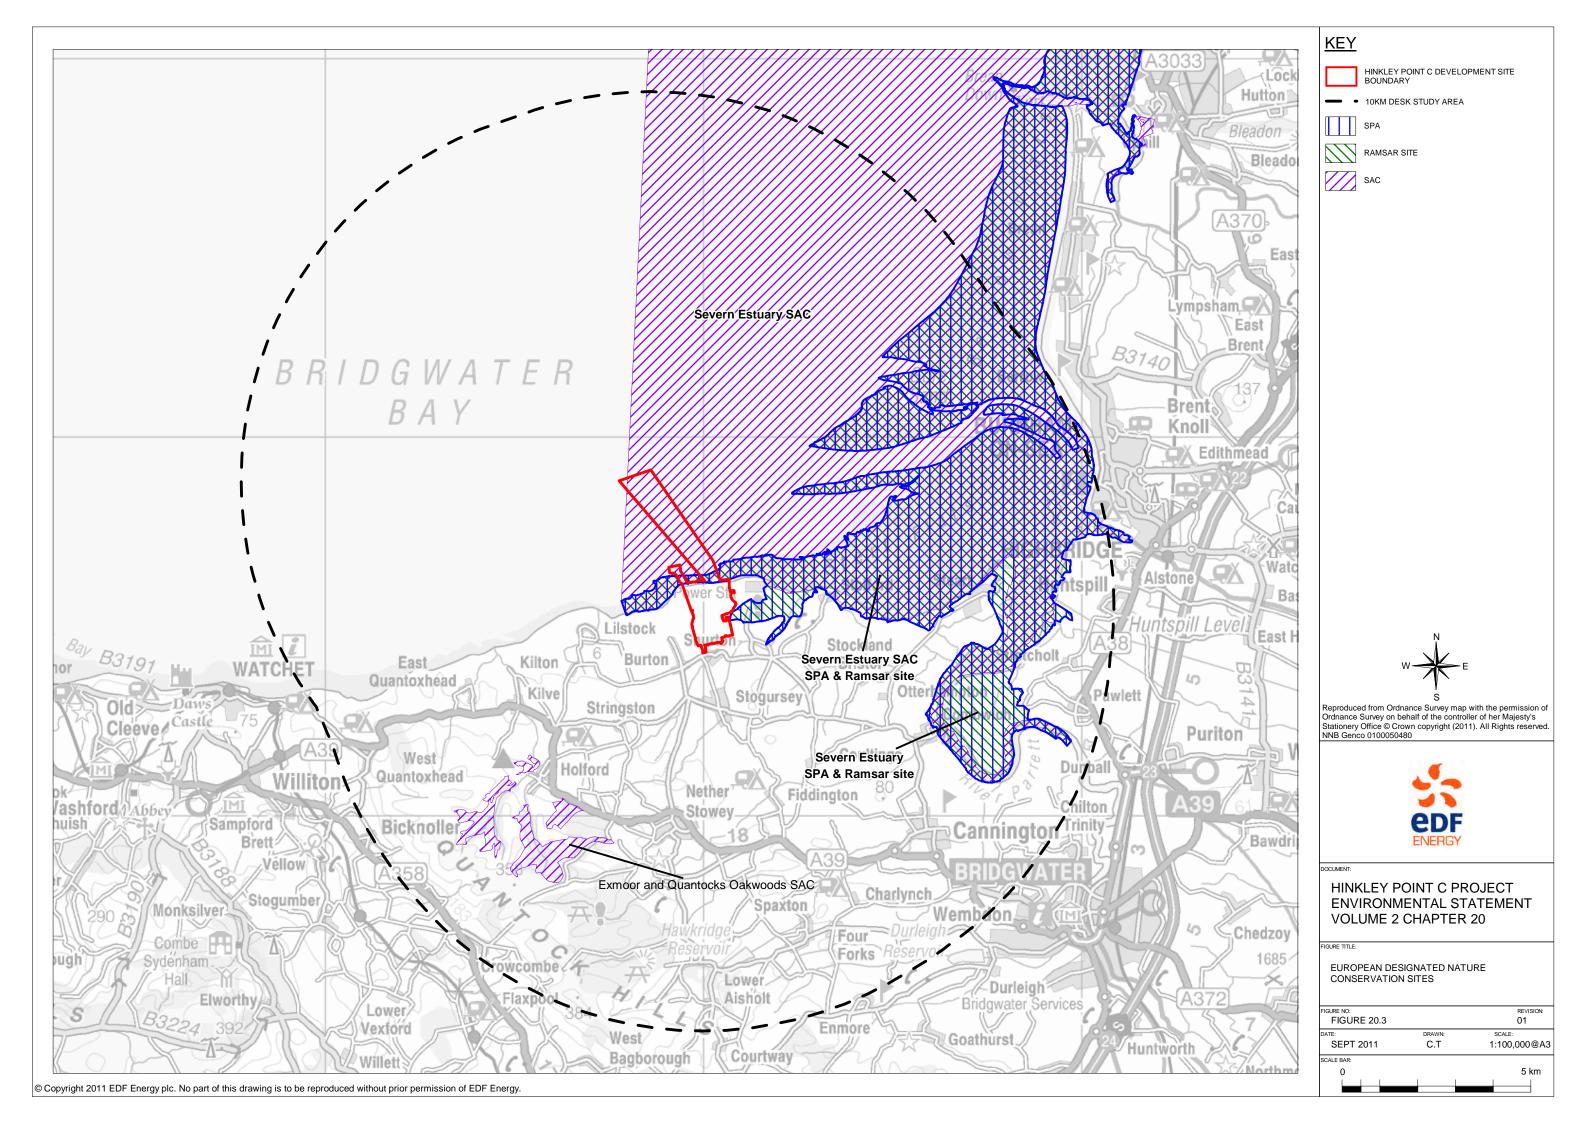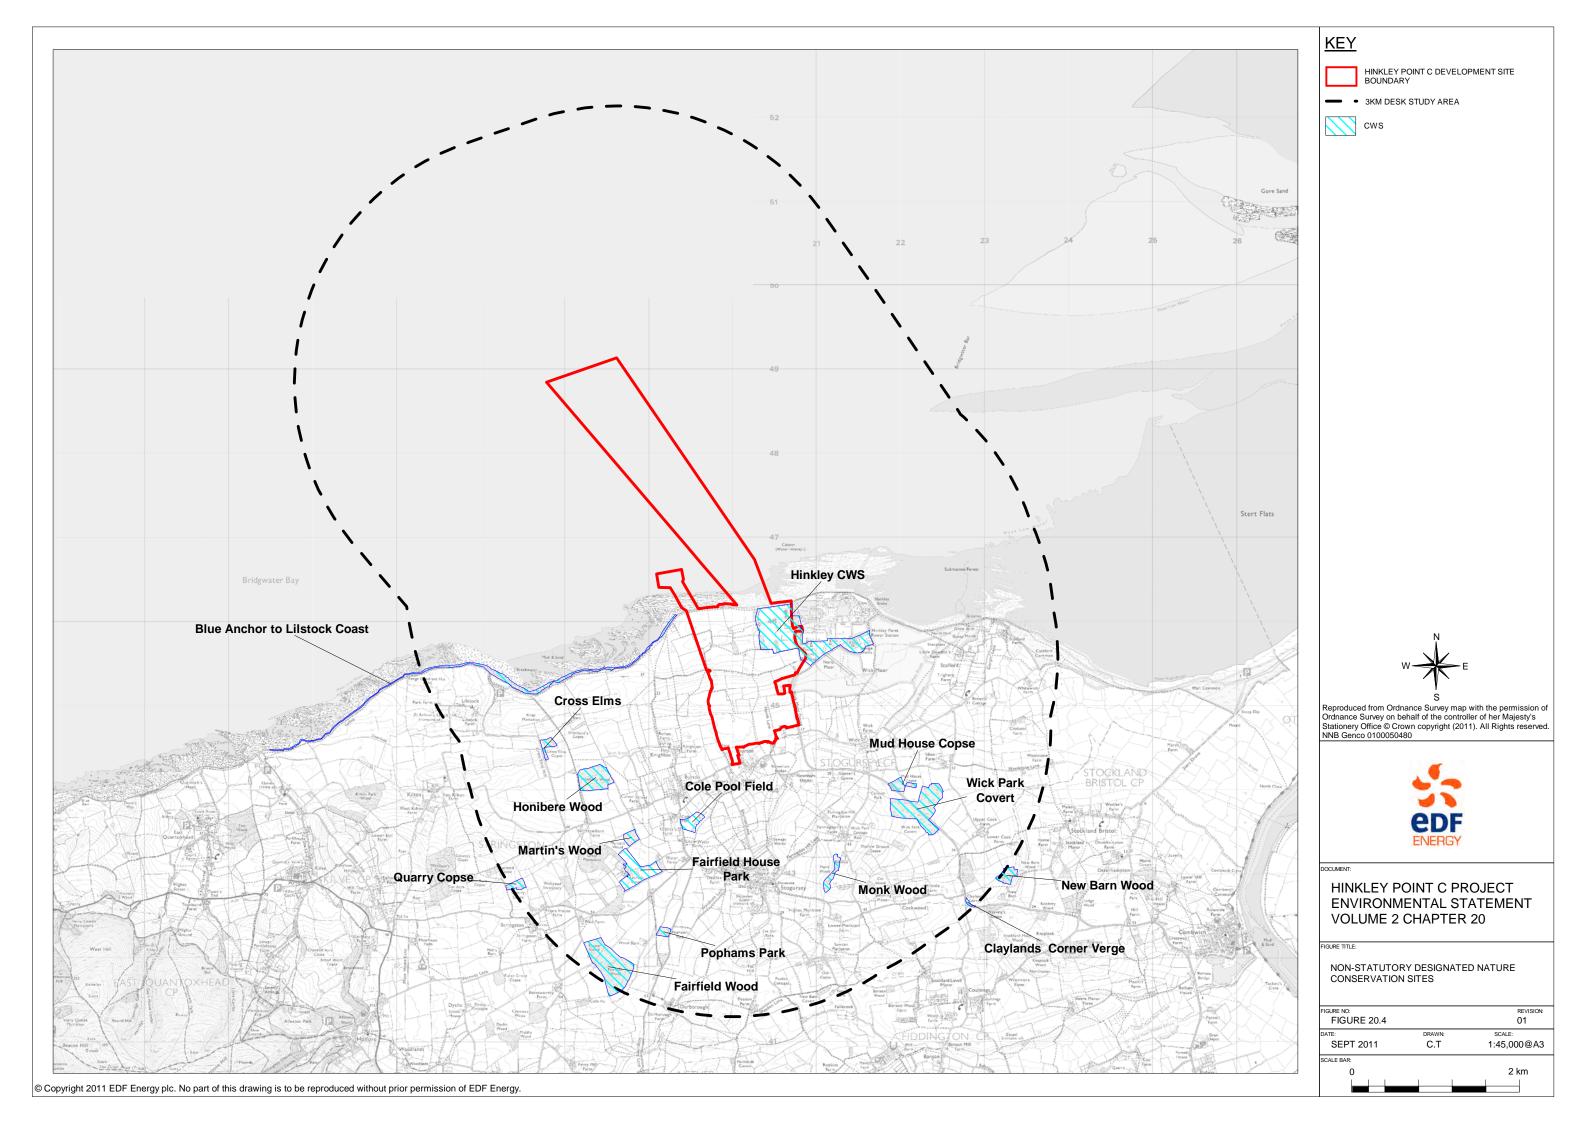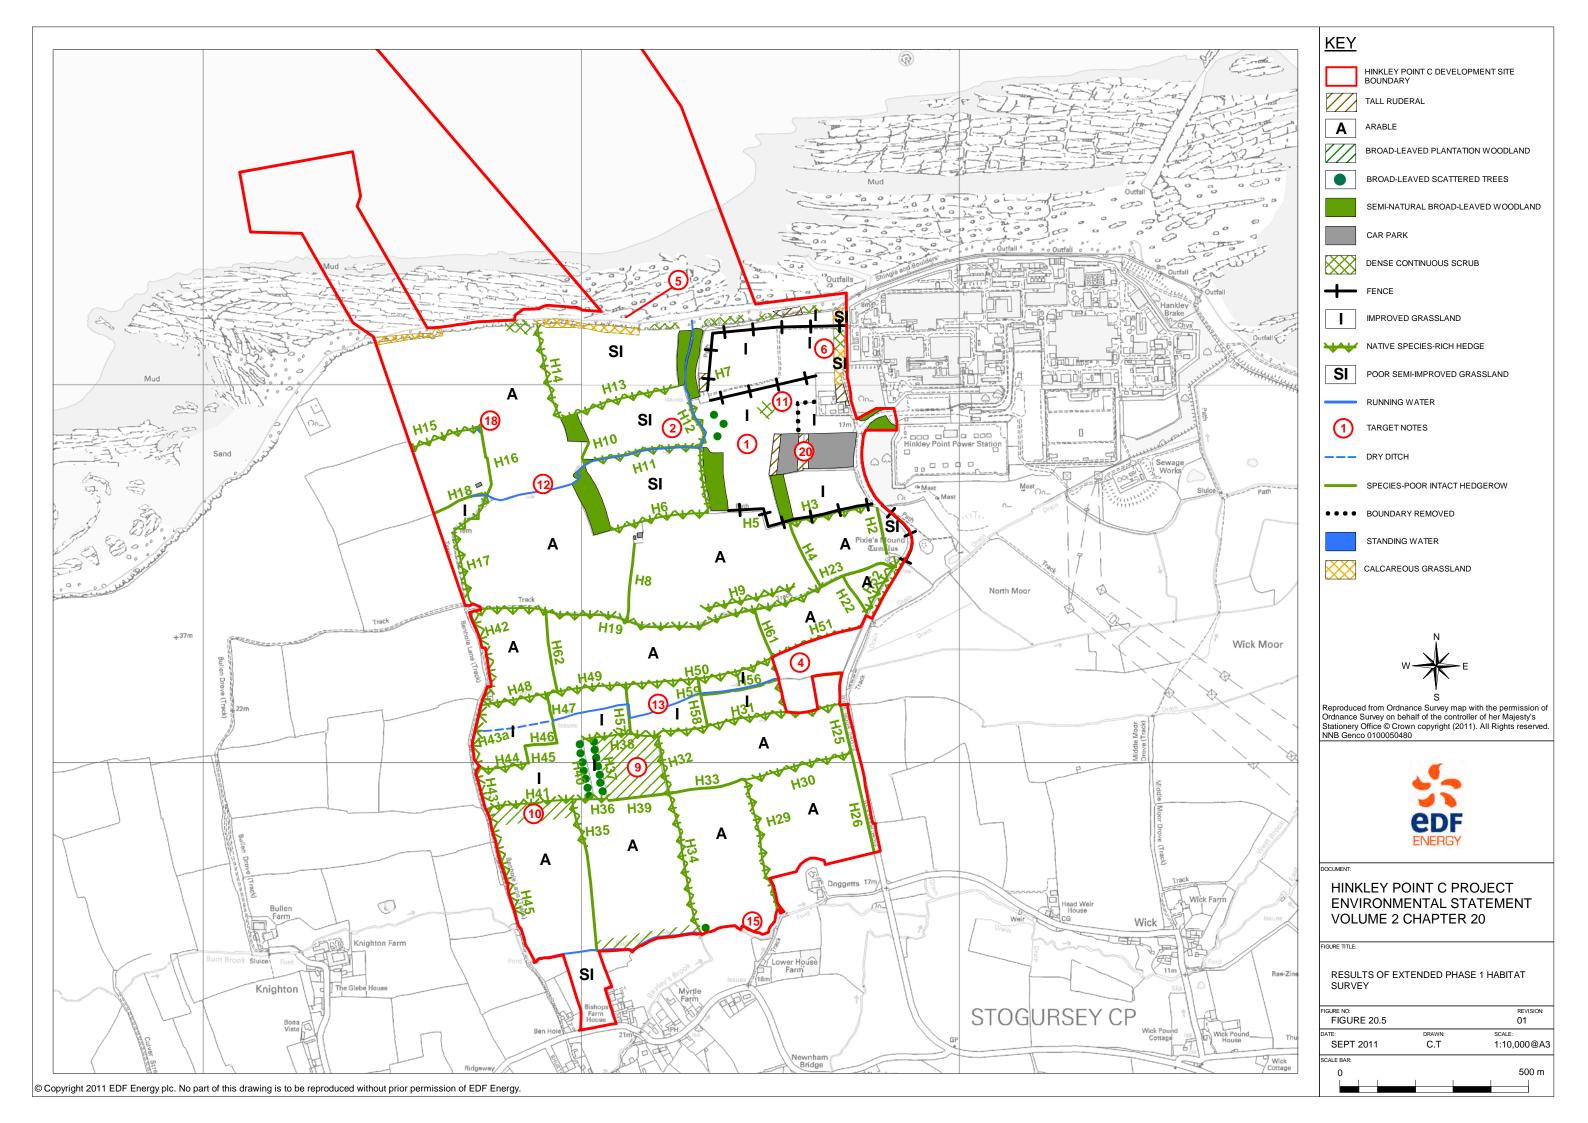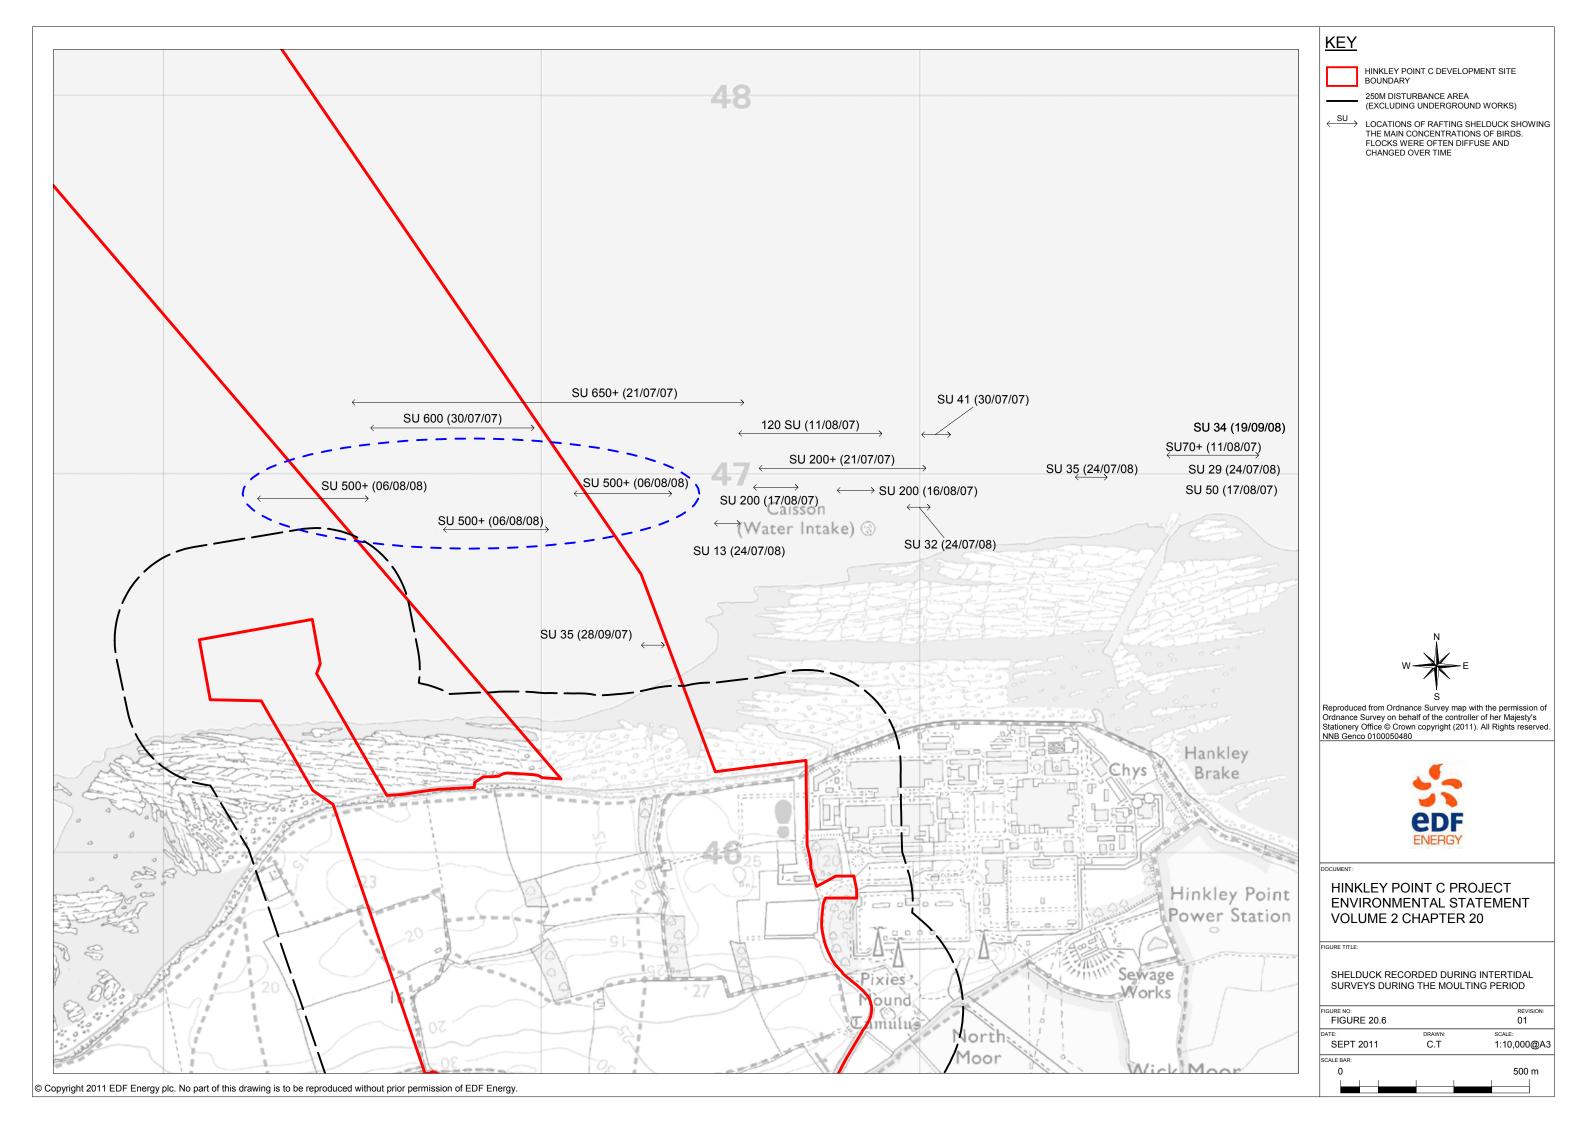


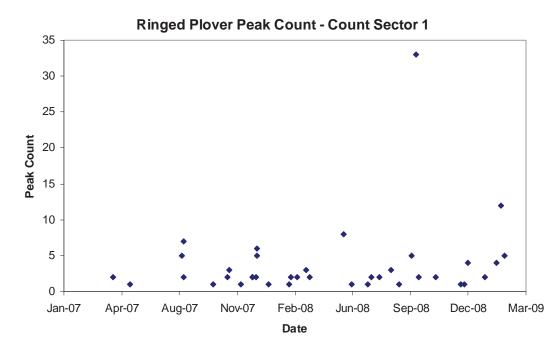


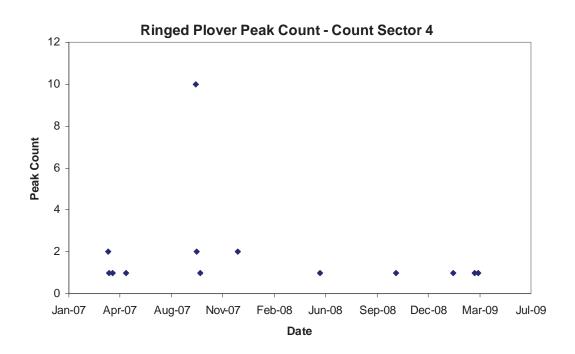


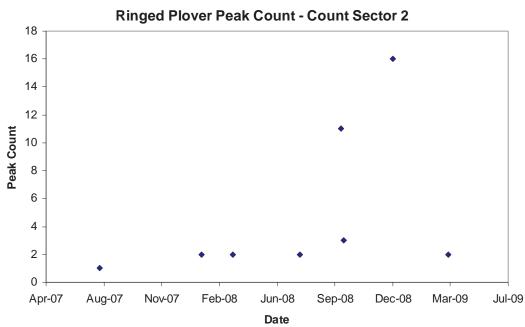


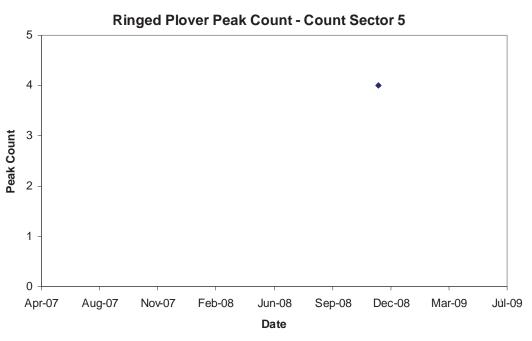


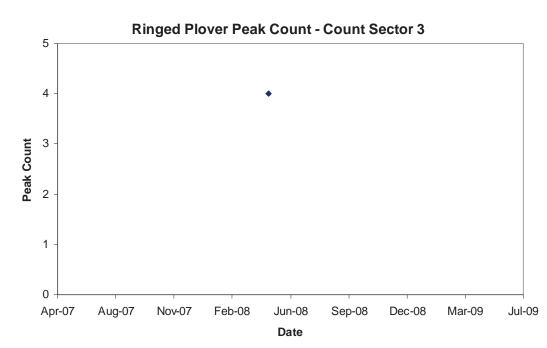












Severn Estuary Population 655 (1% = 6.6 birds)



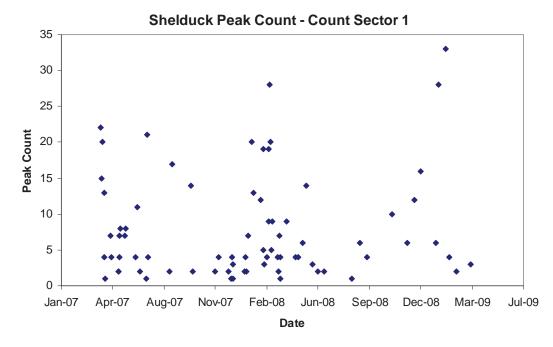
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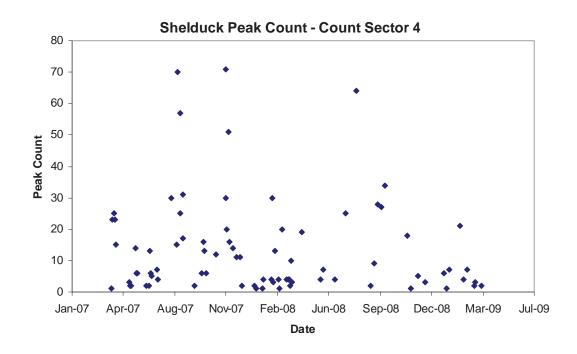
HINKLEY POINT C PROJECT ENVIRONMENTAL STATEMENT VOLUME 2 CHAPTER 20

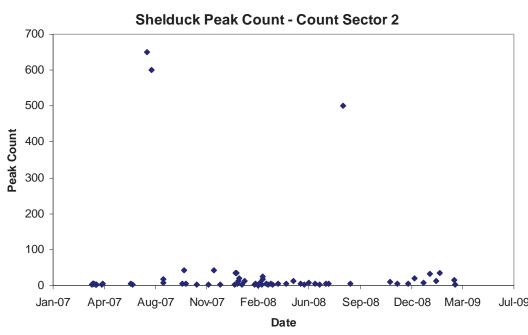
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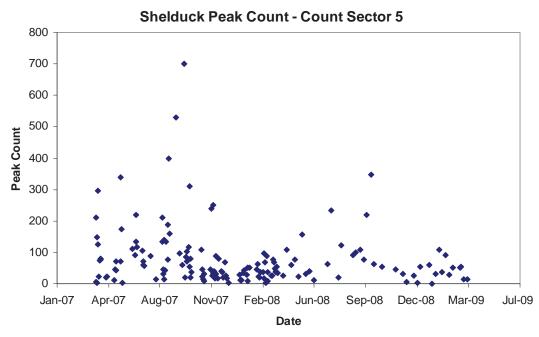
RINGED PLOVER PEAK COUNT DATA


FIGURE 20.7		REVISION: 01
SEPT 11	J.P.	SCALE:
SCALE BAR		









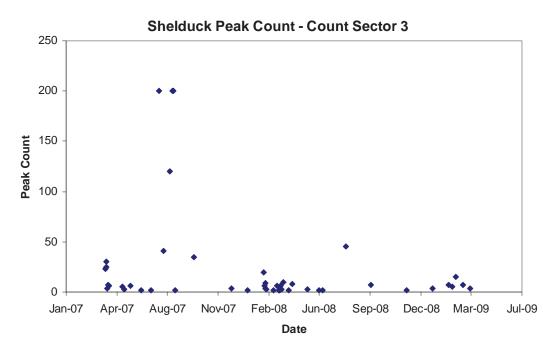

Severn Estuary Population 3,330 (1% = 33.3 birds)



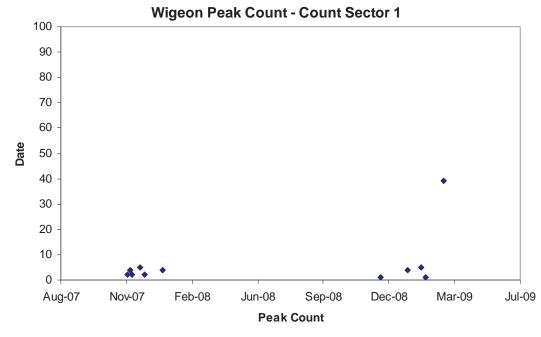
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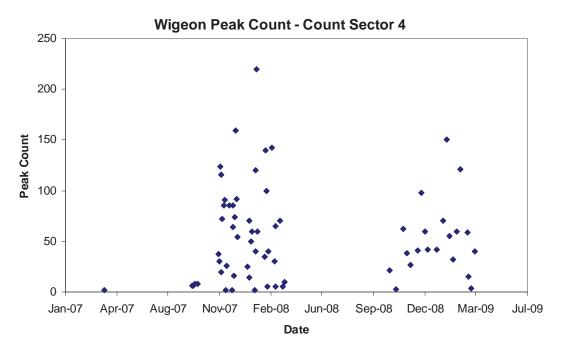
HINKLEY POINT C PROJECT ENVIRONMENTAL STATEMENT VOLUME 2 CHAPTER 20

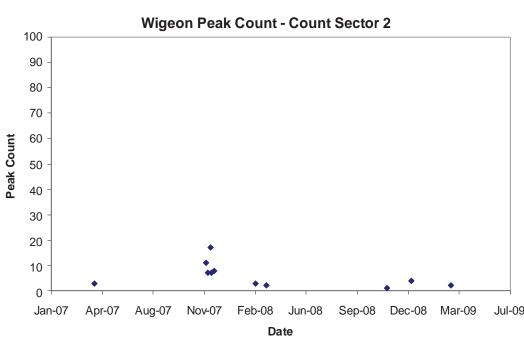
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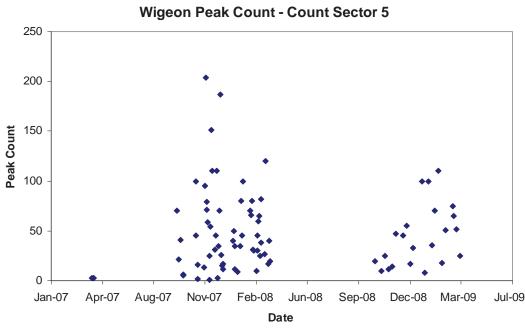
SHELDUCK PEAK COUNT DATA


FIGURE 20.8		01	
SEPT 11	J.P.	SCALE:	
SCALE BAR			









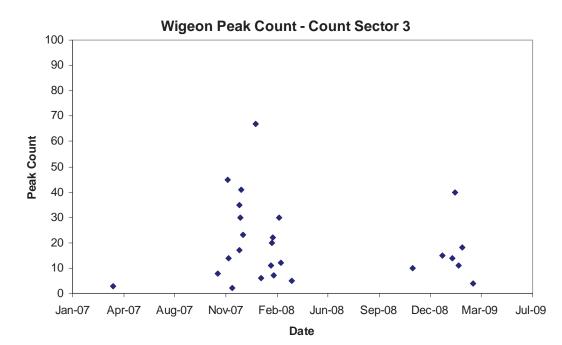

Severn Estuary Population 8,466 (1% = 84.7 birds)



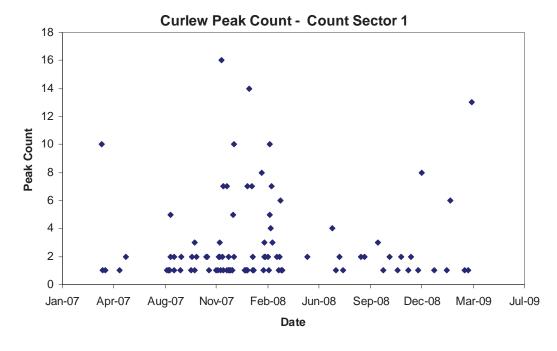
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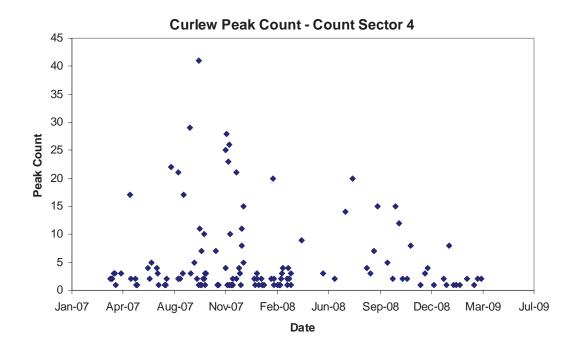
HINKLEY POINT C PROJECT ENVIRONMENTAL STATEMENT VOLUME 2 CHAPTER 20

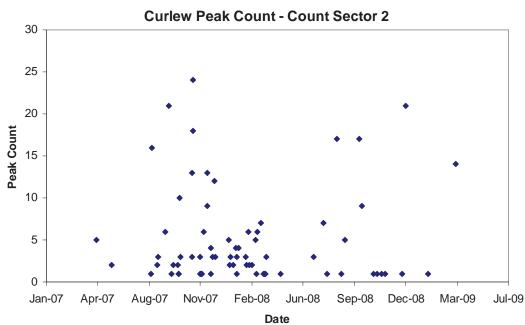
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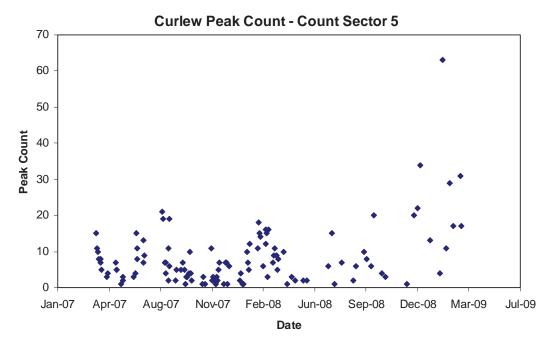
WIGEON PEAK COUNT DATA


FIGURE 20.9		REVISION: 01
DATE: SEPT 11	J.P.	SCALE:
SCALE BAR		









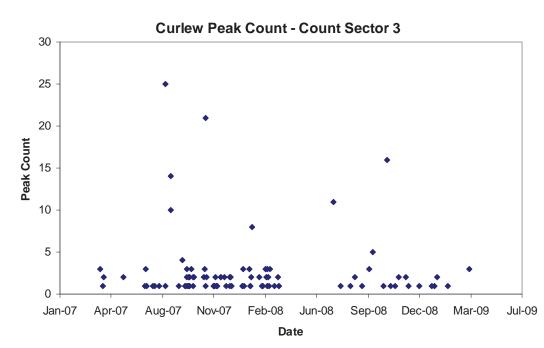

Severn Estuary Population 3,903 (1% = 39 birds)



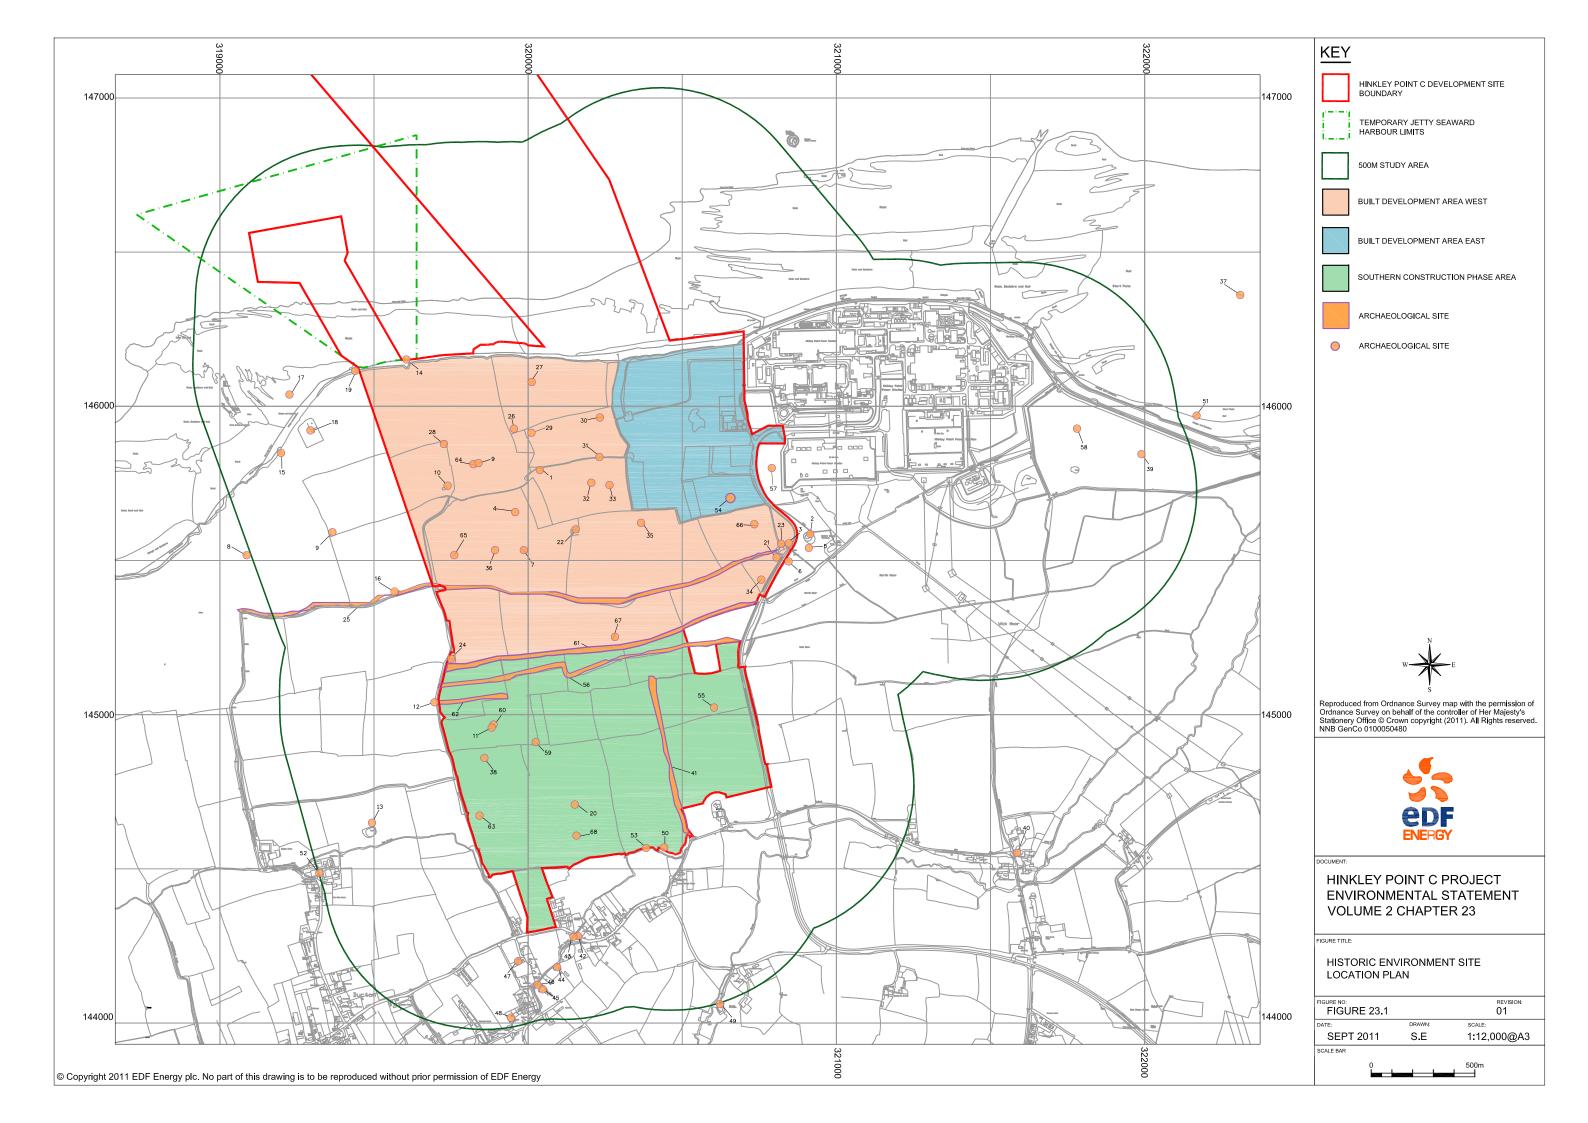
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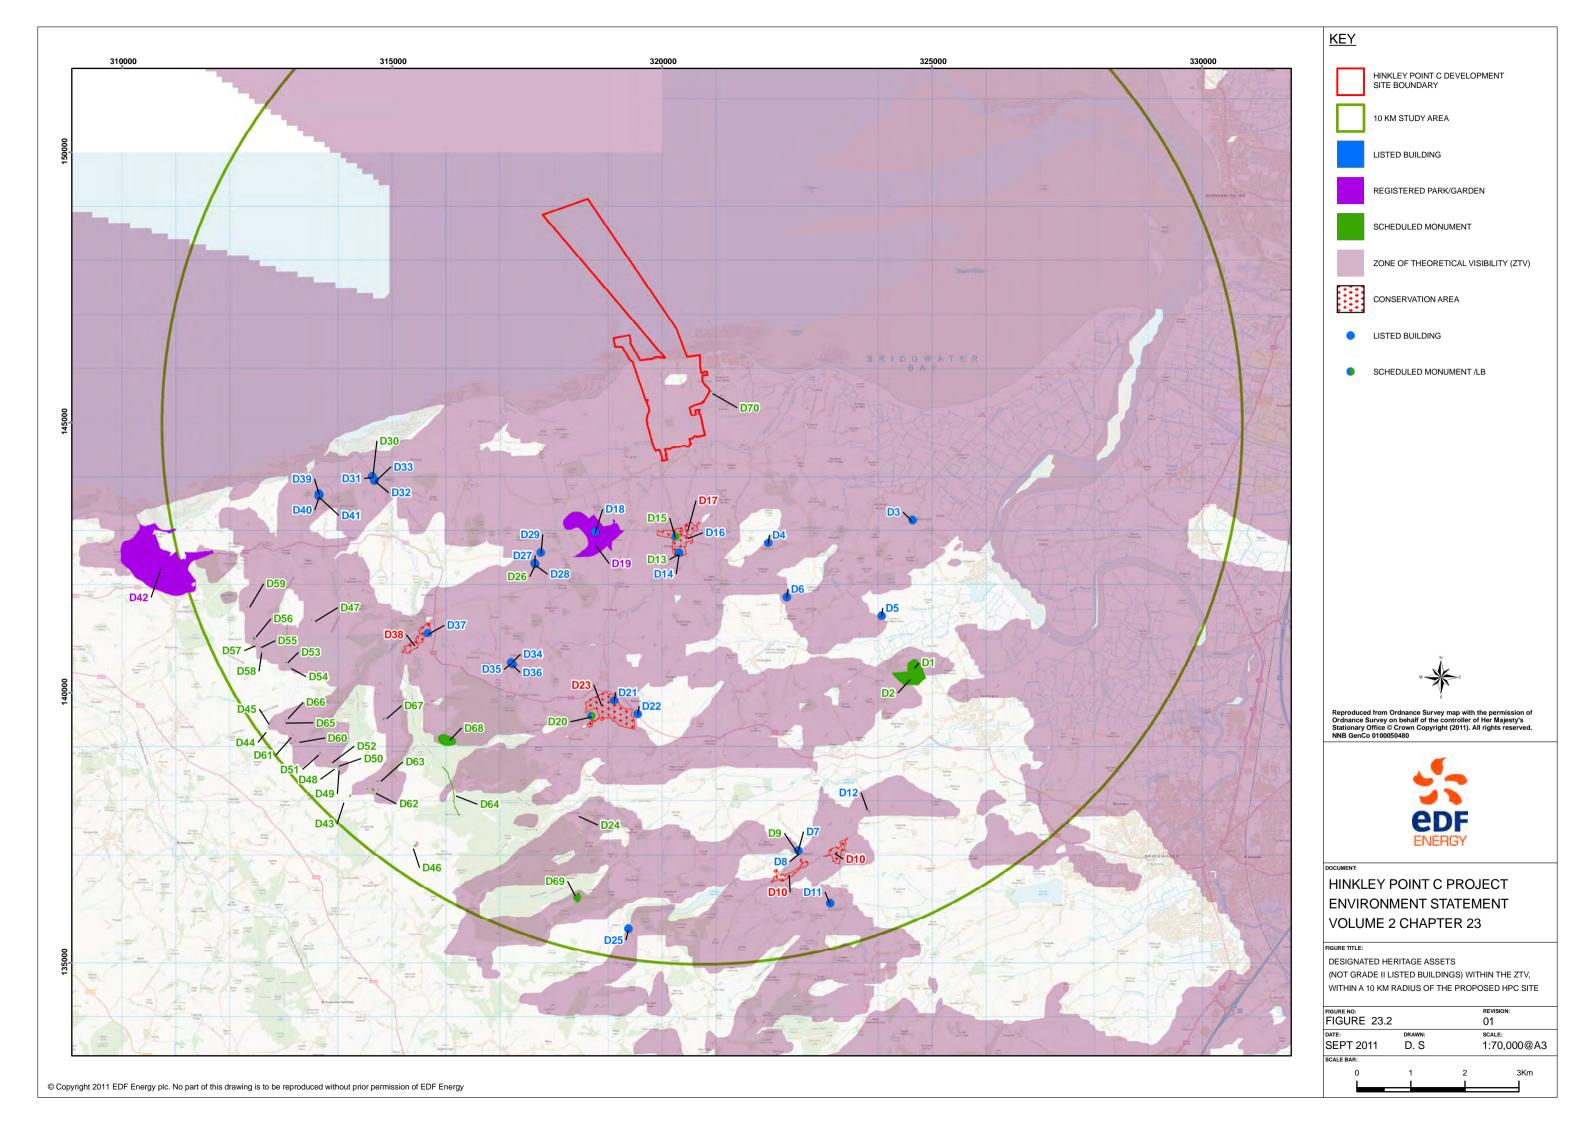
HINKLEY POINT C PROJECT ENVIRONMENTAL STATEMENT VOLUME 2 CHAPTER 20

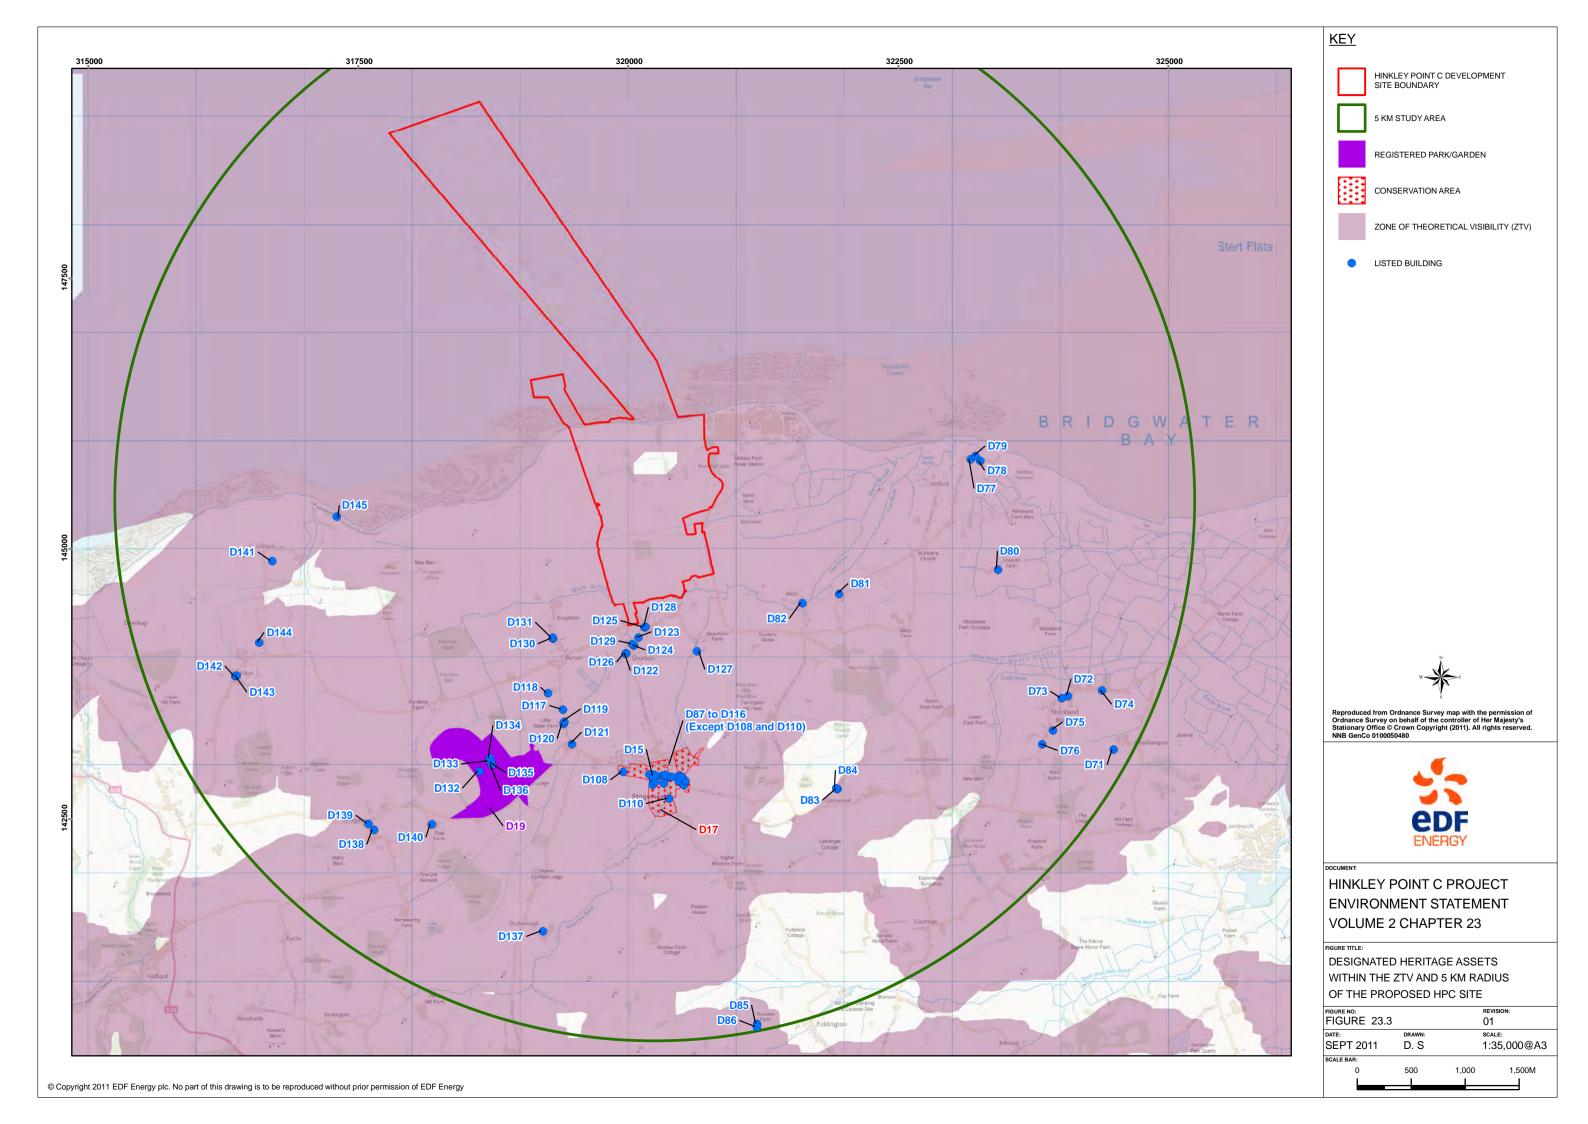
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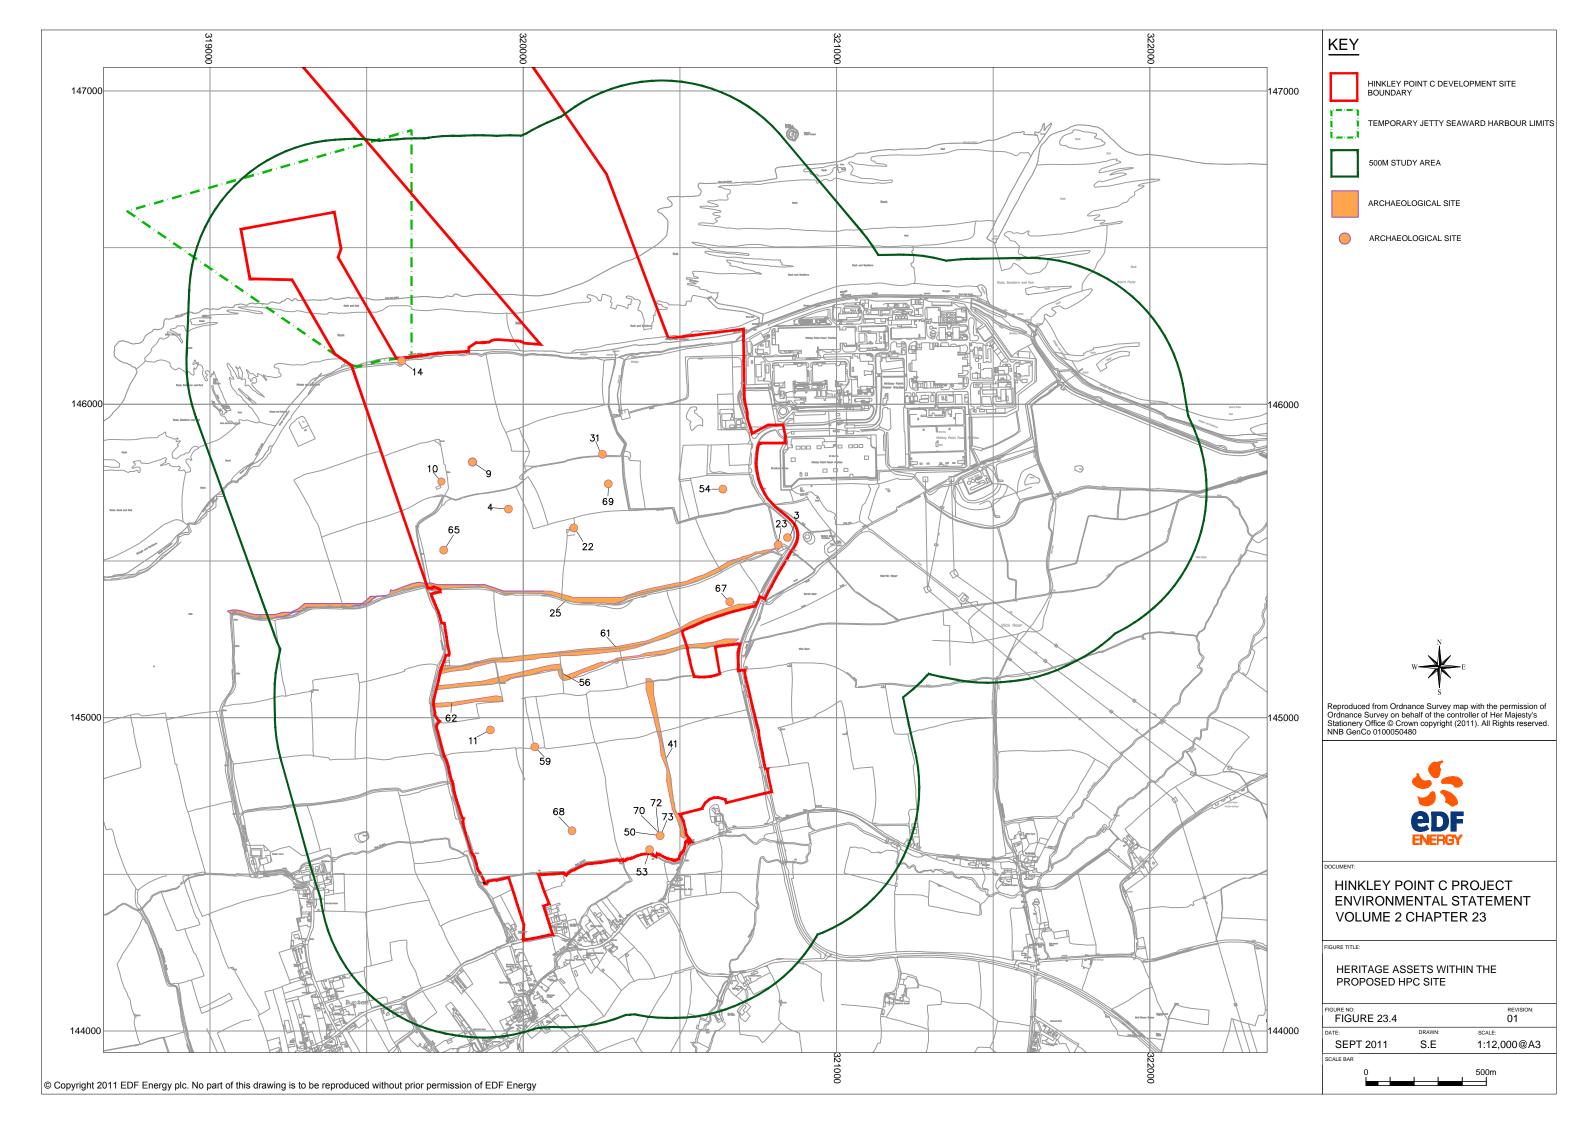
CURLEW PEAK COUNT DATA


	URE NO: FIGURE 20.10	ı	REVISION: 01	
DA.	SEPT 11	J.P	SCALE:	
SC	ALE BAR			













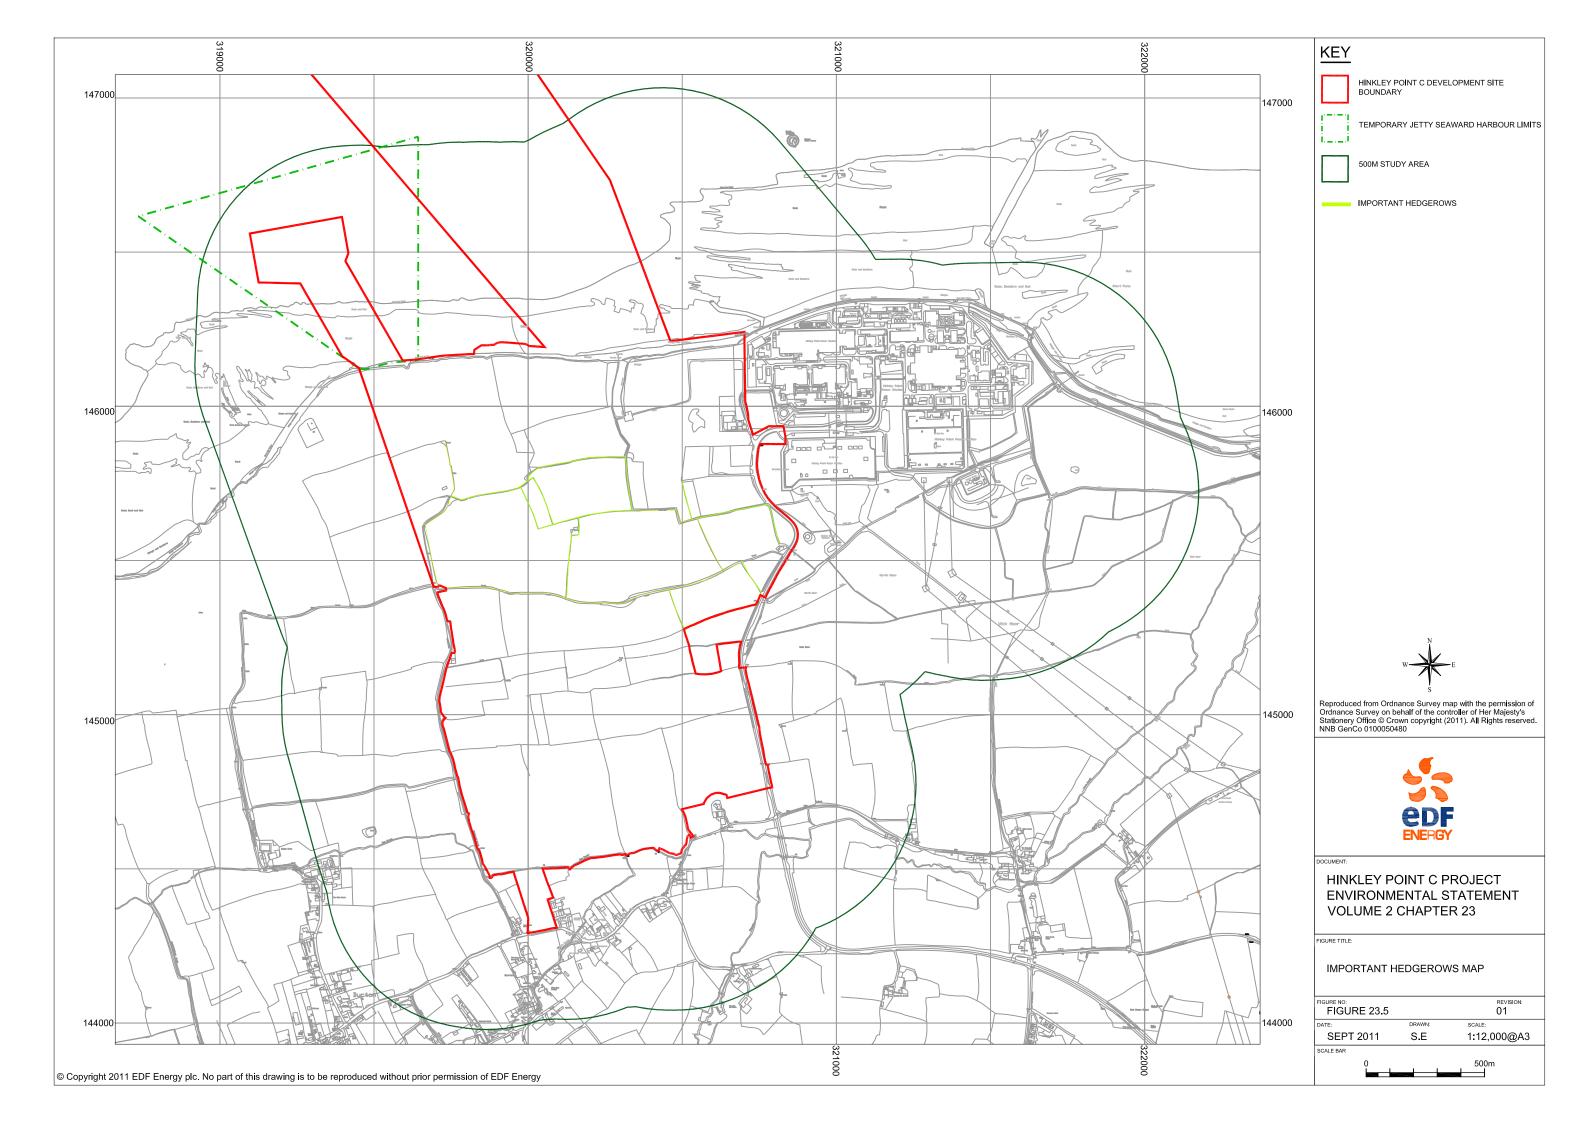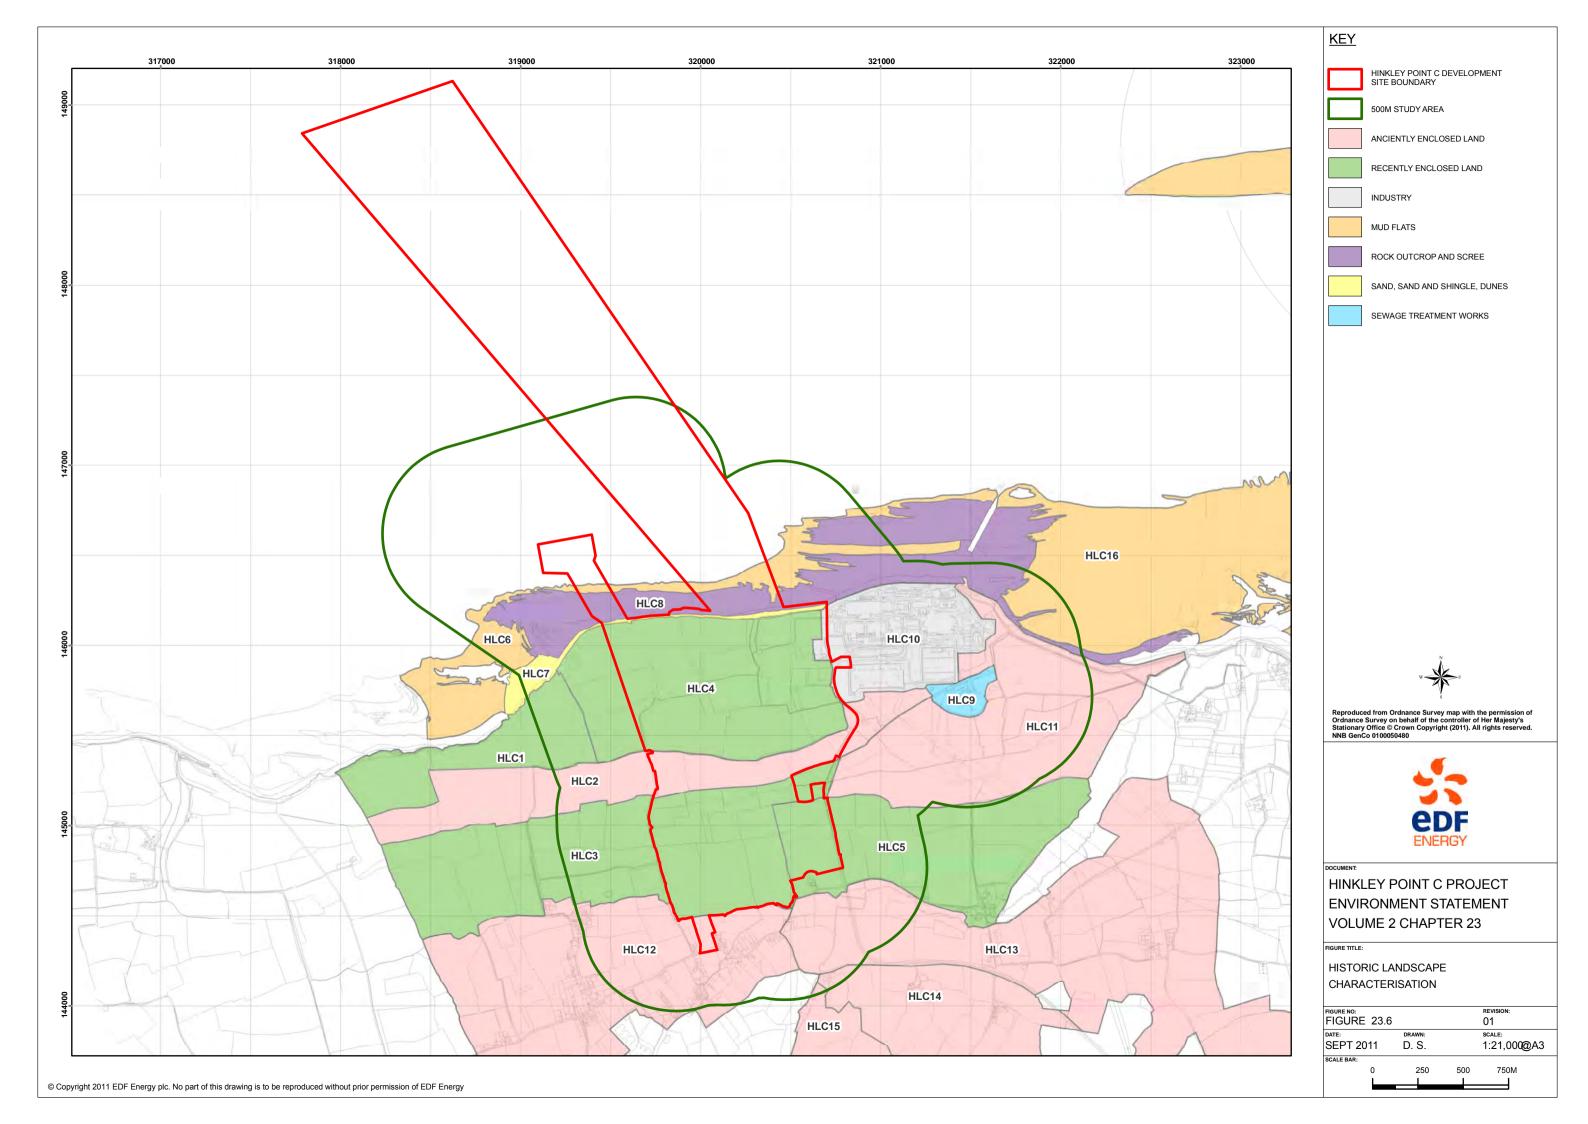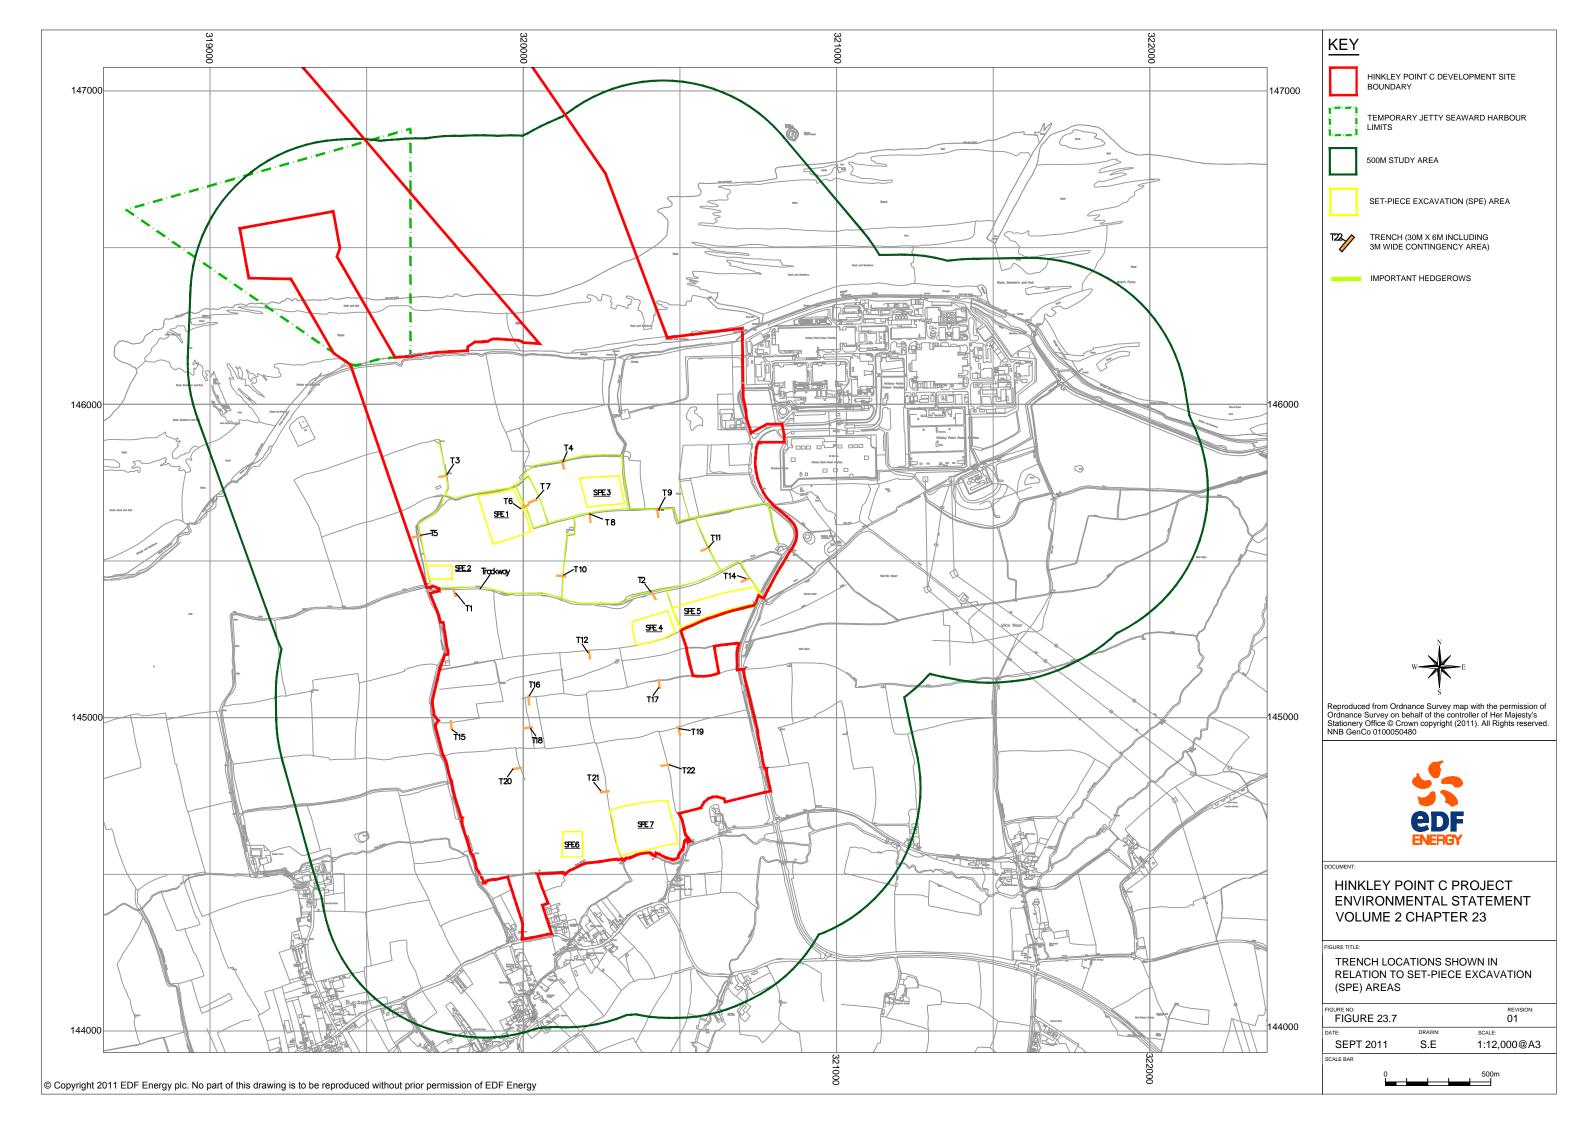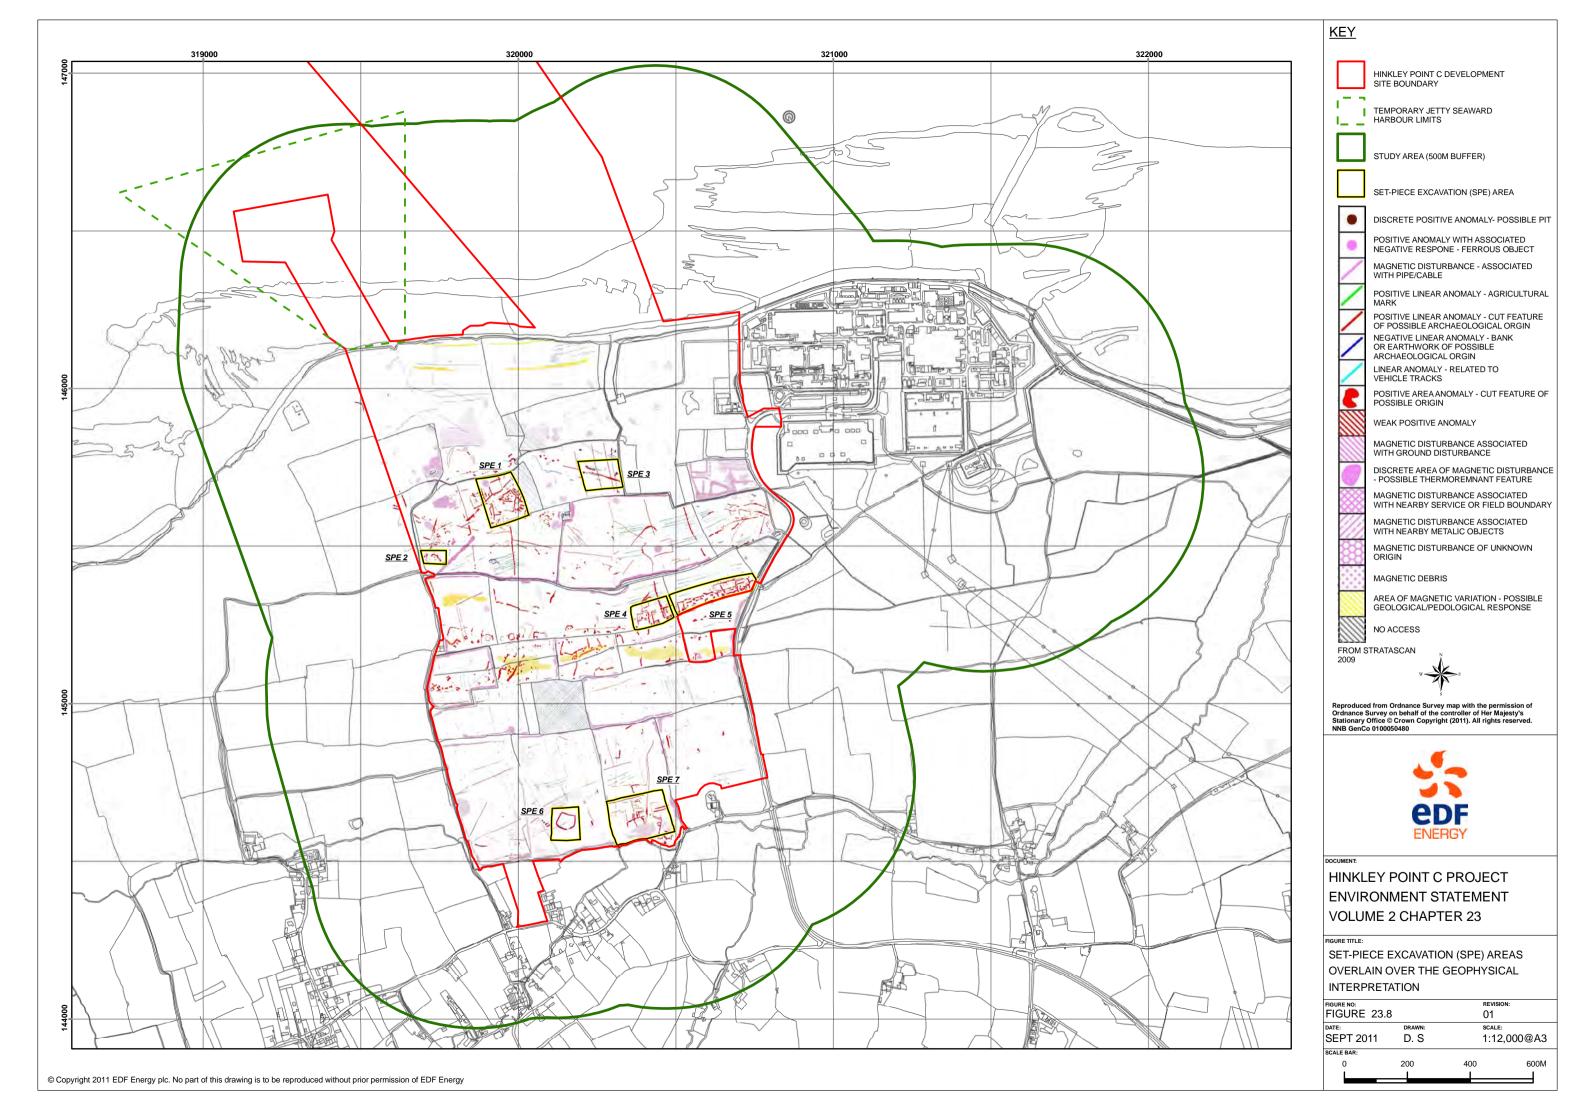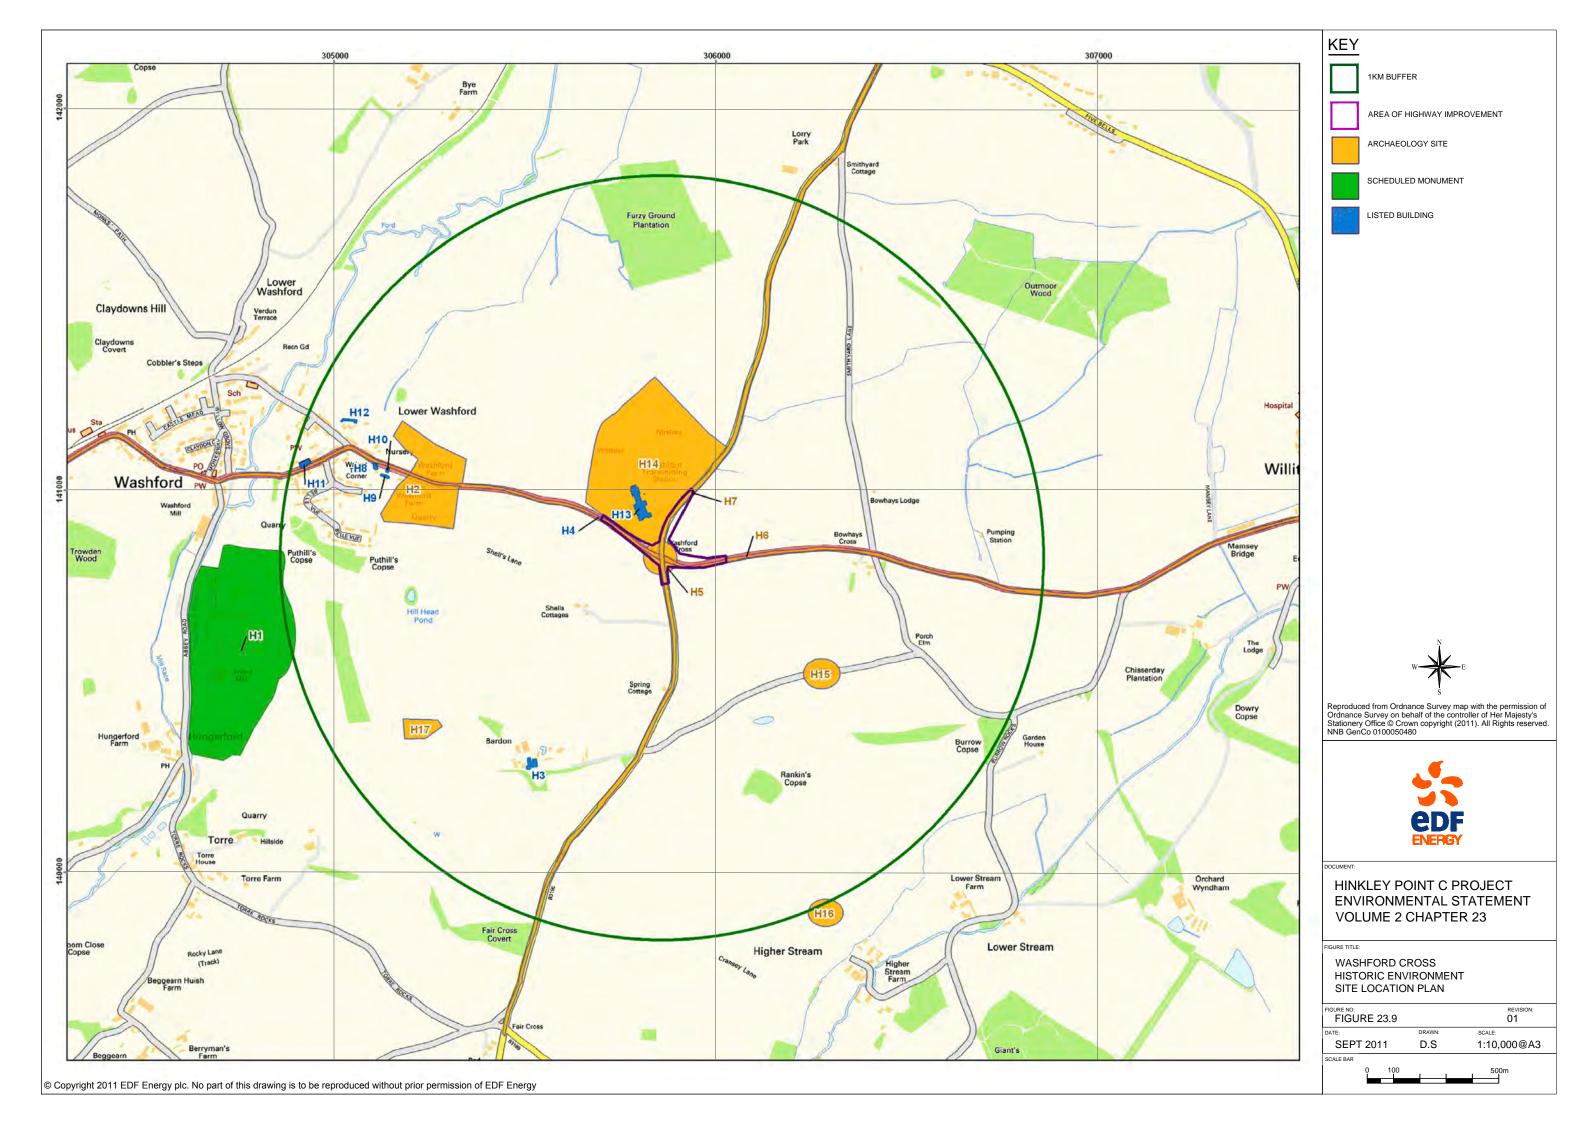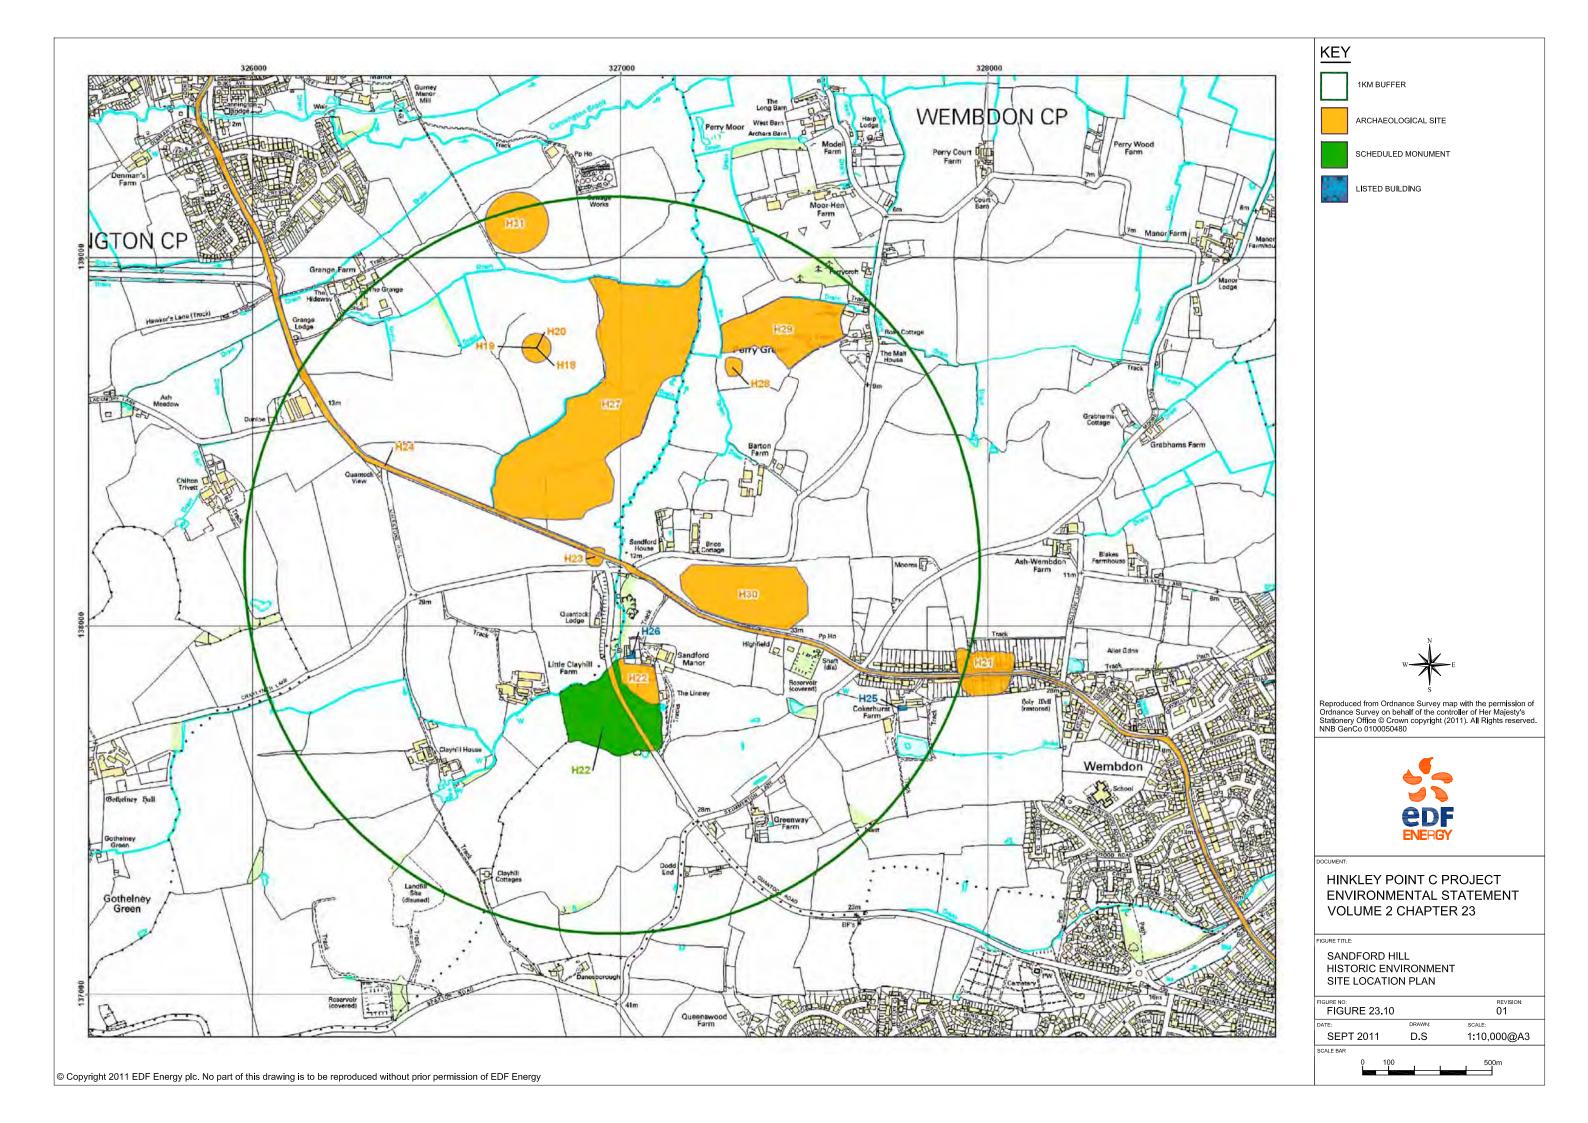


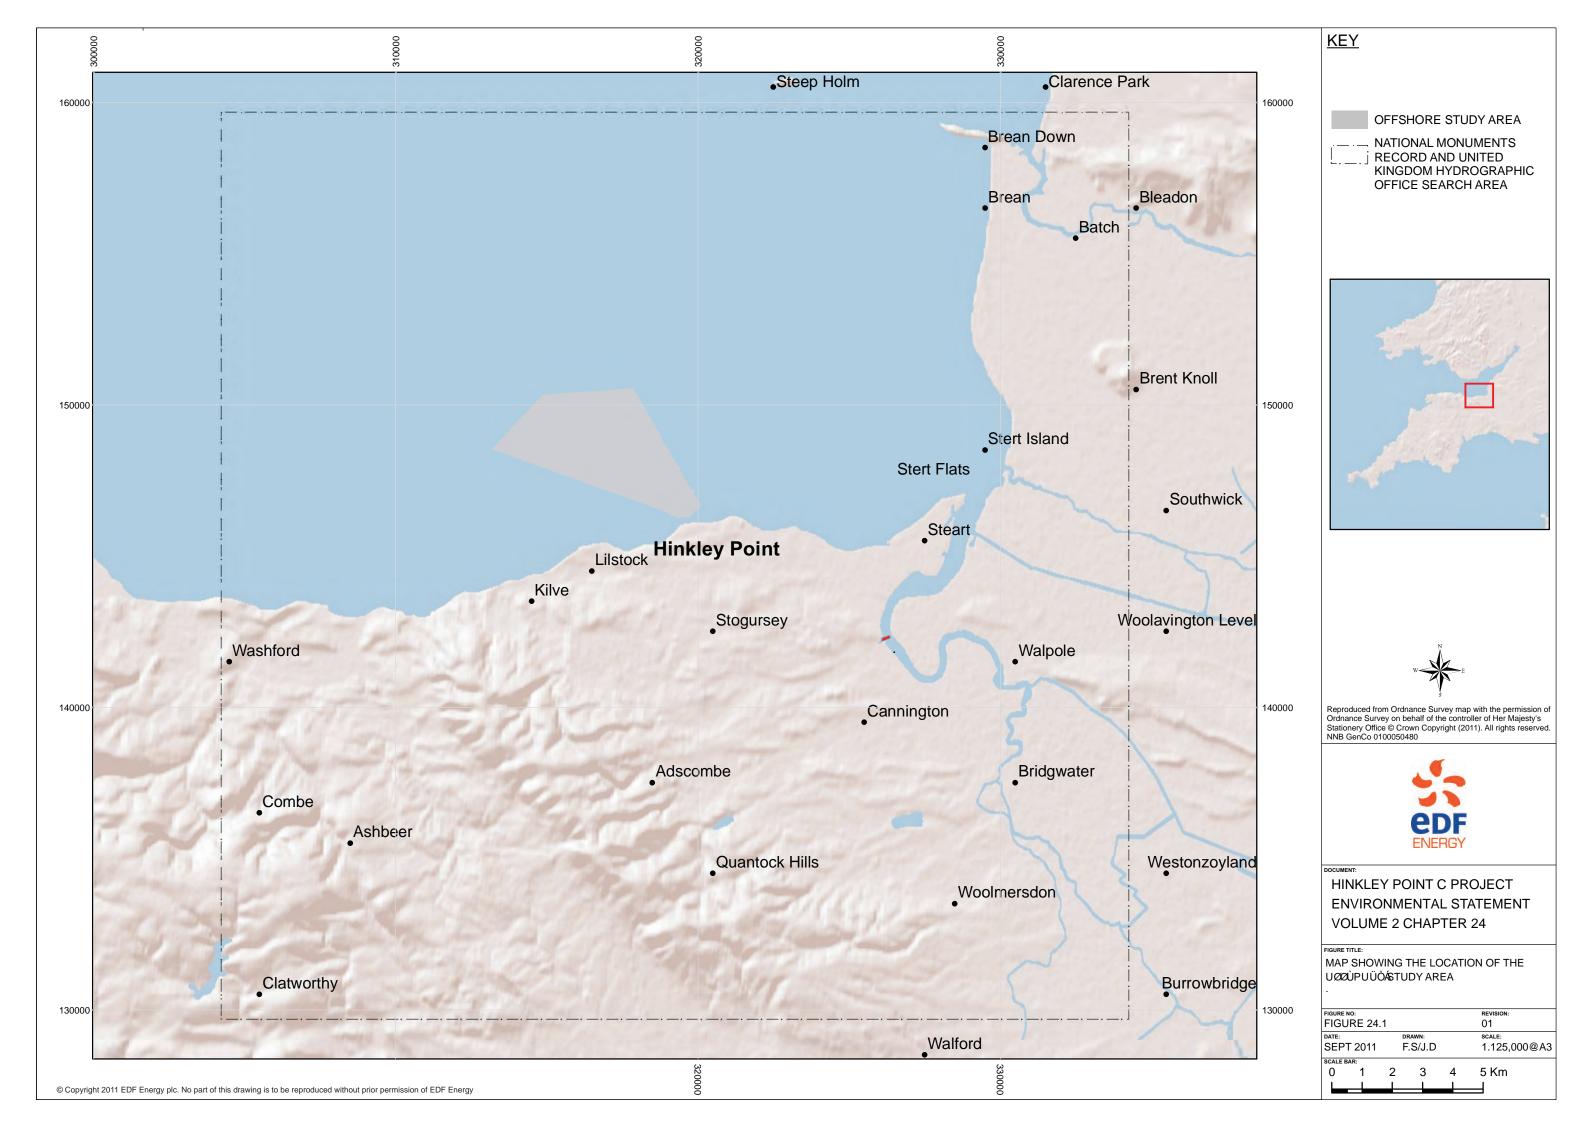


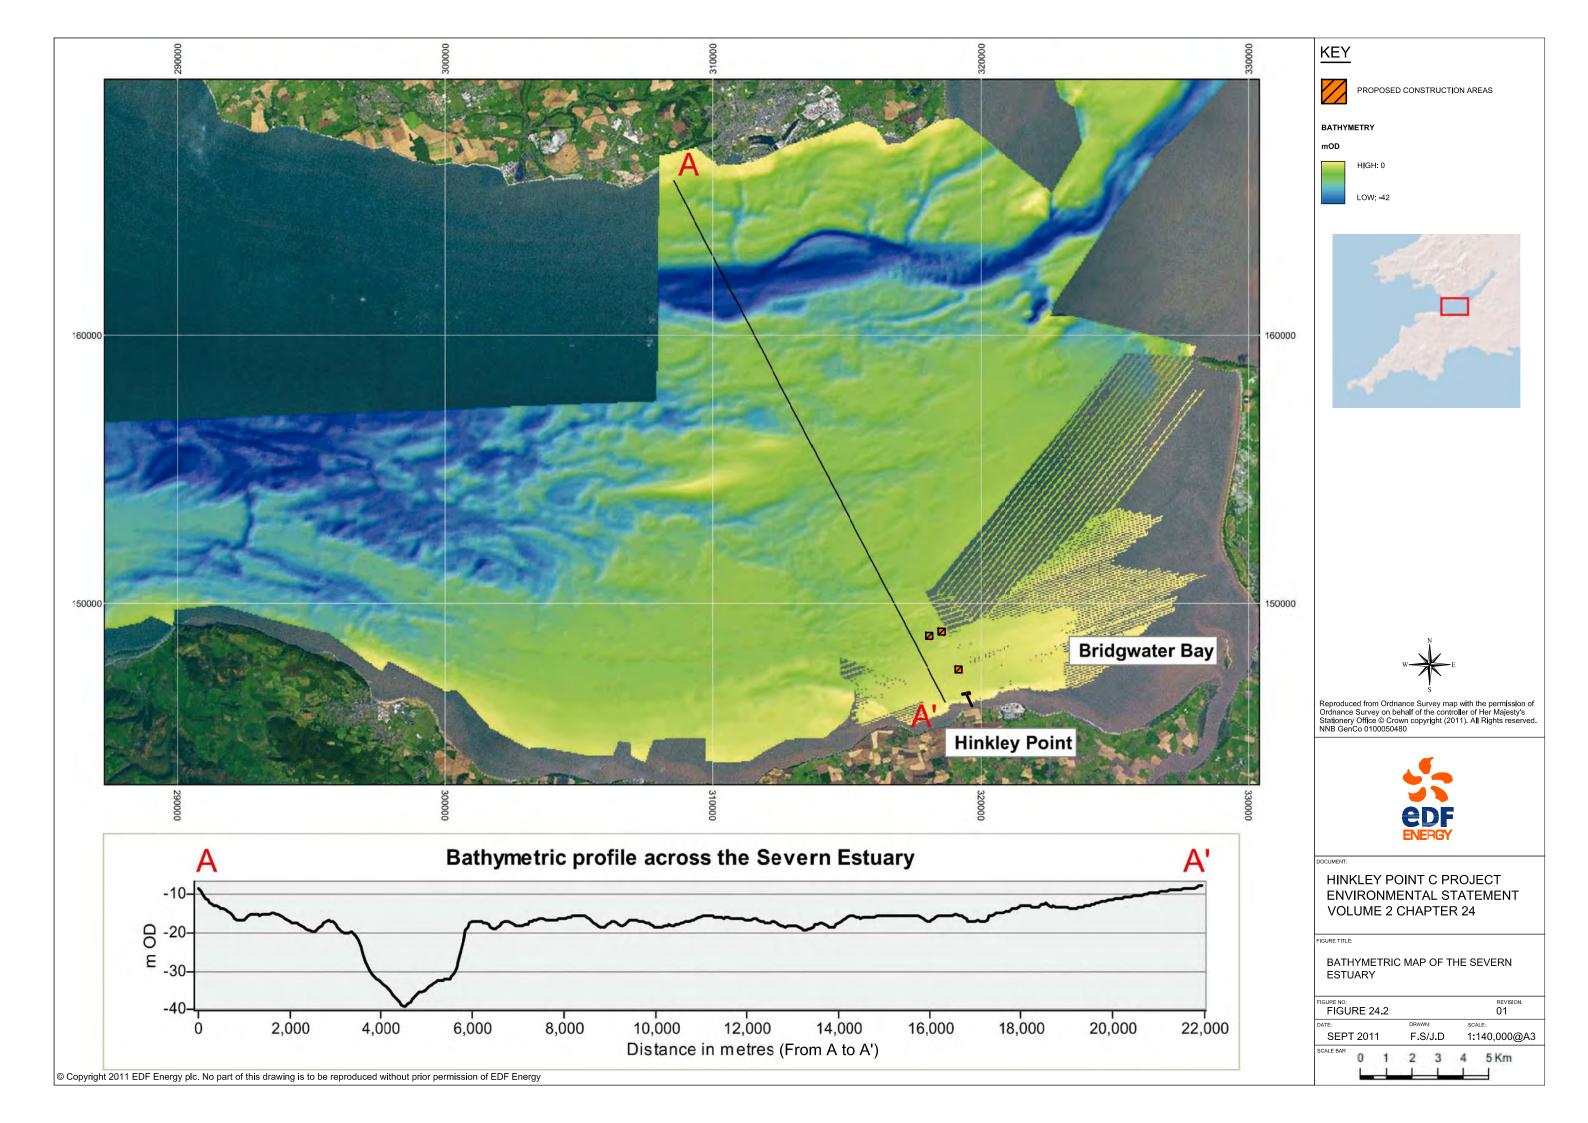


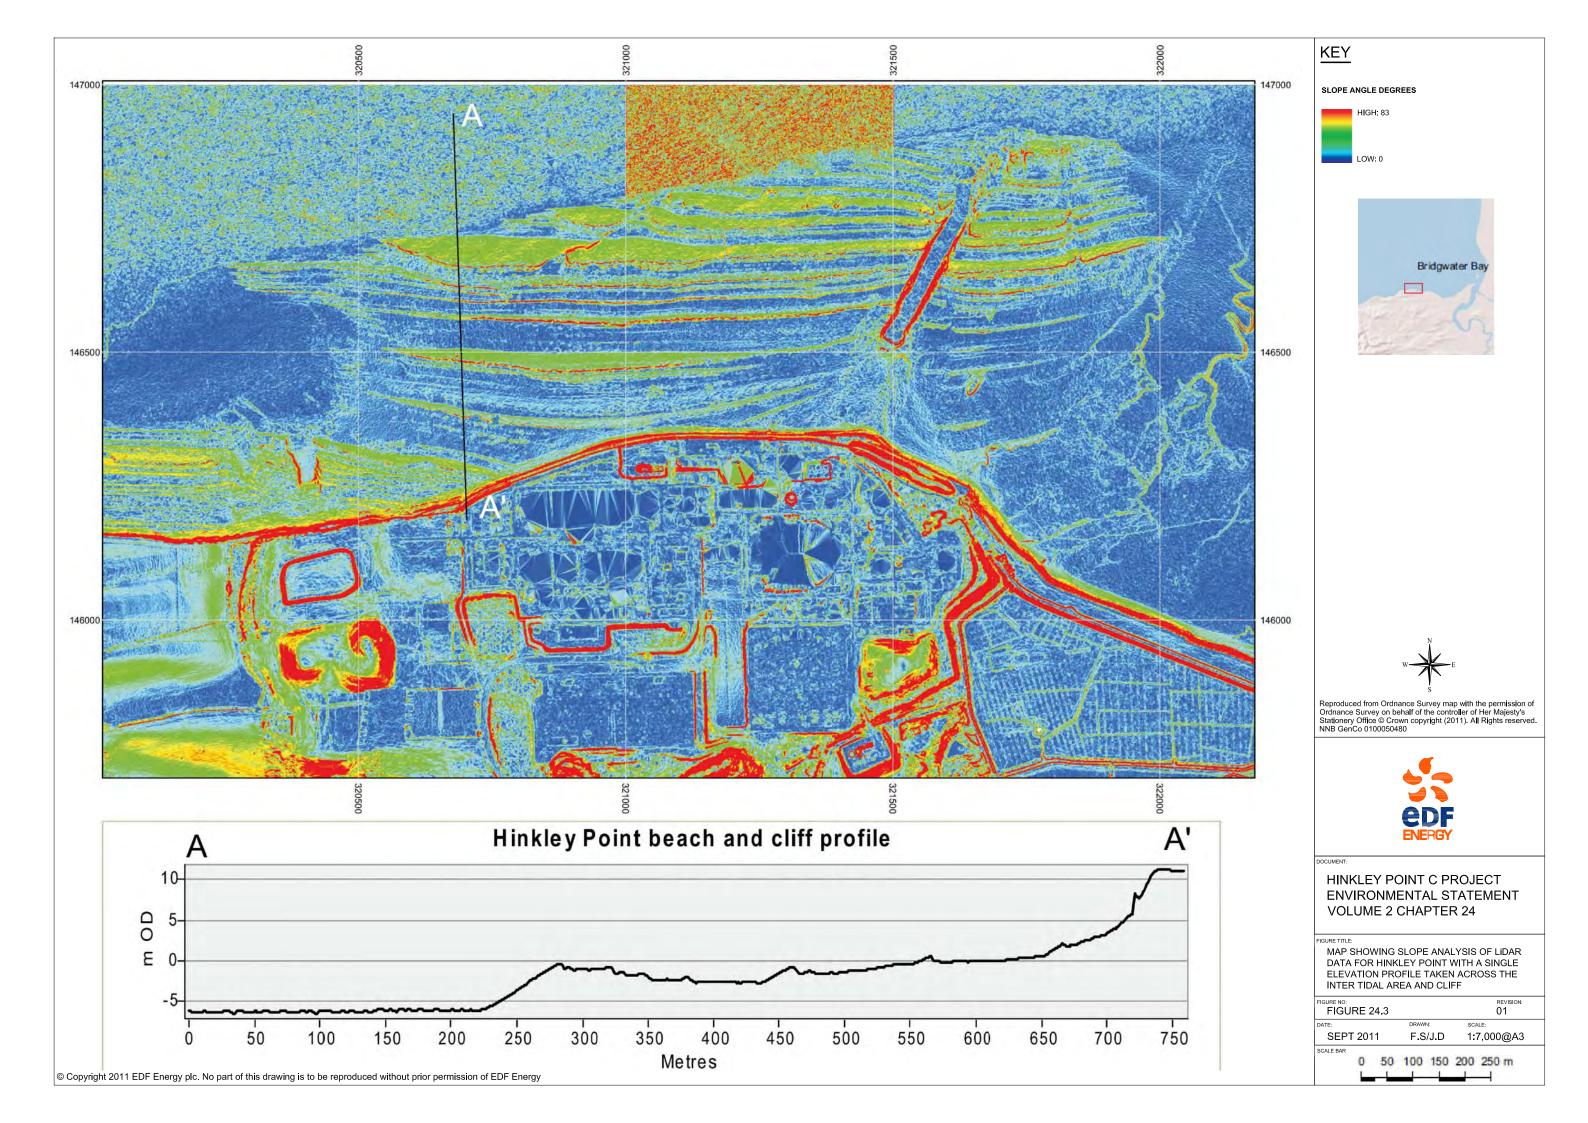


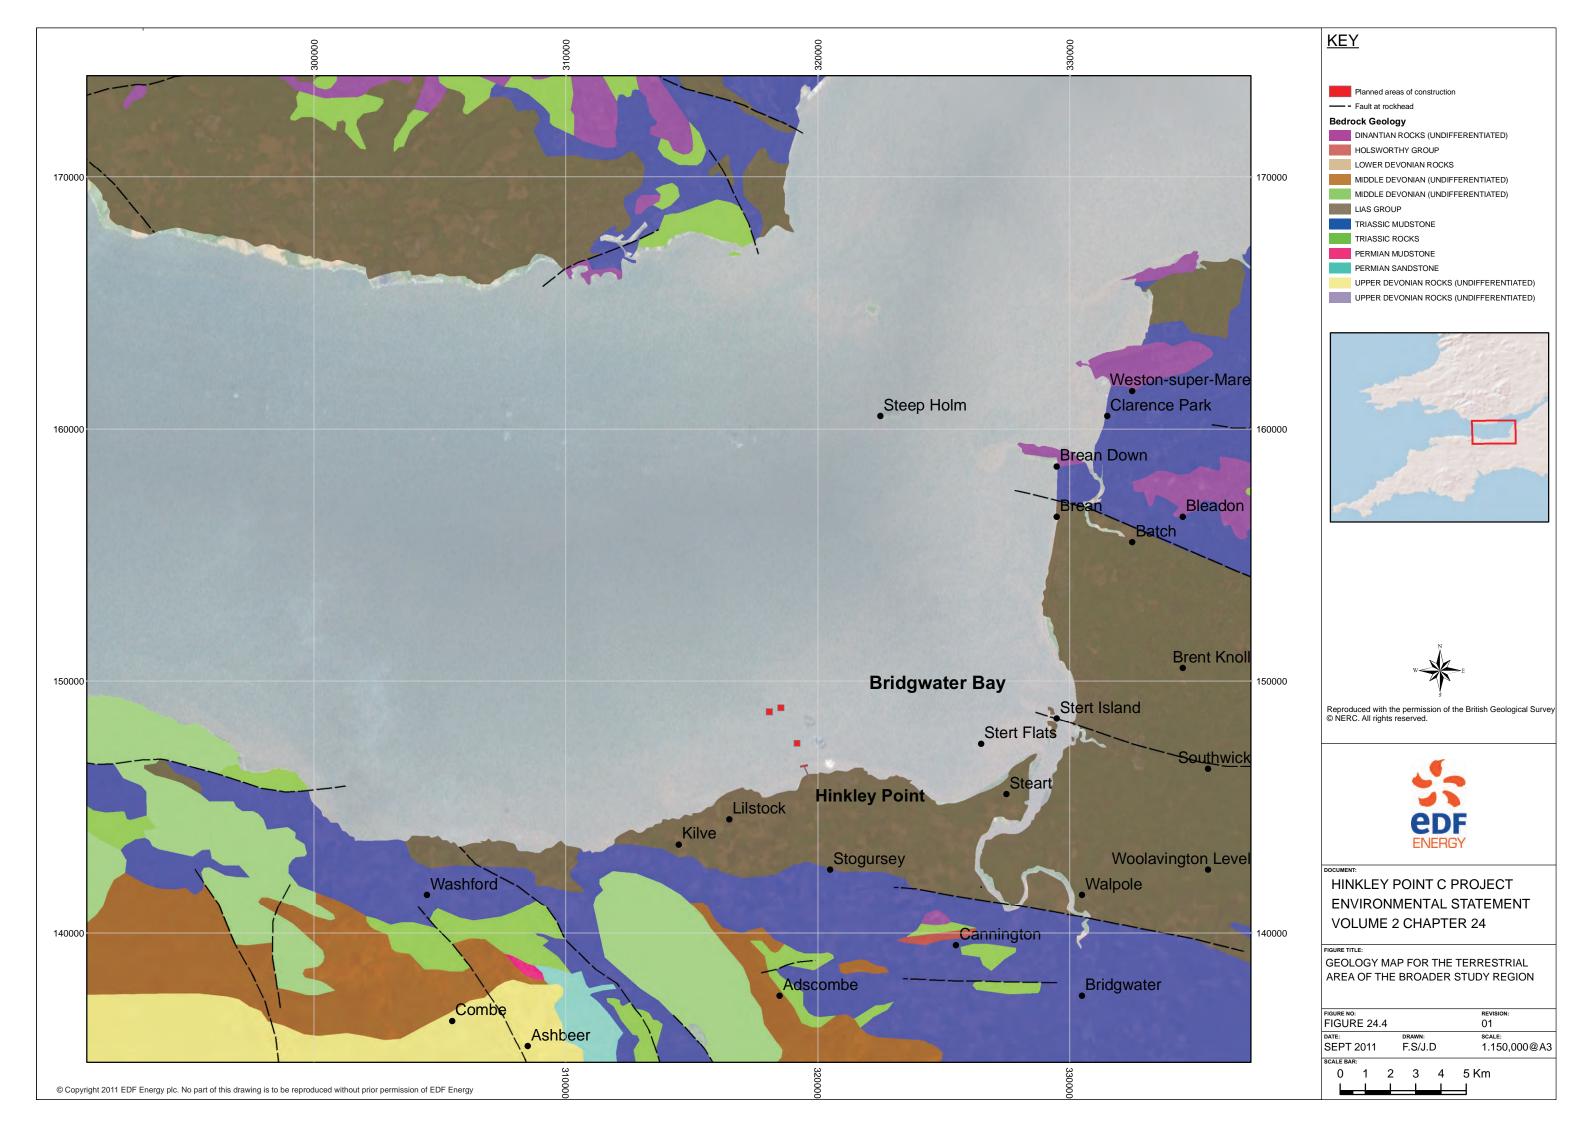













Bridgwater Bay Relative Sea Level Curve

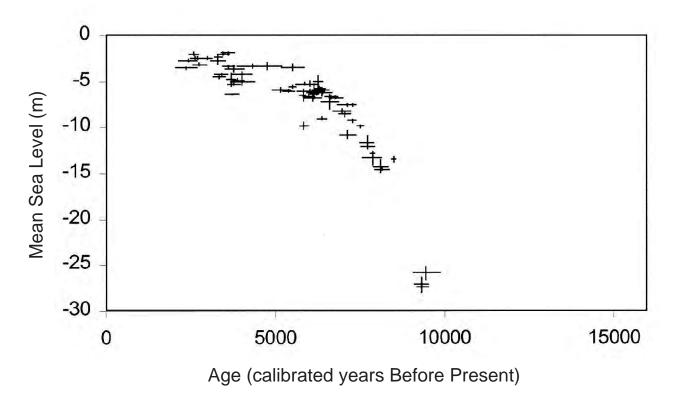





DOCUM

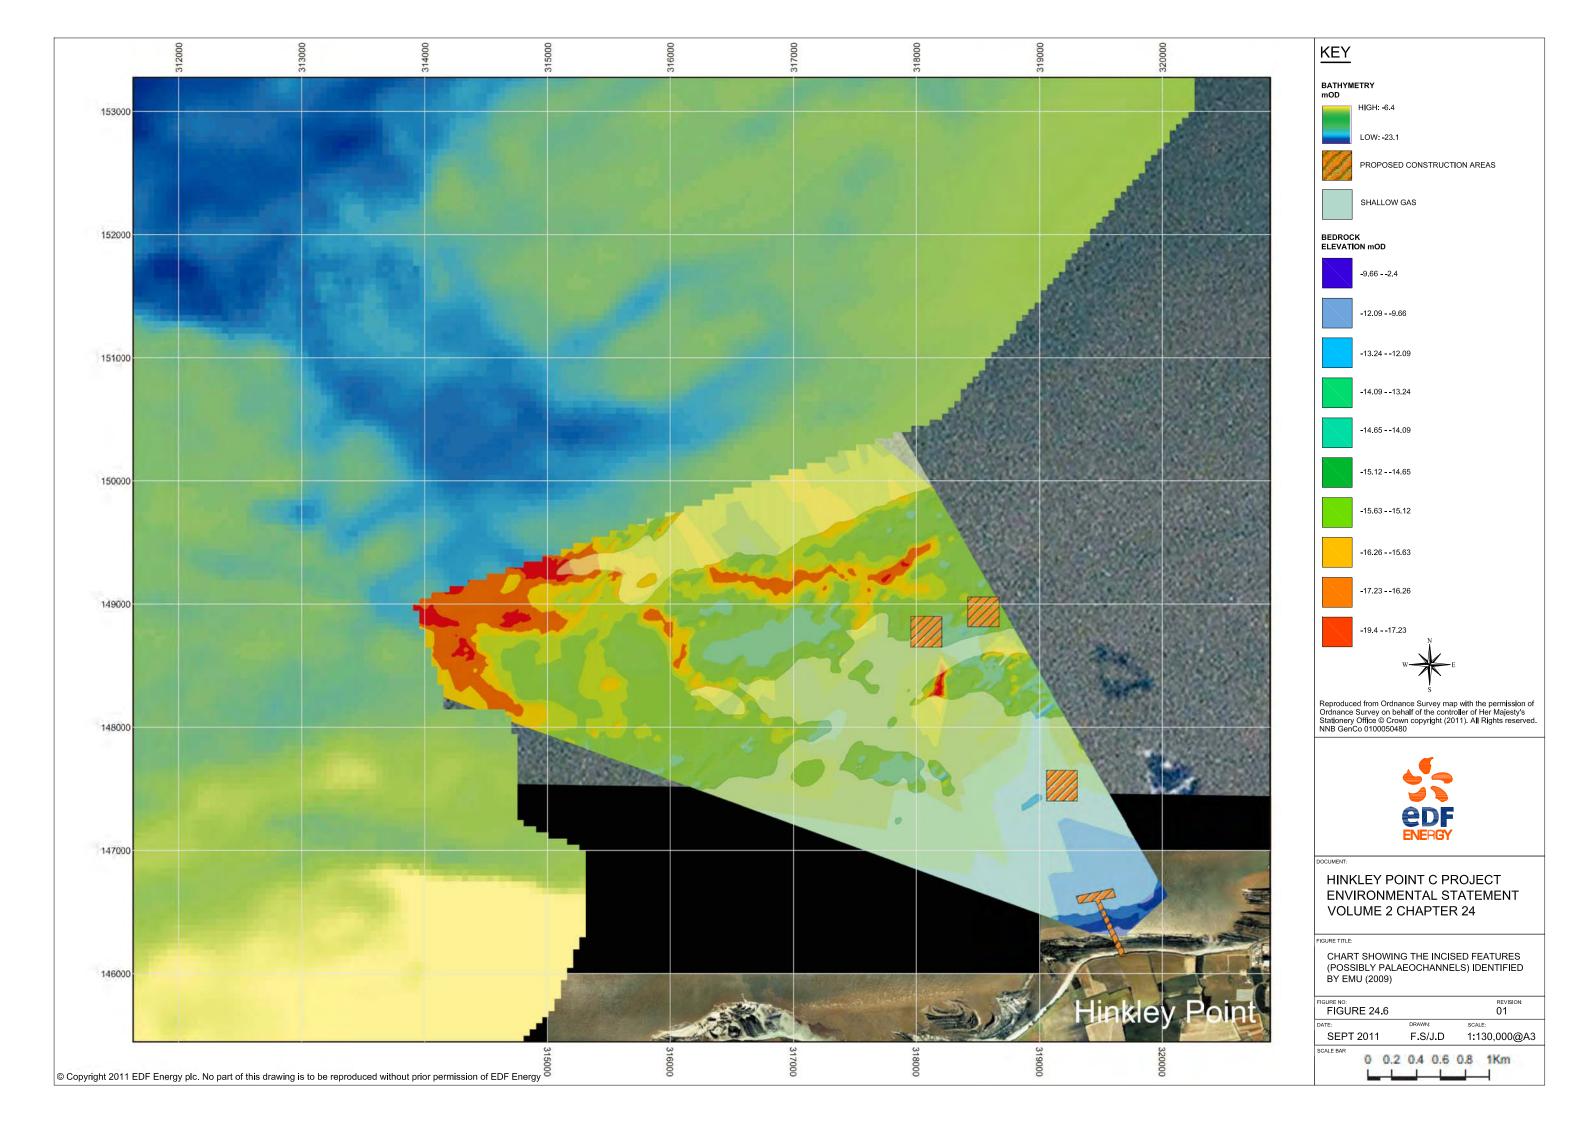
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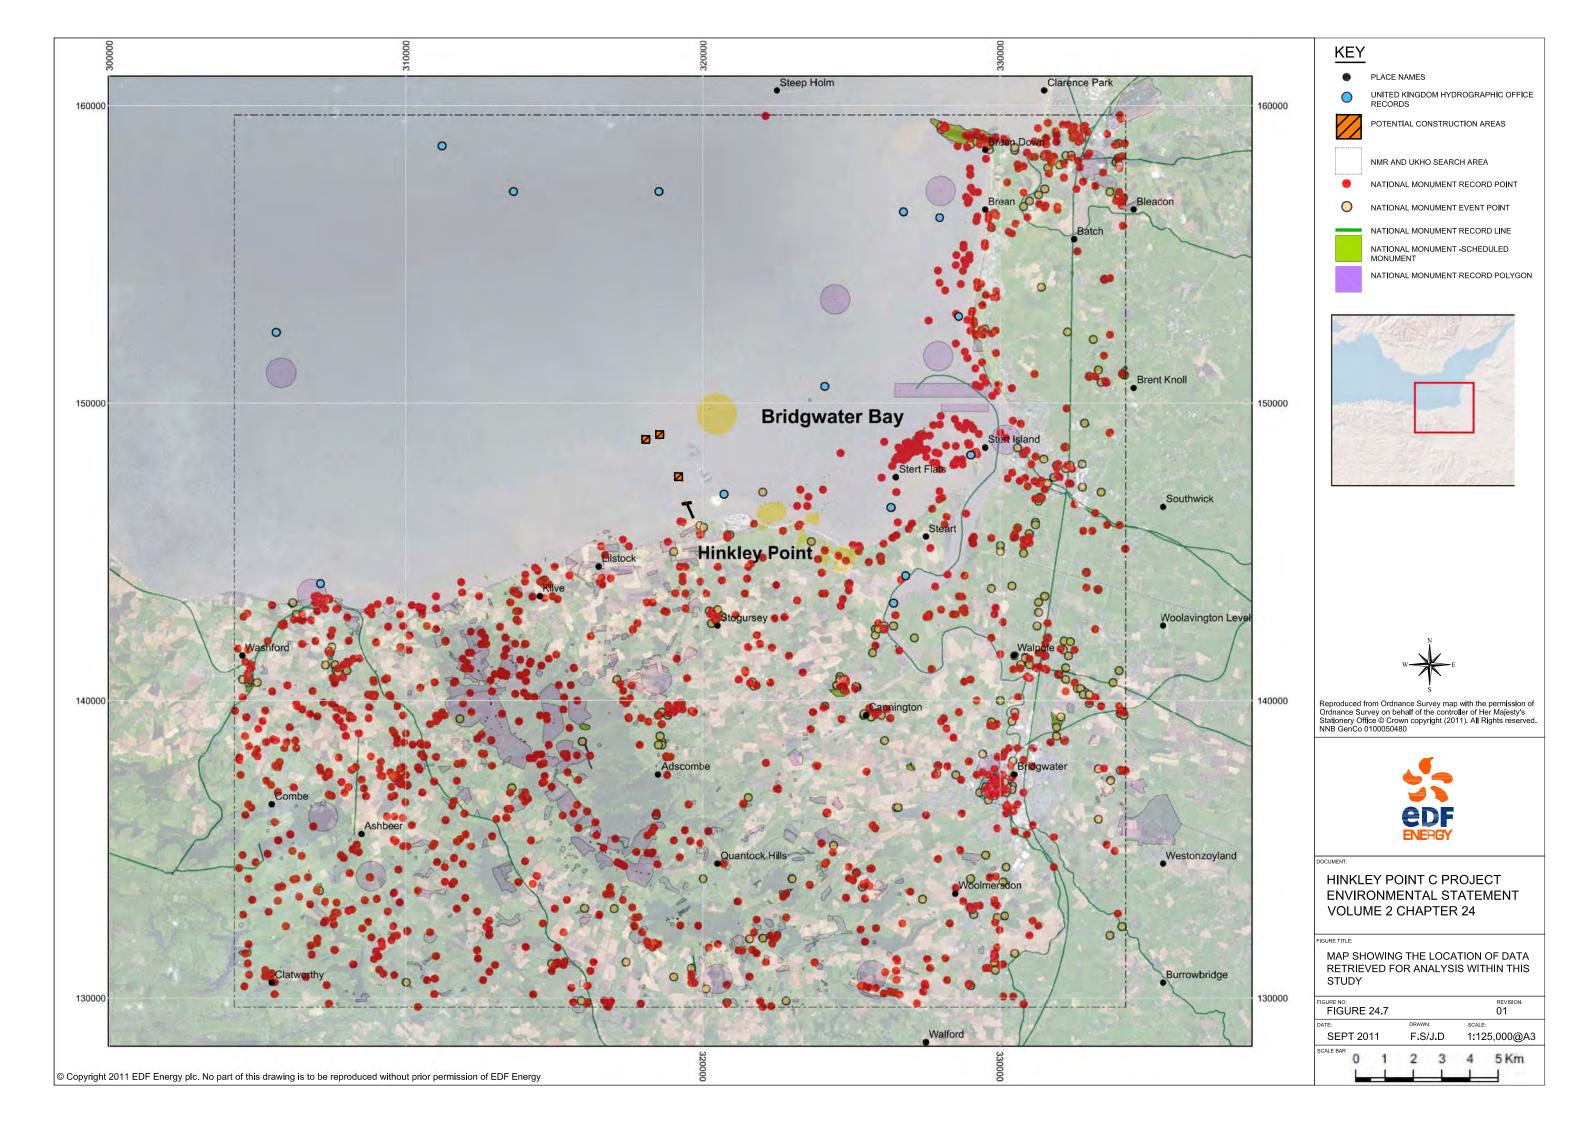
HINKLEY POINT C PROJECT ENVIRONMENTAL STATEMENT VOLUME 2 CHAPTER 24


FIGURE TITLE


RSL GRAPH FOR THE BRIDGWATER BAY AREA (AFTER LONG ET AL 2002)


FIGURE 24.5		REVISION: 01
DATE: SEPT 2011	DRAWN: F.S/J.D	SCALE:
SCALE BAR:	1.5/3.D	





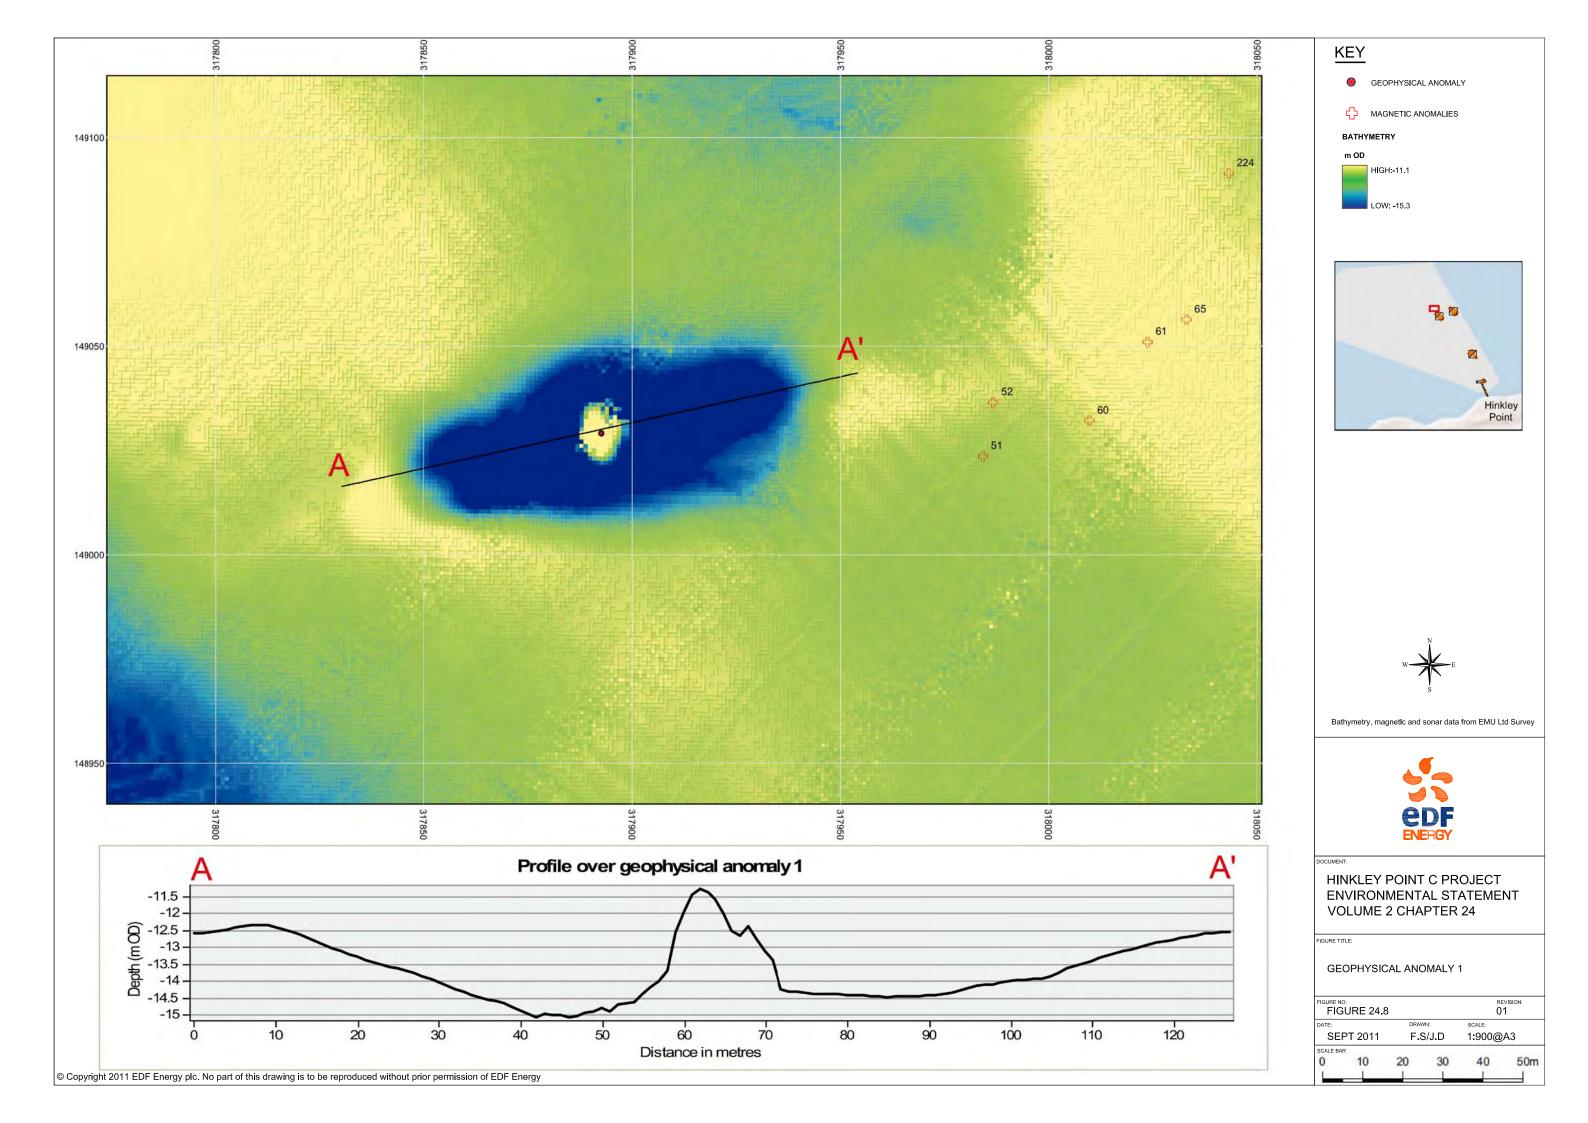

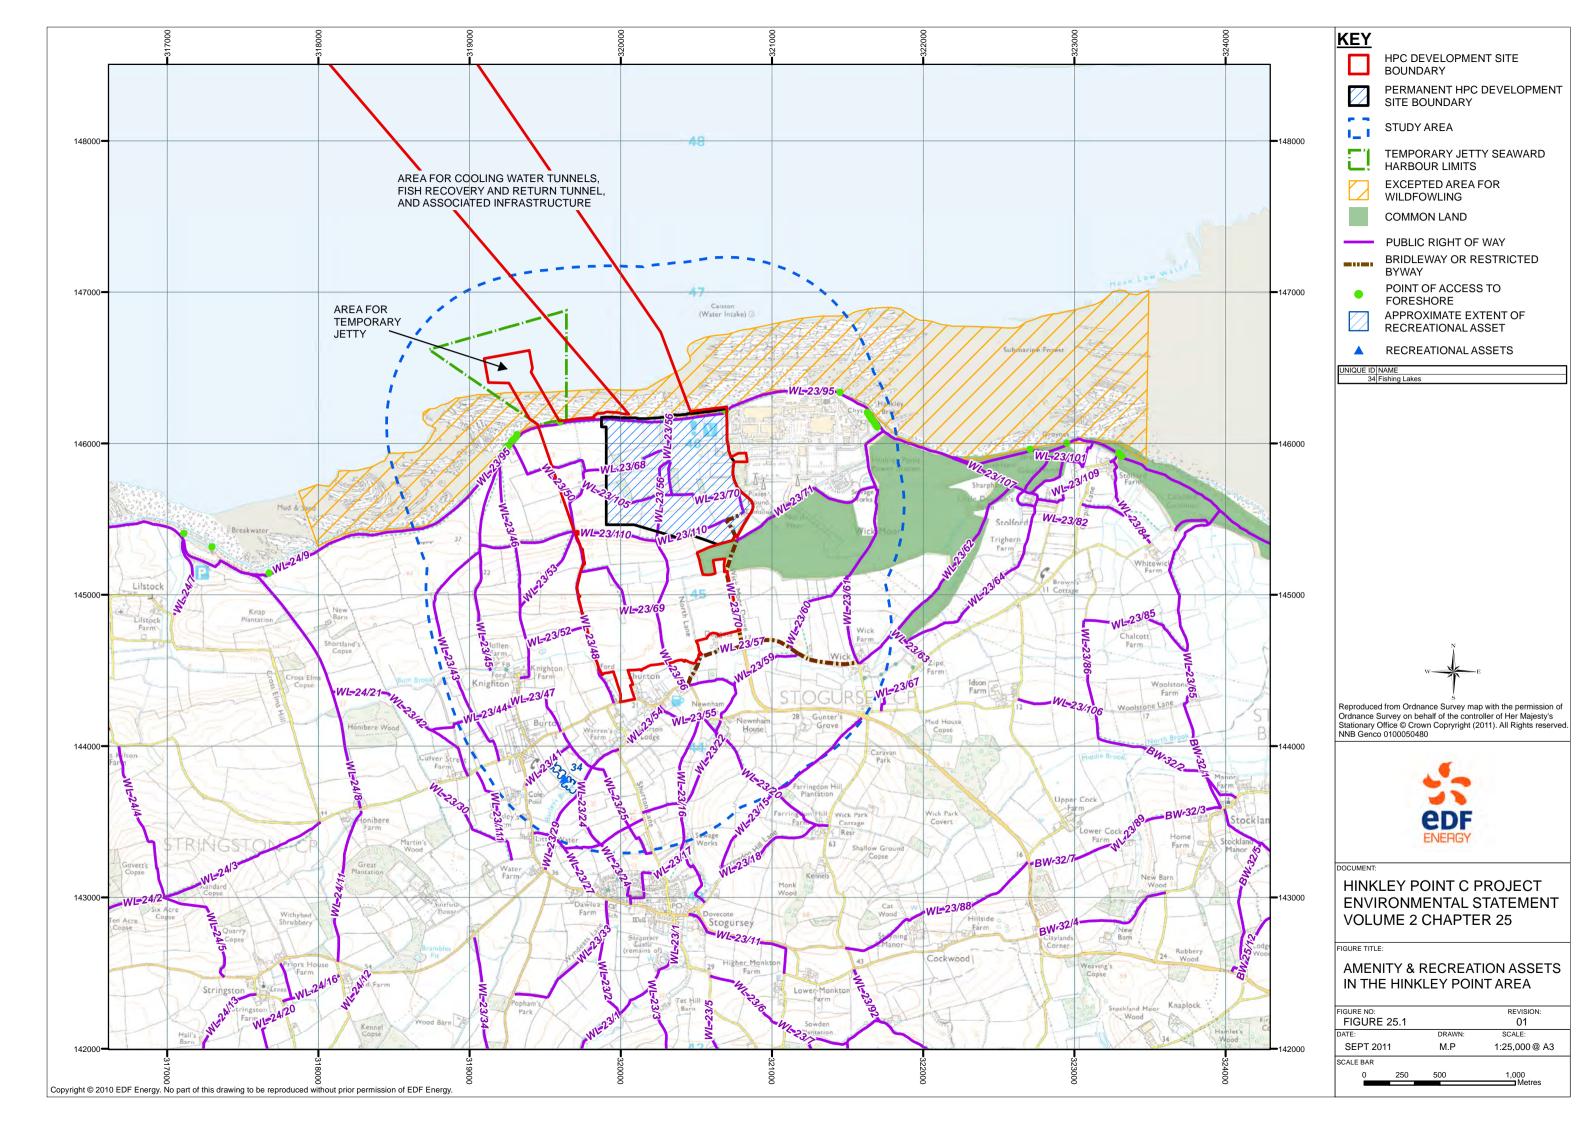


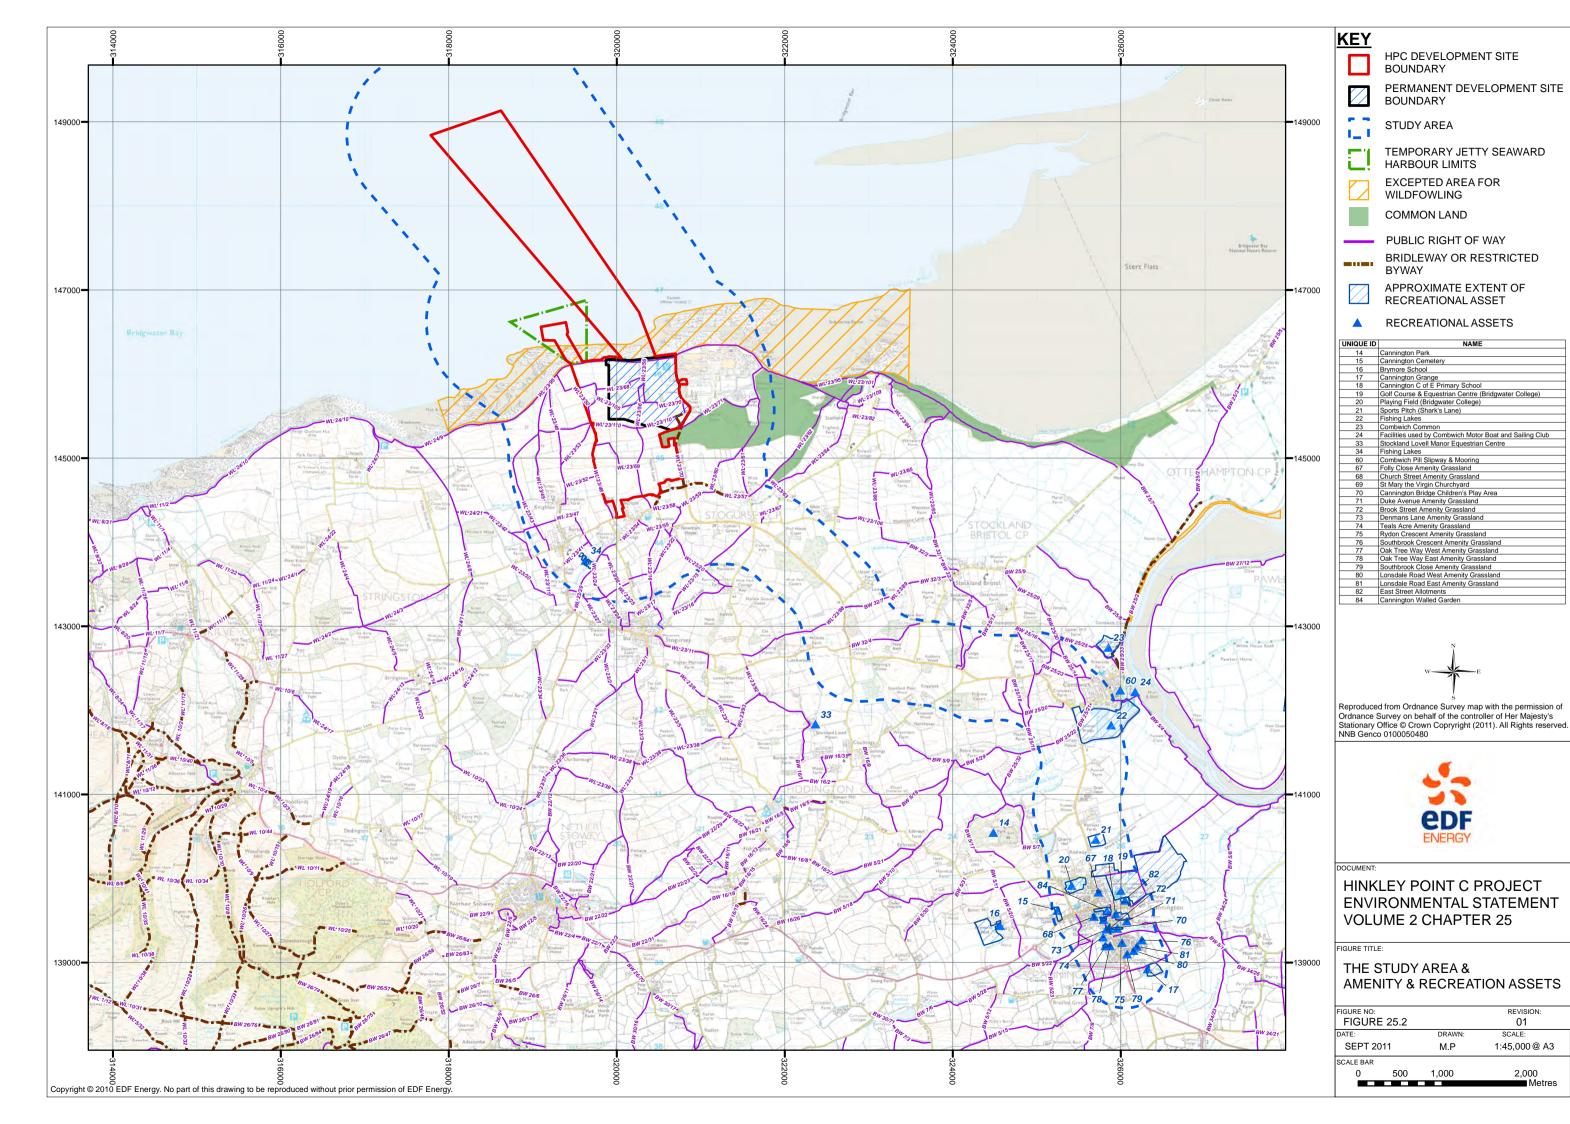


01

1:45,000 @ A3

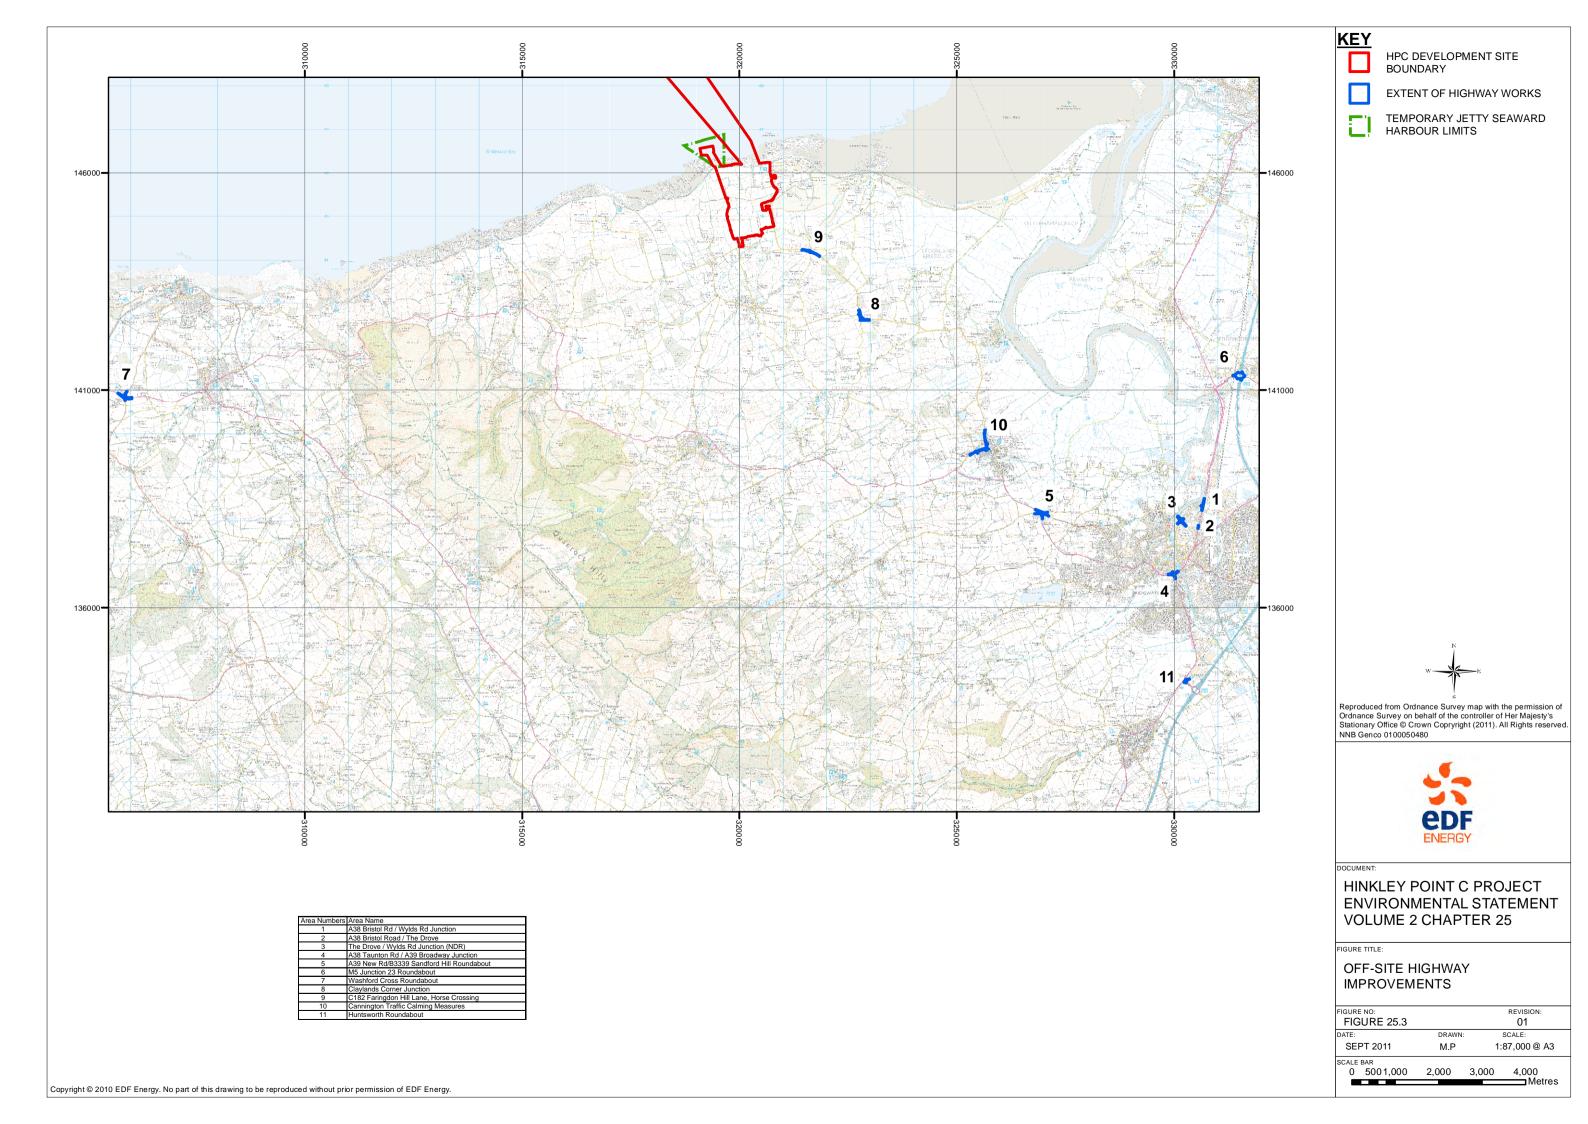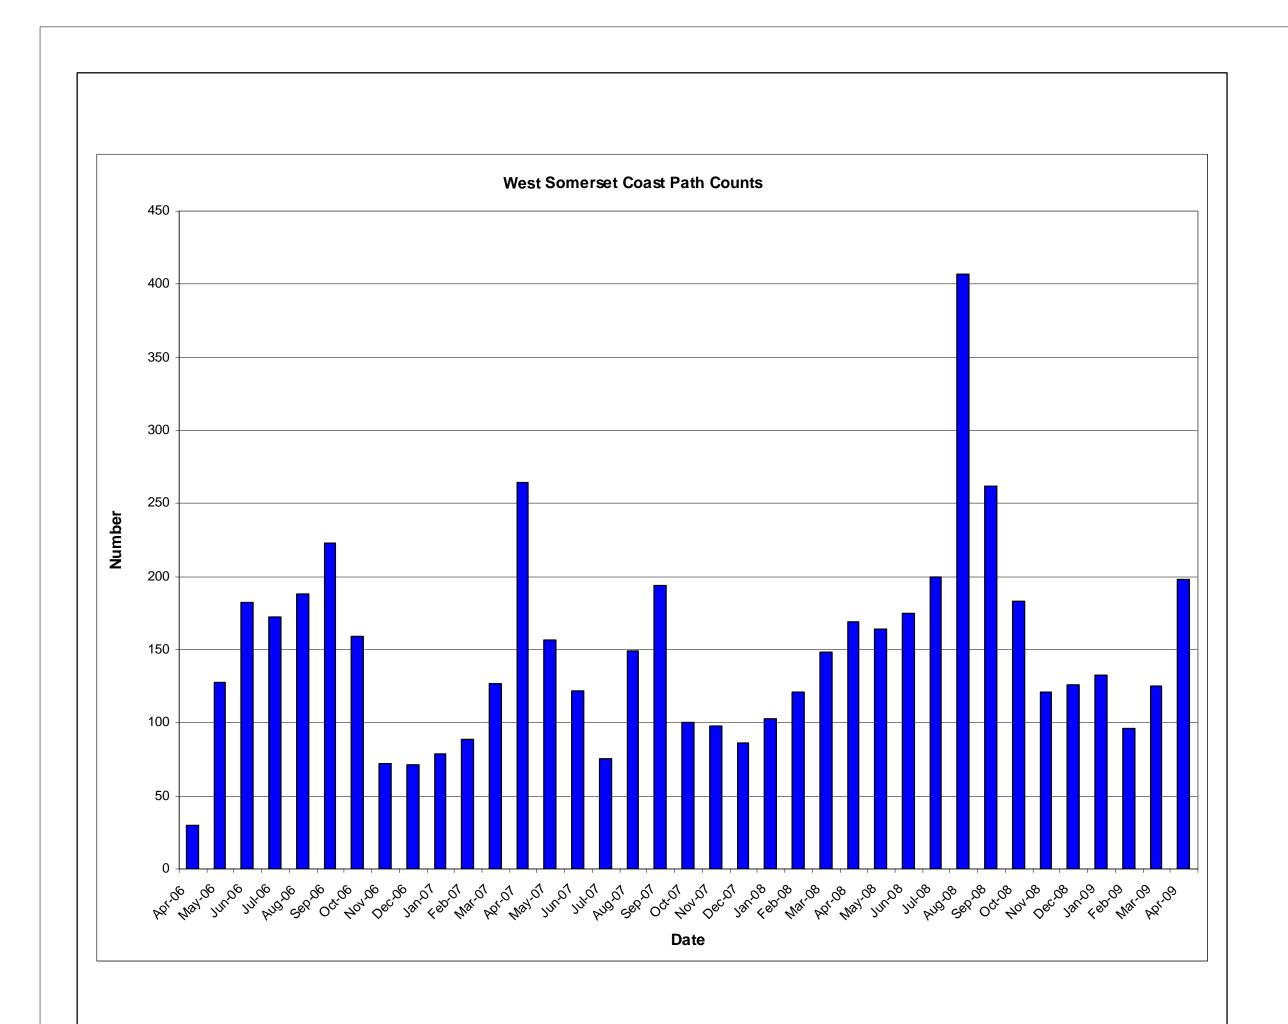2,000









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DOCUMENT

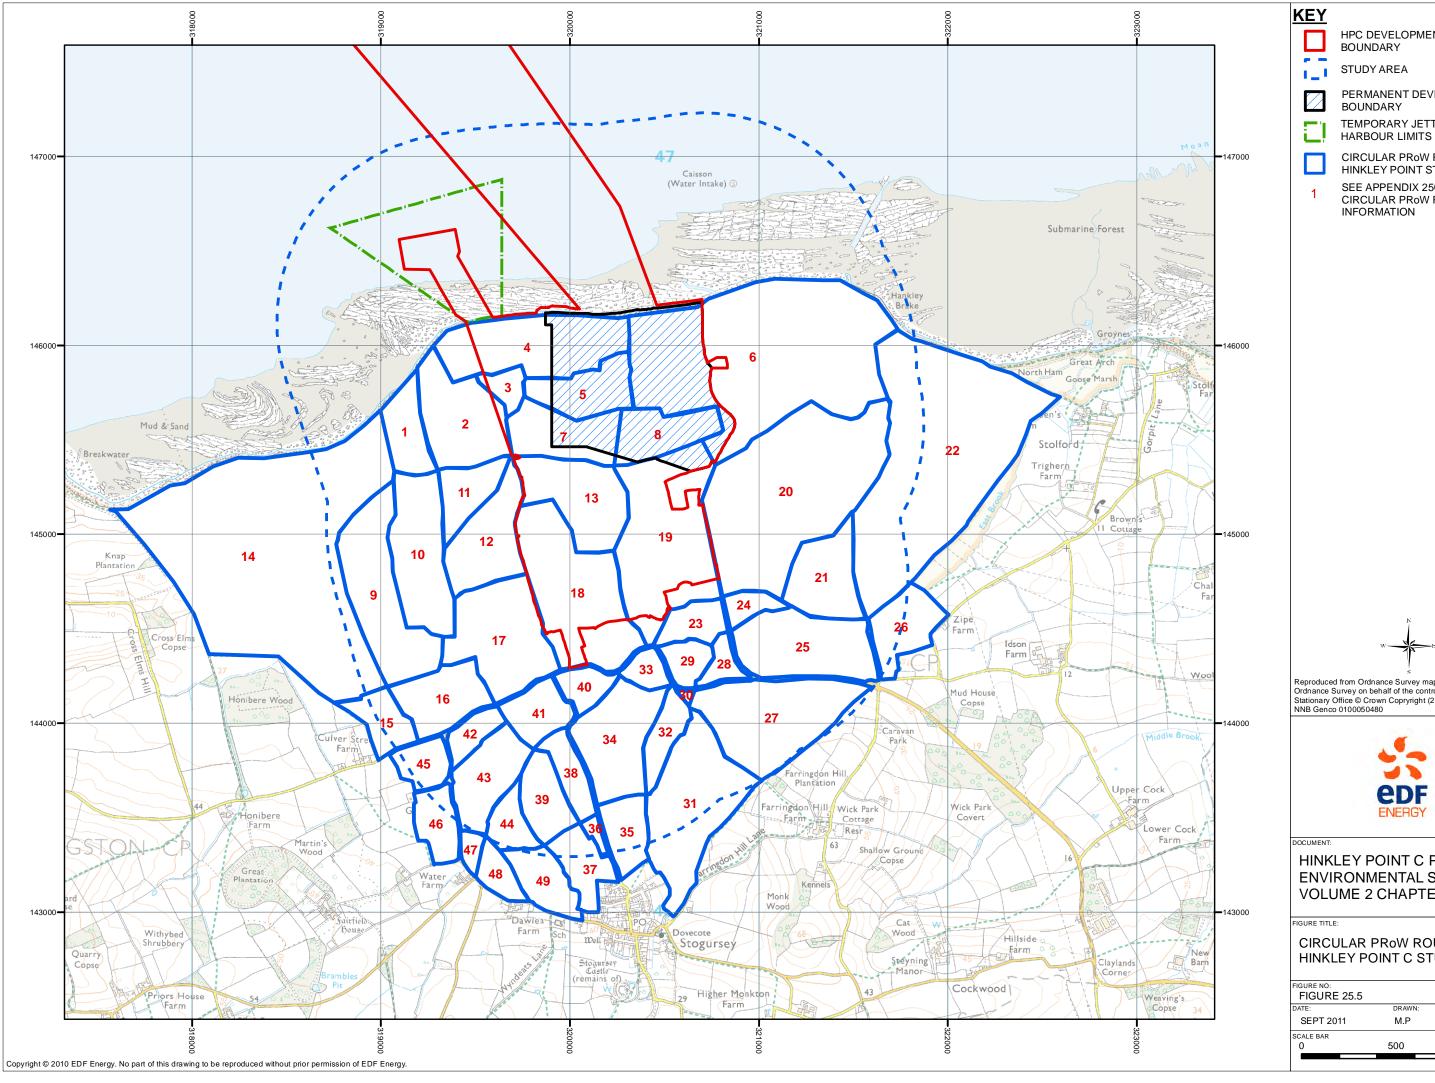
HINKLEY POINT C PROJECT ENVIRONMENTAL STATEMENT VOLUME 2 CHAPTER 25

FIGURE TITLE

WEST SOMERSET COAST PATH COUNTER RESULTS

FIGURE NO: FIGURE 25.4		REVISION: 01
DATE:	DRAWN:	SCALE:
SEPT 2011	M.P	NTS @ A3
SCALE BAR		

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HPC DEVELOPMENT SITE

PERMANENT DEVELOPMENT SITE

TEMPORARY JETTY SEAWARD

CIRCULAR PRoW ROUTES IN THE HINKLEY POINT STUDY AREA

SEE APPENDIX 25C FOR CIRCULAR PROW ROUTE



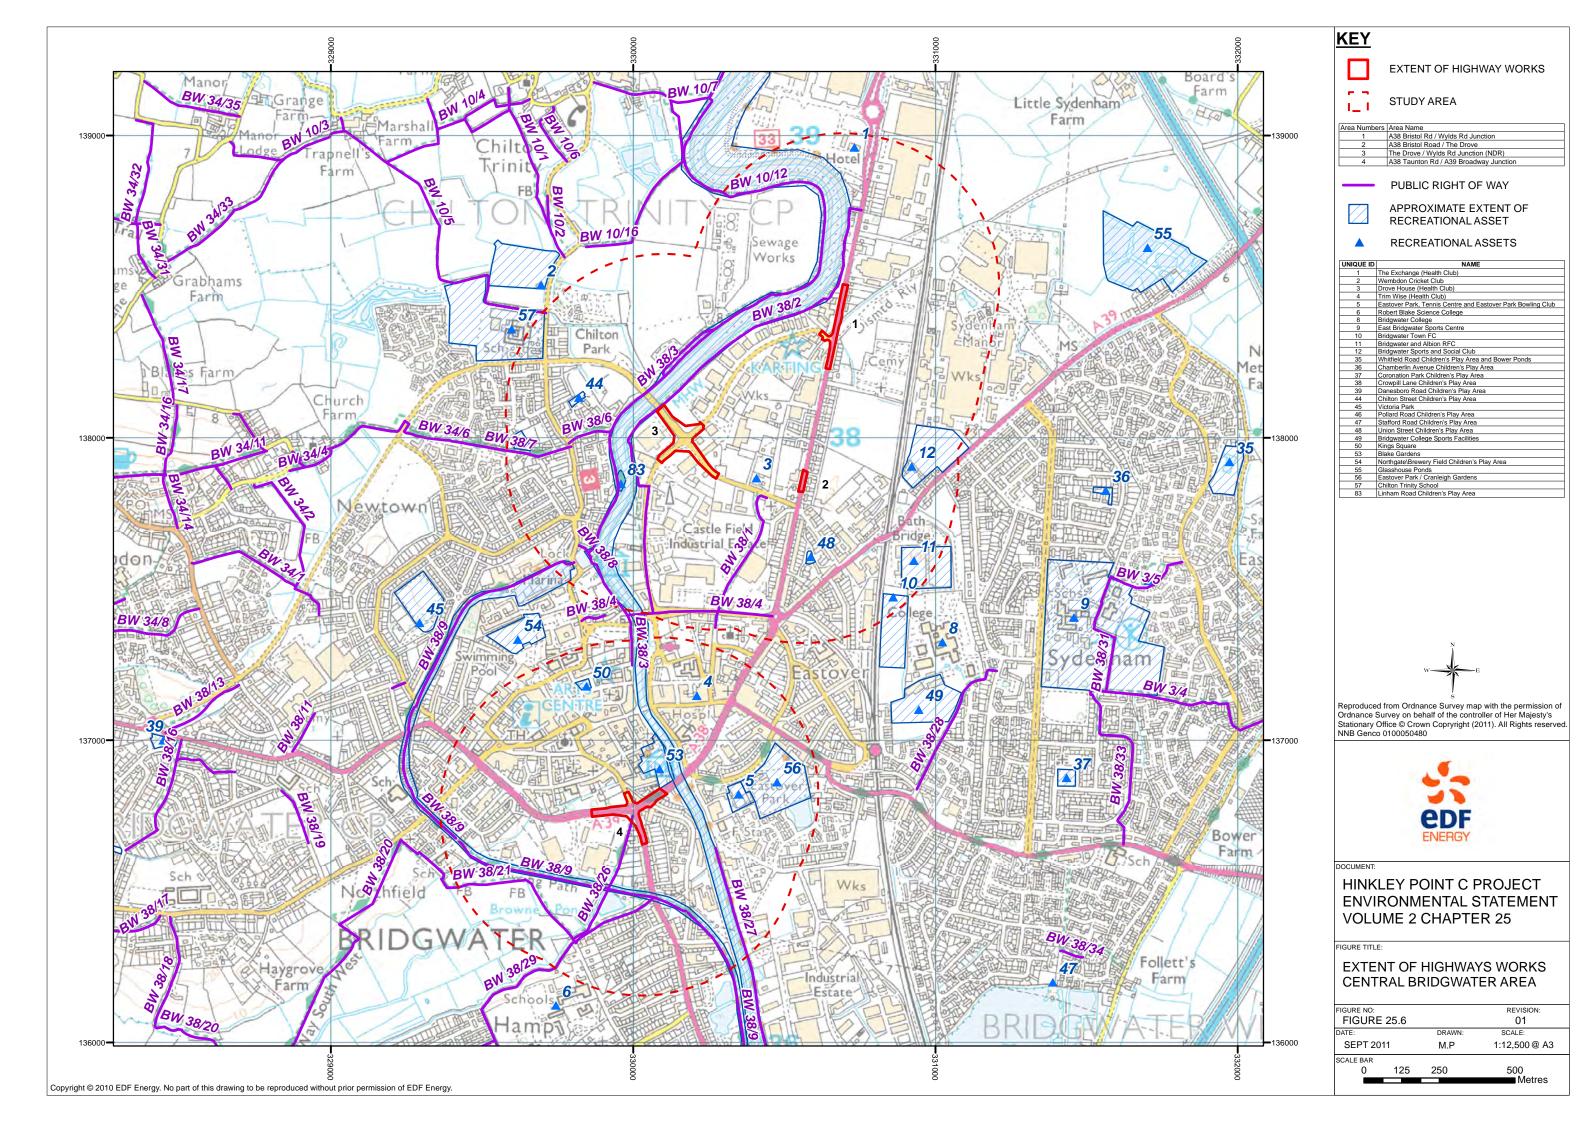
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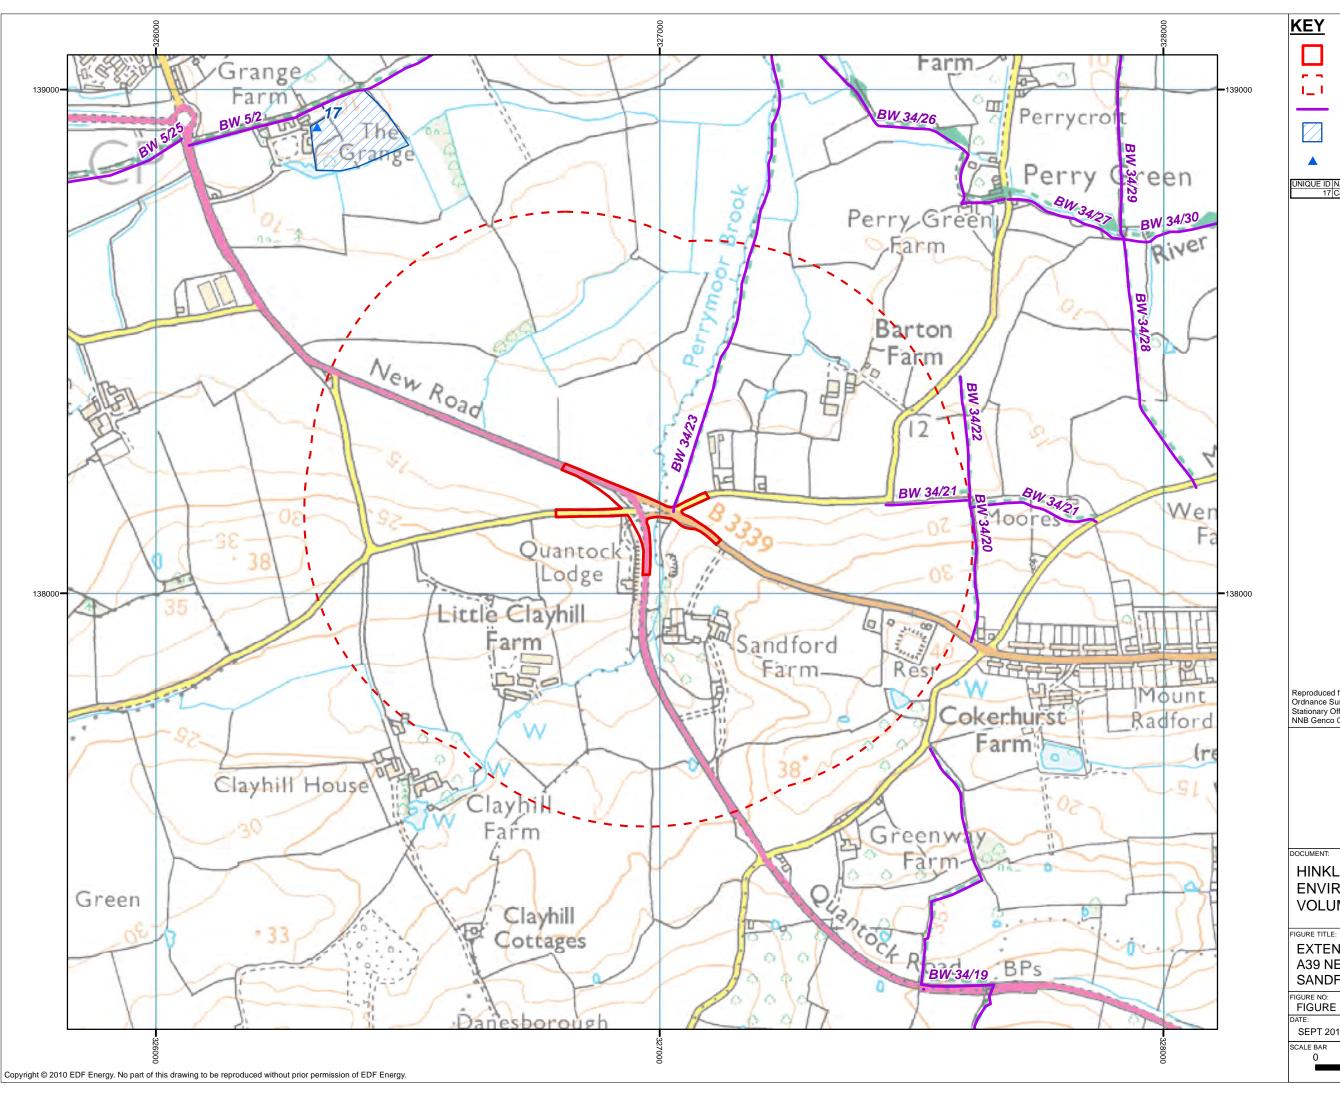


HINKLEY POINT C PROJECT **ENVIRONMENTAL STATEMENT VOLUME 2 CHAPTER 25**

CIRCULAR PROW ROUTES IN THE HINKLEY POINT C STUDY AREA

FIGURE NO: FIGURE 25.5		REVISION: 01
DATE:	DRAWN:	SCALE:
SEPT 2011	M.P	1:20,000 @ A3
SCALE BAR		
0	500	1,000





EXTENT OF HIGHWAY WORKS

STUDY AREA

PUBLIC RIGHT OF WAY APPROXIMATE EXTENT OF RECREATIONAL ASSET



RECREATIONAL ASSETS



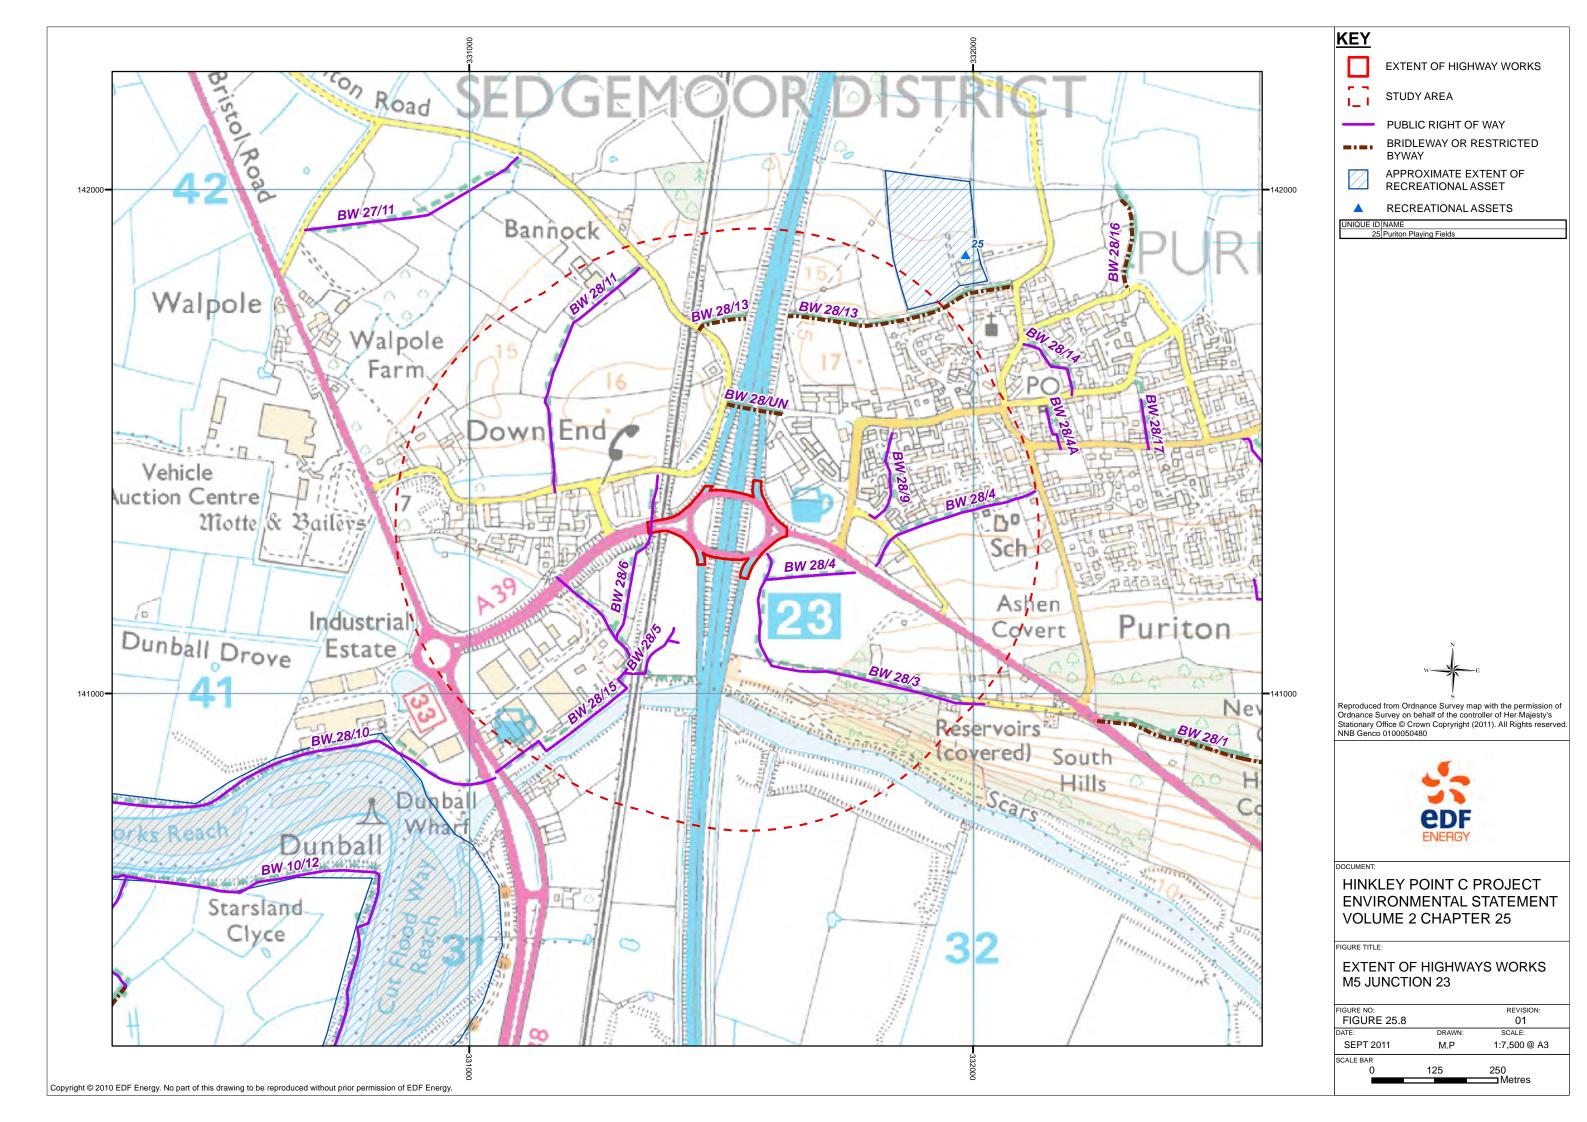
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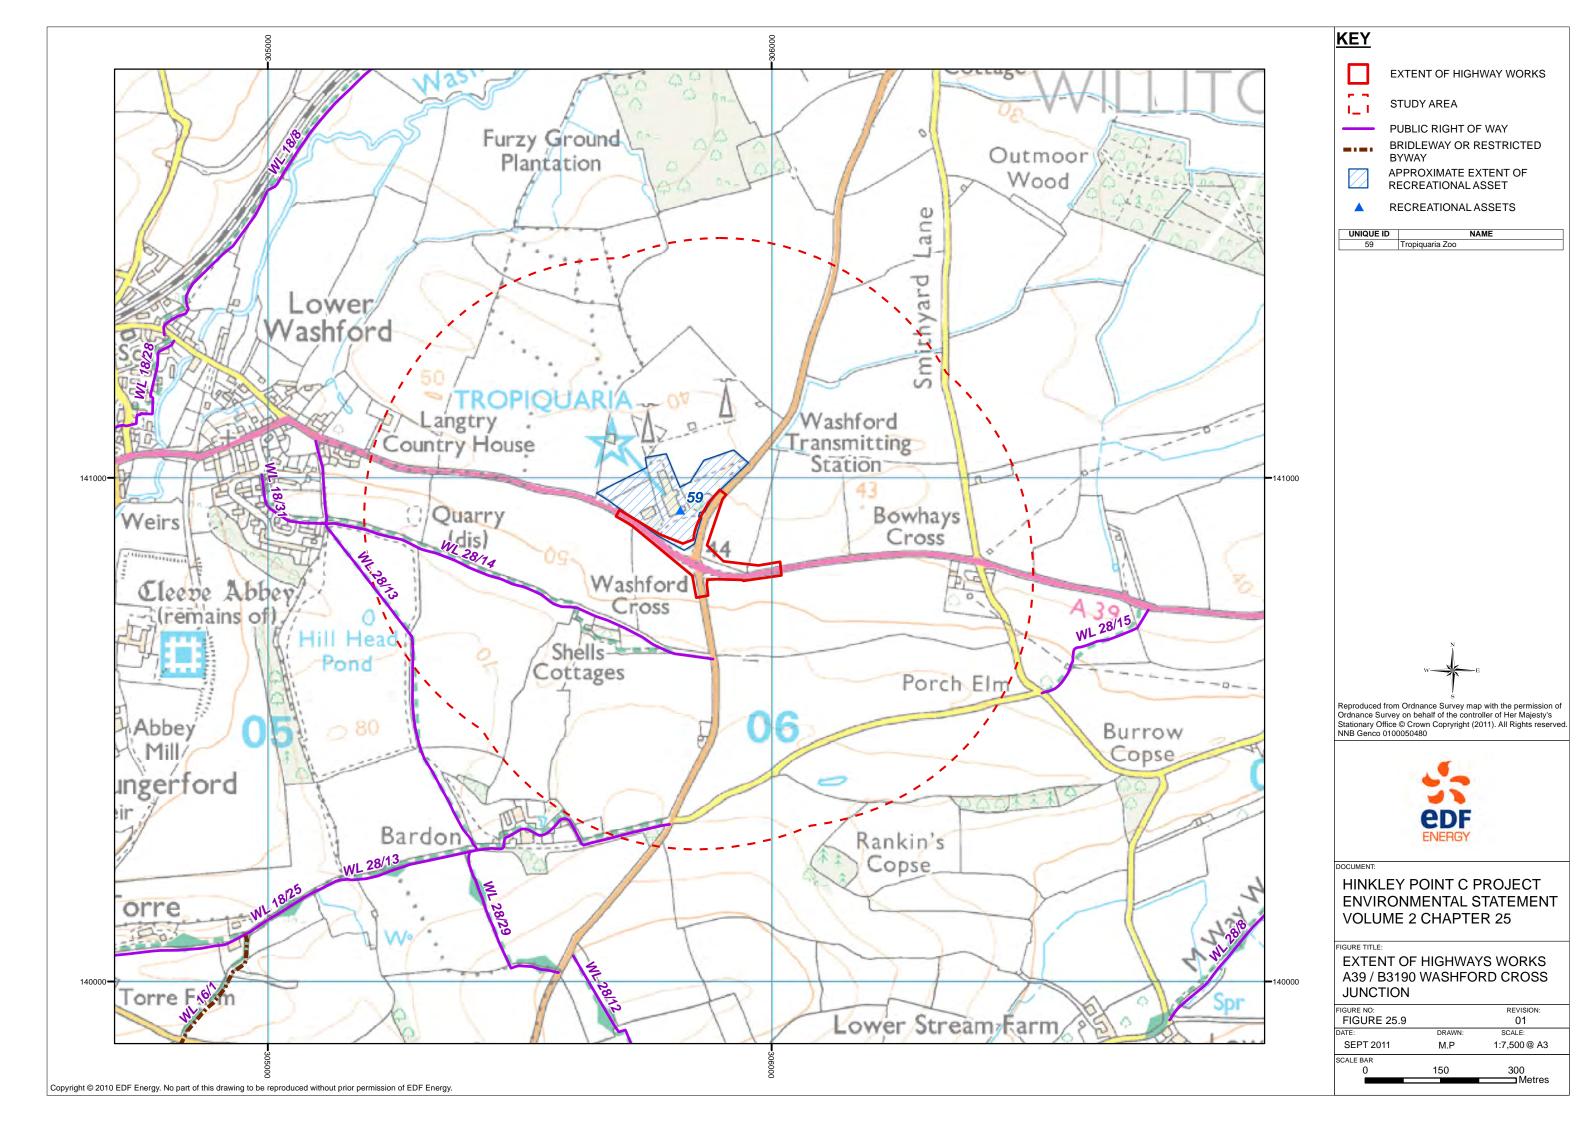



HINKLEY POINT C PROJECT **ENVIRONMENTAL STATEMENT VOLUME 2 CHAPTER 25**


EXTENT OF HIGHWAYS WORKS A39 NEW ROAD / B3339 SANDFORD HILL ROUNDABOUT


FIGURE NO:		REVISION:
FIGURE 25.7		01
DATE:	DRAWN:	SCALE:
SEPT 2011	M.P	1:7,500 @ A3
SCALE BAR		
0	150	300 Motros





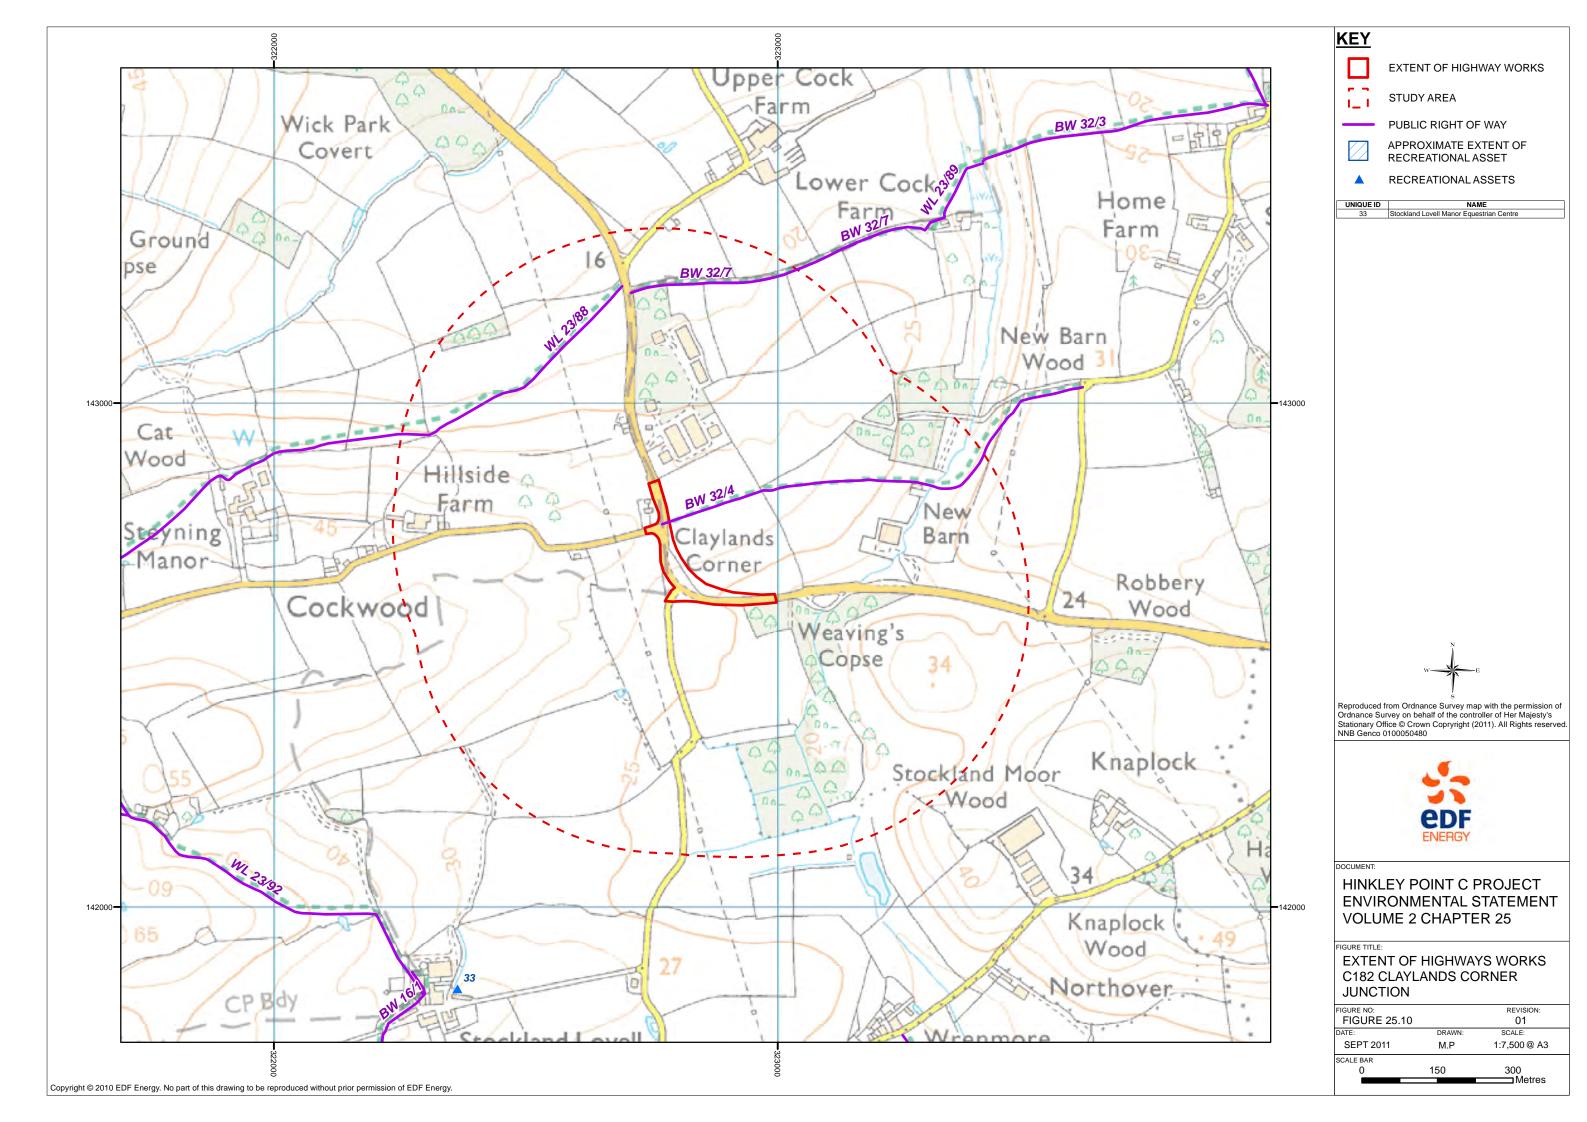


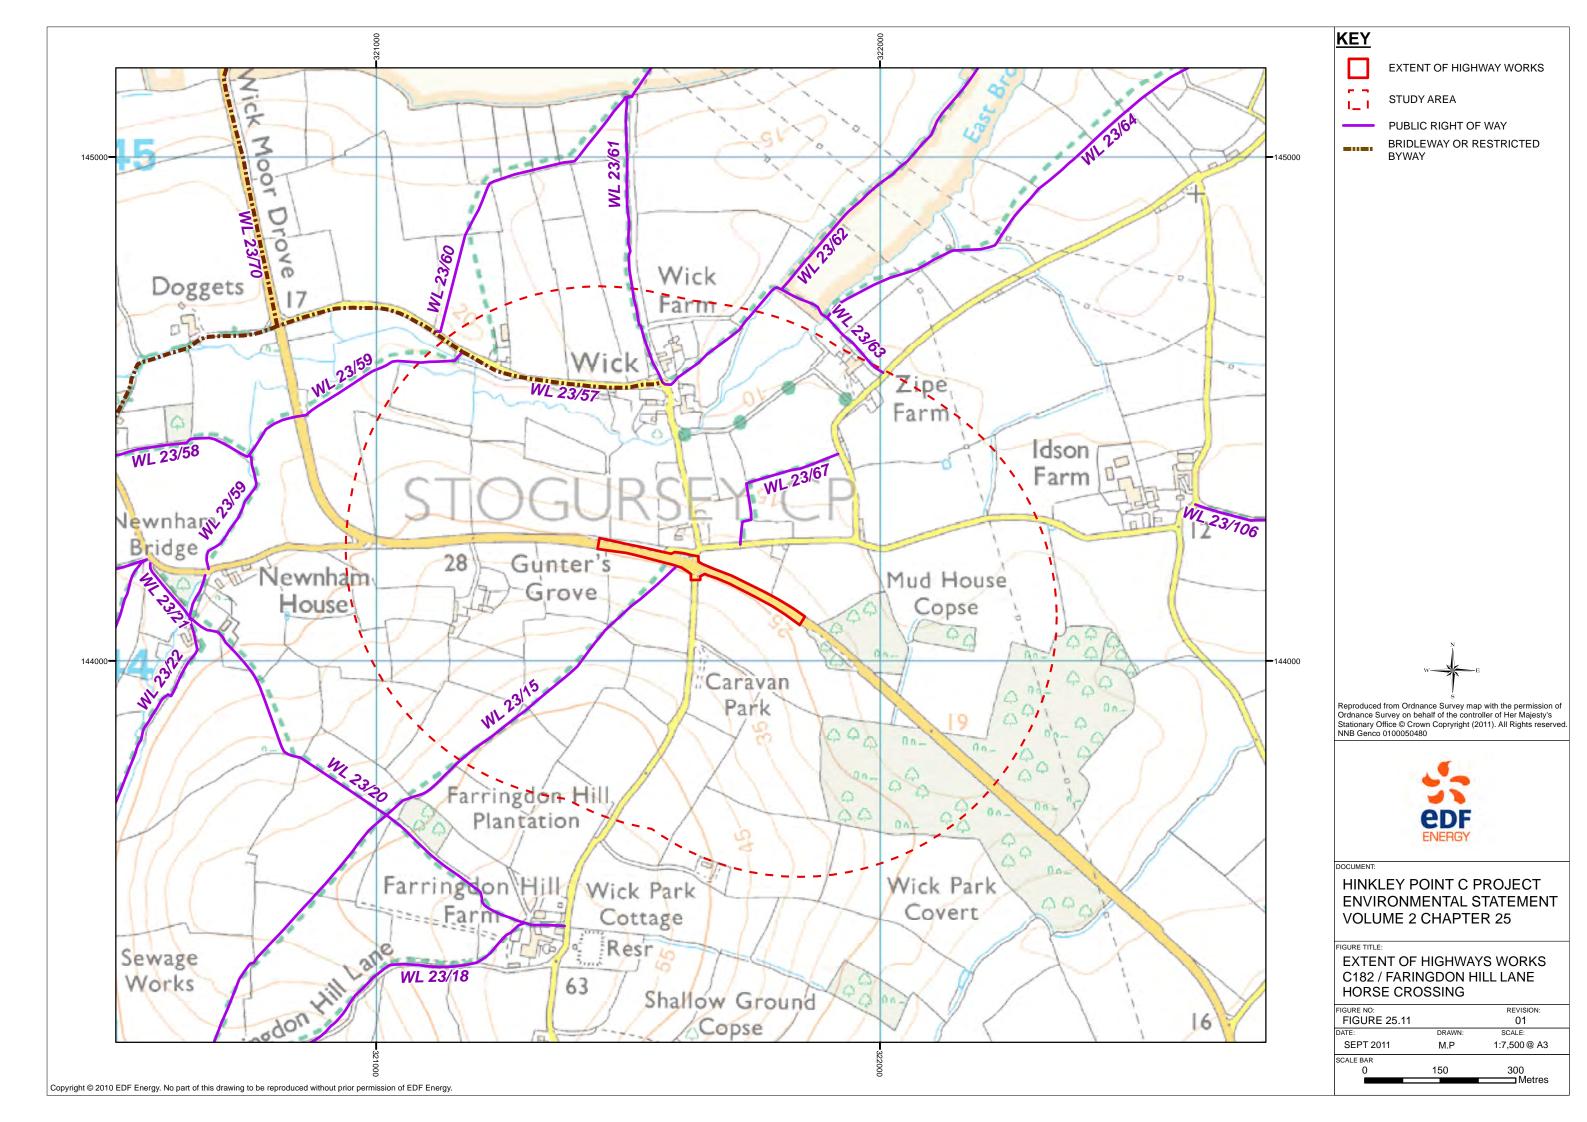

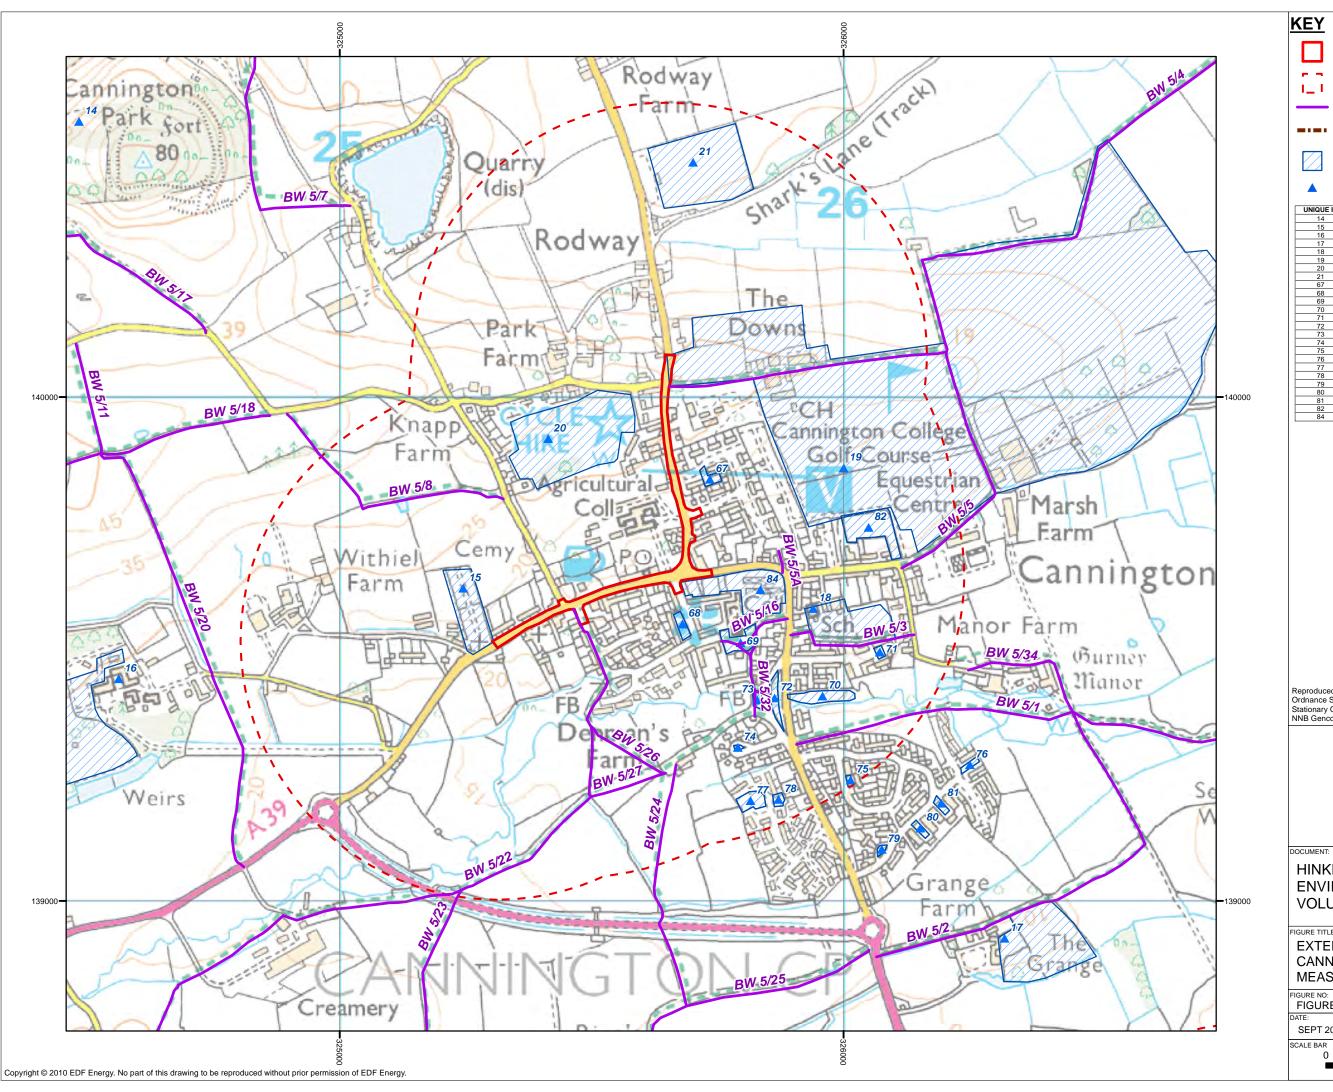

EXTENT OF HIGHWAY WORKS

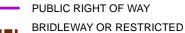STUDY AREA





APPROXIMATE EXTENT OF RECREATIONAL ASSET



RECREATIONAL ASSETS

UNIQUE ID	NAME
14	Cannington Park
15	Cannington Cemetery
16	Brymore School
17	Cannington Grange
18	Cannington C of E Primary School
19	Golf Course & Equestrian Centre (Bridgwater College)
20	Playing Field (Bridgwater College)
21	Sports Pitch (Shark's Lane)
67	Folly Close Amenity Grassland
68	Church Street Amenity Grassland
69	St Mary the Virgin Churchyard
70	Cannington Bridge Children's Play Area
71	Duke Avenue Amenity Grassland
72	Brook Street Amenity Grassland
73	Denmans Lane Amenity Grassland
74	Teals Acre Amenity Grassland
75	Rydon Crescent Amenity Grassland
76	Southbrook Crescent Amenity Grassland
77	Oak Tree Way West Amenity Grassland
78	Oak Tree Way East Amenity Grassland
79	Southbrook Close Amenity Grassland
80	Lonsdale Road West Amenity Grassland
81	Lonsdale Road East Amenity Grassland
82	East Street Allotments
84	Cannington Walled Garden



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HINKLEY POINT C PROJECT **ENVIRONMENTAL STATEMENT VOLUME 2 CHAPTER 25**

EXTENT OF HIGHWAYS WORKS CANNINGTON TRAFFIC CALMING MEASURES

FIGURE NO:		REVISION:	
FIGURE 25.1:	2	01	
DATE:	DRAWN:	SCALE:	
SEPT 2011	M.P	1:7,500 @ A3	
SCALE BAR			
0	125	250	
		Metres	

